





FLOOR PLAN (PROP. GARAGE) SCALE: 1/4" = 1'-0"

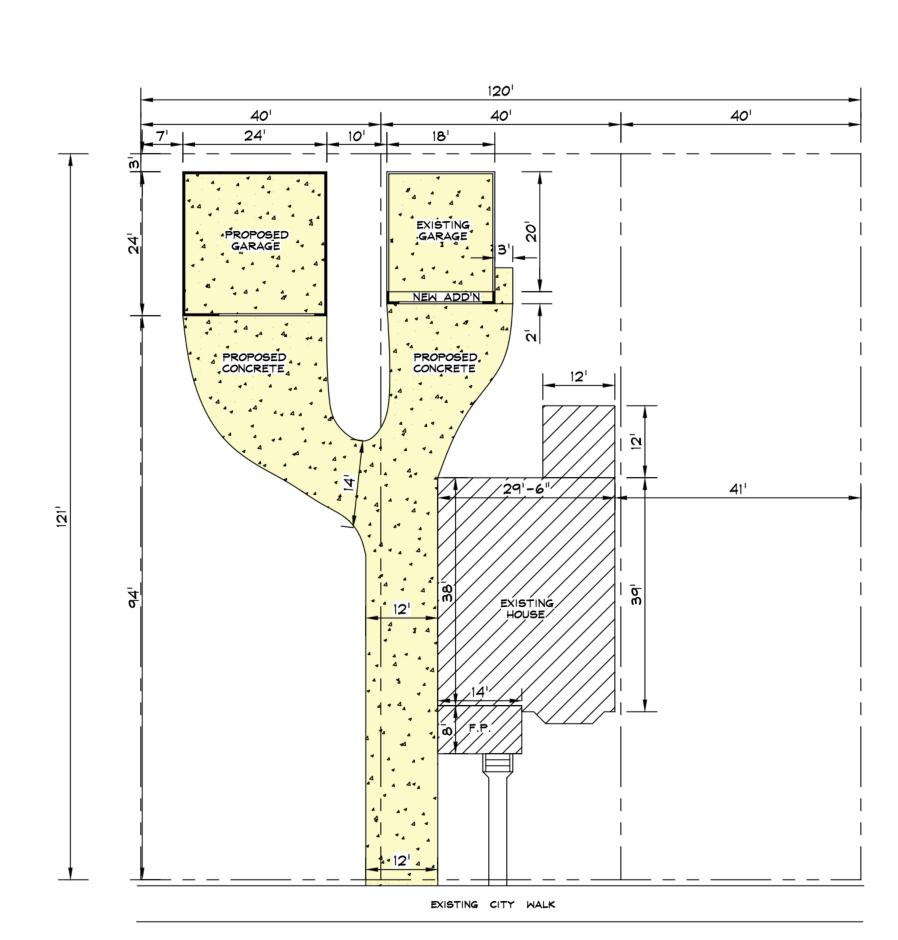

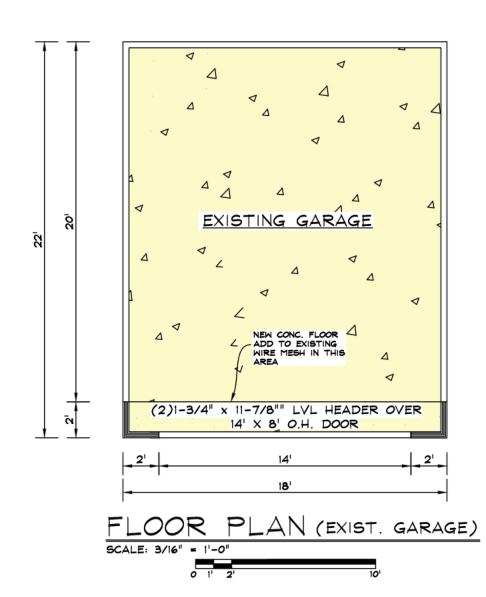

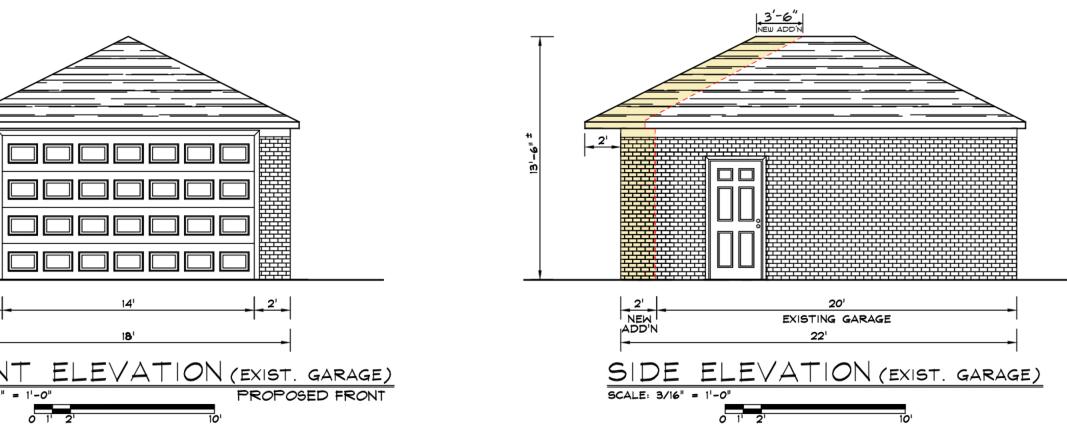



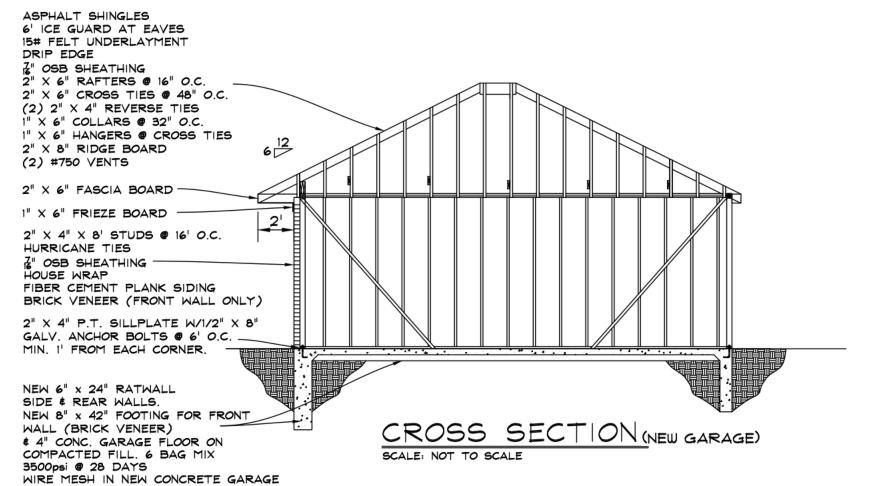

FLOOR AREA.

GENERAL NOTES

THESE PLANS ARE PROTECTED BY COPYRIGHT AND ARE NOT TO BE REPRODUCED WITHOUT THE APPLICABLE BUILDING CODES ARE AS FOLLOWS
-MICHIGAN RESIDENTIAL BUILDING CODE 2015 -CITY OF DETROIT BUILDING CODE -CITY OF DETROIT ZONING CODE

PRIOR TO THE START OF CONSTRUCTION, THE LICENSED CONTRACTOR SHALL OBTAIN ALL NECESSARY PERMITS FOR WORK TO COMMENCE

ALL FEDERAL, STATE, AND LOCAL CODES SHALL BE CONSIDERED A PART OF THE SPECIFICATIONS OF THE BUILDING AND SHOULD BE ADHERED TO EVEN IF THEY ARE IN CONFLICT WITH THIS DOCUMENT

GENERAL SITE NOTES

- IT SHALL BE THE RESPONSIBILITY OF THE PERMIT HOLDER TO LOCATE ALL TREES AND VERIFY ALL EXISTING GRADE LEVELS
- IT SHALL BE THE RESPONSIBILITY OF THE CONTRACTOR TO LOCATE ALL SITE UTILITIES PRIOR TO OR DURING CONSTRUCTION AND THE HOMEOWNER SHALL BE RESPONSIBLE FOR EXISTING AND FUTURE SPRINKLER HEADS

CONSTRUCTION NOTES

DRAWING PAGES WILL BE SCALED ON EITHER, (24" X 36") OR (11" X 17") PAPER AND PRESERVE PROPER FORMATTING \$ DOOR SIZES ARE INDICATED IN DRAWINGS NOMINALLY AND IT WILL BE THE RESPONSIBILITY OF THE CONTRACTOR TO PROVIDE ROUGH OPENINGS BASED ON THE DOOR MANUFACTURER'S SPECIFICATIONS

BRACE ALL EXTERIOR CORNERS OF STUD WALLS WITH METAL STRAP BRACING LET INTO STUDS ON 45 DEGREE DIAGONALS FROM PLATE TO PLATE ALL RAFTER TAILS TO RECEIVE GALV. HURRICANE STRAPS AT WALL TOP PLATES TO PREVENT WIND UPLIFT

FDTN. \$ CONC. NOTES

- ALL DIMENSIONS ARE CALCULATED FROM OUTSIDE FACE OF MASONRY TO OUTSIDE FACE OF MASONRY.
- FROST DEPTH IS ASSUMED TO BE 42" BELOW GRADE. COMPRESSIVE STRENGTH OF CONCRETE TO MEET OR EXCEED THE REG'S OF UNDER THE CATEGORY OF SEVERE IMPORTEMENTALAGEOR WEATHERING.
- FOOTINGS SHALL REST ON UNDISTURBED SOIL AND CONTRACTOR SHALL VERIFY SOIL IS FREE OF LOOSE DEBRIS AND WATER PRIOR TO POURING OF CONCRETE.
- CONTRACTOR TO BE AWARE OF EXISTING FOUNDATIONS AND PREVENT AGAINST OVER EXCAVATION BELOW EXISTING FDTN. BEARING LINE UNLESS OTHERWISE INDICATED. A MIN. 2" THICK BASE COURSE SHALL BE PLACED ON THE PREPARED SUB-GRADE WHERE THE SLAB IS BELOW GRADE EXCEPT WHEN THE SUB-GRADE FALLS WITHIN THE CLASSIFICATION OF GROUP 1 OF MRC TABLE R405.1
- ON ATTACHED GARAGE PER MRC R506.23, A 6 MIL THICK VAPOR RETARDER (OR BETTER) WITH MIN. 6" JOINT LAPPING SHALL BE PLACED BETWEEN THE CONCRETE

FLOOR SLAB AND BASE WHERE APPLICABLE.

BREAK OUT EXISTING GARAGE FLOOR, DRIVEWAY AND APPROACH.

INSTALL NEW CONCRETE FOR BOTH GARAGE FLOORS, DRIVEWAY AND APPROACH. SEE PLOT PLAN.

EXISTING GARAGE:

CONTRACT NOTES

REMOVE EXISTING GARAGE DOOR AND SAVE. REMOVE BRICK FROM REAR WALL OF EXISTING GARAGE TO USE FOR THE FRONT ADDITION.

INSTALL 8" \times 42" CONCRETE FOOTING FOR 18' \times 2' GARAGE ADDITION. PIN TO EXISTING FOOTING.

REMOVE WOOD TRIM AROUND O.H. GARAGE DOOR

BUILD 18' X 2' ADDITION TO FRONT OF EXISTING DETACHED GARAGE WITH 2'-0" FRONT OVERHANG. EXISTING GARAGE ROOF WILL BE BUILT OUT 3'-6" TO ACCOMDATE THE 2' O.H.

REUSE EXISTING O.H. GARAGE DOOR ON EXISTING GARAGE. REUSE BRICK FROM REAR OF EXISTING GARAGE FOR NEW ADDITION. INSTALL NEW BRICK AT REAR WALL OF GARAGE TO MATCH EXISTING AS CLOSE AS POSSIBLE.

PROPOSED GARAGE:

INSTALL NEW 8" \times 42" FOOTING FOR FRONT BRICK VENEEER WALL. INSTALL 8" \times 24" RATWALL FOR SIDE WALLS AND REAR WALL.

BUILD NEW 24' X 24' DETACHED WOOD FRAME GARAGE - 2'-0" FRONT OVERHANG HIP ROOF - 6/12 PITCH - 8' WALLS.

INSTALL 16' X 8' SHORT PANEL O.H. DOOR - COLOR: WHITE

INSTALL 1/2 H.P. GARAGE DOOR OPENEER W/ (2) REMOTES \$ EMERGENCY KEY REPLEASE.

SIDING: FIBER CEMENT PLANK SIDING - COLOR: PRIMED

FIBER CEMENT TRIM - COLOR: PRIMED PERF. VINYL SOFFIT - COLOR: PRIMED

6" ALUM. GUTTERS - COLOR: BROWN (MATCH HOUSE) W/LEAF RELEAF

ROOFING: LANDMARK DIMENSIONAL SHINGLES - COLOR: BURNT SIENNA (2) #150 ROOF VENTS - COLOR: BROWN

INSTALL 6' ICE GUARD AT EAVES DRIP EDGE - COLOR: BROWN

ELECTRICAL: N/A - BY OWNER

QUALITY BUILDING & REMODELING ITALY **AMERICAN** CONSTRUCTION 1-877-98-ITALY **FAMILY OWNED SINCE 1954**

SHEET INDEX DESCRIPTION

GENERAL NOTES SITE SURVEY GARAGE FLOOR PLAN SECTION ELEVATIONS

SET ISSUE DATES

DATE: ISSUE:

APPLY FOR PERMIT REVISED 03/06/24

SHEET NOTES REF: NOTES:

> DRAWN BY: RM CHECKED BY:

SHEET No.

PAGE 1 OF 1

PROJECT No. TG 2303

01/04/2024 DATE CREATED:

