

Detroit Water and Sewerage Department Engineering Services Group

DWSD
Drafting / CAD Standards
(VERSION 3)

Engineering Technology Team

November 2020

TABLE OF CONTENTS

Section	1							
1.0	Introduction							
1.1	What's Available On-line1							
Section	2							
2.1	CADD Guidelines2							
2.2	File Naming Conventions							
2.3	Assigning File Names							
2.4	External Reference Files							
2.5	Layer Naming Conventions4							
2.6	Text and General Annotation4							
2.7	Abbreviations and Spelling4							
2.8	Dimensions5							
2.9	Units6							
2.10	Line Types6							
2.11	Drawing Setup and Scales							
2.12	Plotting7							
2.13	Electronic Deliverables							
2.14	Quality Control							
2.15	Conclusion8							
Append	dix A - DWSD Standard Title Blocks							
Standar	rd Title Block Sizes							
Append	Appendix B - DWSD Sample Project Drawings							
Project	Drawing ListB-1							

Section 1

1.0 Introduction

(DWSD) has established this Policy Manual of computer-aided design and drafting (CADD) standards (DWSD CADD Standards) for use by contractors and subcontractors/sub-consultants (hereinafter collectively referred to as subcontractor or subcontractors) that work on DWSD projects. Each subcontractor agrees to use the DWSD CADD Standards based on AutoCAD (version 2018 or later) to execute work and to follow the requirements set forth in the applicable contractor agreement. It is understood that exceptions and deviations from this Policy Manual or the DWSD CADD Standards may be necessary and desirable for some projects. The DWSD Engineering Department or the DWSD CADD Manager for that specific project shall approve any such exceptions or deviations and any such approval shall be in writing.

This Policy Manual and all documents and data files are the property of DWSD. The Policy Manual, documents and files are furnished for use solely in connection with work performed for a specific DWSD project and permission is granted only for such use. Contractor agrees not to permit third parties to copy or use Policy Manual or any document or file for any other purpose.

DWSD will provide contractors with appropriate CADD related layering guidelines, drawing templates including AutoCAD layers, general graphic drafting symbols, and appropriate project borders and title block information developed by DWSD. This material is supplied as an aid in conformance to DWSD CADD Standards and to enhance efficiency when placing DWSD standard symbology. In addition, plotter settings, standard text styles, and Sheet Number Structure will be provided to assist in placing information in the correct manner and structure.

Limited direct CADD support services are available to the subcontractor. If specifically directed by a DWSD Project Manager, consulting support will be made available and these services will be charged to the project. Contractors should contact the DWSD Project Manager for technical support information.

The CADD instructions contained herein are for use on DWSD projects only. This manual is always to be followed, with no exceptions. Permission must be granted specifically from DWSD in order to deviate from these standards. This manual may be revised at any time due to changing conditions/project requirements.

1.1 What's Available On-line

The postings are provided and updated on DWSD website. The address to the website is provided by DWSD Project Manager, and the postings online to the website are:

- AutoCAD Templates (.dwt) Used for creating NEW drawings:
 - 1. Survey Base Plan
 - 2. Proposed Water Main Design Plan
 - 3. Proposed Sewer Design Plan
- AutoCAD line type template file
- Plotting configuration files for plotting per DWSD standards.
- Utility Legend and Keyed Notes.

Section 2

2.1 CADD Guidelines

- ALL Model space entities to be drawn FULL scale unless noted otherwise.
- Dimensions should be associative and NOT exploded.
- ALL External references should be "OVERLAYED".
- ALL Model space entities to be created "Bylayer" and not color or line type specific.
- Do not place entities on layer '0".
- Use DWSD Standard symbols provided in template files.
- DWSD text and Dimension styles should be used without exception.
- Use Templates provided for creating new Drawings.

2.2 File Naming Conventions

Drawing files supplied to DWSD by the contractor should be named in accordance with the rules set out in this section.

All drawing file names must be assigned in a logical and consistent manner so any user may access the files as required. CADD user should be assigned the responsibility of maintaining consistent individual directories for each project, cataloging file names used, and verifying that the names used are consistent with these standards.

2.3 Assigning File Names

The name of a drawing file must avoid duplication within any specific project. The file naming convention has four fields. The first field is a single character representing the Discipline Designator, civil (C) or survey (V). The second field represents the category (utilities, survey, water, sewer, restoration, etc.) The third field represents the file type (Model or Sheet file). The final field identifies the location of the work represented in the drawing file, which can include Section number, neighborhood name, street name or another descriptive identifier. All fields shall be separated by a hyphen.

Example:

V-UTIL-MODEL-AREANAME.dwg V-SURV-MODEL-AREANAME.dwg C-WTR-MODEL-LOCATION.dwg C-SWR-MODEL-LOCATION.dwg C-WTR-SHEET-LOCATION.dwg C-SWR-SHEET-LOCATION.dwg

Where external references are used, they should be included and noted. Any shape or font files, (.SHP or .SHX) that is used to create the drawing must be transmitted to DWSD along with the file. It is the responsibility of the contractor to provide DWSD with any necessary files and copyrights.

Sheet file will contain layouts for sheets and sheet numbers will be assigned utilizing the following system:

Example:

G-00 General drawings

WM-00 Water main replacement drawings

WL-00 Water main lining drawings
WMR-00 Water main restoration drawings
S-00 Sewer replacement drawings

P&MH-00 Pipe and manhole rehabilitation repairs

O&M-00 O&M pipe and manhole rehabilitation repairs

SR-00 Sewer restoration

L-00 Green Storm Sewer infrastructure

R-00 Tree planting
TP-00 Traffic plan
SD-00 Standard Details

Upon completion, all contract drawings are sealed by the responsible Professional Engineer or Architect in accordance with State licensing regulations.

Signatures and registration seals shall be on G-01 INDEX sheet before prints are ordered for bidders.

Record drawings normally do not require signatures or seals.

Upon completion of construction, the contractor shall issue to DWSD a set of plans with construction notes and changes as done in the field. Drawings to be submitted electronically.

Upon completion of all work, the words "as built" will be inserted in the revision block of every sheet in the contract. In addition to this, the words "record drawing" will be stamped on the cover sheet, in the center of the sheet if possible. Unless contractually obligated otherwise, a set of PDF drawings are then produced for the client files with the original drawings retained by DWSD.

2.4 External Reference Files

AutoCAD supports External Reference files using the "XREF" command. It permits a user to "refer" to and use a drawing file created by another discipline. When properly applied, this feature can reduce drawing production cost and eliminate some of the inter-discipline coordination required during a project.

It is beyond the scope of this document to provide detailed instructions and descriptions of all the various possibilities. Large multi-discipline projects almost always need a dedicated coordinator to resolve the common pitfalls. This dedicated coordinator should act as a file supervisor and file manager to ensure that duplicate work efforts are reduced using reference files.

Specific layers are provided within the DWSD sample drawing templates for External Reference files. (Provided by DWSD on Web site) Please use these layers when attaching Xref's.

Example: layer **R-XREF-SURV** for survey, layer **R-XREF-WTR** for water main etc.

2.5 Layer Naming Conventions

Subcontractor MUST use the standard DWSD CADD layering convention based on the National Cad Standards with some variations for DWSD specifics when developing drawings. The layering convention, however, does allow each discipline to customize layers depending on how drawing entities need to be organized. All operators must follow the layer system designated by DWSD standards, and the DWSD Engineering Department, where required, will decide upon special customized needs, for all drawings produced on a specific project. The layering convention is based on AIA and National Cad Standards CADD Layer Guidelines — Computer-Aided Design Management Techniques for Architecture, Engineering, and Facility Management. Layer names can be found in template drawings.

2.6 Text and General Annotation

All text input into a CADD drawing file must follow the standards described in this Section. DWSD practice is to use text styles normally used in the drawing production that will be automatically created at sizes based on the DIMSCALE dimensioning variable in paper space mode.

Styles are to be defined with a fixed height and width factor of 1.00 based on paper space. This will cover most drafting needs and, when the sizes are modified to match the plotting scale.

To be consistent with general DWSD standards, all proposed text, dimensions, general notes and title block text shall be in style 'DWSD Proposed', Existing labels and dimensions shall use 'DWSD Existing'. All general notes should be placed in a layer with a modifier of ANNO. Text styles can be found in template drawings.

When text is part of the symbology for a line, such as the property line or centerline designation, it must be on the layer associated with that line, not a text layer. The color/pen weight should also be explicitly assigned so that the text will be readable on the final plot.

Use Arial type font titles and 0.3 lettering for main titles.

Example:

Title captions are underlined and are used under large views

<u>Plan View, Profile View</u>

2.7 Abbreviations and Spelling

All applicable abbreviations can be found on the attached plan sheets.

Always utilize abbreviations listed unless client requirements dictate otherwise.

Abbreviate words only when space is limited and only words that appear in the abbreviation legend.

Include periods when abbreviating example: ex.

Always check spelling of doubtful words with reference to the dictionary.

2.8 Dimensions

Dimension styles can be found in template files.

Dimensions are set to Annotative scale with a Dimscale of "0".

Duplicate dimensions should be avoided. When a revision is made there is a danger of one dimension being altered and not the other.

Dimensions should be given from a base line or a finished surface that can be readily established. Dimensioning from a center line should be avoided if possible, except with pumps, piping and diverters.

The use of the drawings should determine whether decimal (normally used) or fractional dimensions are to be used. When using the decimal, usually one or two place decimals will be adequate. Where decimal dimensions are used, place a leading digit before the decimal point for clarity.

Dimension lines should be terminated by cad produced arrowheads. The arrowhead should touch the object pointing to but don't overrun the object.

The leader is a straight line leading from dimension view, note, or nomenclature to the view on the drawing to which it applies. The leader should always touch the part referred to and terminate with an arrowhead. When the leader is leading from a note or nomenclature, it should begin at the first or last word of the note or nomenclature.

Dimension lines should be kept outside the view or outline of the part. The distance that lines are placed from the object depends upon the scale of the drawing and the space available.

Dimensions should be placed directly in the middle between the dimension line and above, midway between the arrowheads. Where space does not permit this, the dimension may be placed outside the extension lines on the line, or above the line and a leader line used.

Enough dimensions should be used to give adequate information so that it will not be necessary for those using the drawings to make calculations to determine size of location.

Avoid crossing dimension lines with extension lines or leaders wherever possible. If unavoidable, break the extension line of the least important dimension.

A dimension indicating a diameter, or hole, has DIA. after the dimension specified DRILL, BORE, etc.

The dimension of a radius should be placed between the radius line and between the arrowhead and the center of the radius wherever possible and should be followed by the letter R. On large radii or circles where it is impractical to show the full dimension lines, only part need be shown, or labeling the radius along the center line of the arc is permissible.

Add letters NTS (Not to Scale) adjacent to the appropriate dimension or directly under views sections or detail title that have dimensions that are not to scale.

2.9 Units

All civil work, including piping, site plans, and grading plans must be worked on in AutoCAD's decimal units, with the drawing unit understood as being one foot.

Angular units will need to be set as required by the needs of the individual drawing; however, zero degrees should always remain to the right. Angular precision will be left to the operator's discretion. Note that this setting only affects the way the number is displayed, not what is stored in the database, stored internally within the Drawing Database.

2.10 Line Types

All used line types are provided in the DSWD.lin line type definition file. (Provided by DWSD on Web site)

For consistency, all drawings will have an LTSCALE set to drawing scale, System Variable to be turned on, MSLSCALE=1, PSLSCALE=1. The "PSLTSCALE" variable must be set to 1 at all times to ensure that line types look consistent in view ports having different scales.

2.11 Drawing Setup and Scales

Refer to CADD layering guidelines section for appropriate layer on which the border should reside. This block will have all required drawing attribute information necessary for your specific project. This block should NOT be exploded for any reason. Refer to "Sheet Borders and Title Block info" within this document to obtain the correct Sheet border/Logo etc.

All plans, sections and details of structures shall be drawn full scale (1=1) in "Model Space or reference files". For example, a line drawn using AutoCAD showing the 200' long pipe should be measured 200' in reference drawing.

The Title Block File is also drawn at a scale of 1:1.

The scales shall be set to clearly show the necessary details. Keep in mind half size drawing reproduction.

The following scales are to be used on the types of drawings noted below:

Water Main and Sewer Replacement Plan and Profile Sheets:

Plan View:

1" = 40'

Profile View:
Horizontal – 1"=40'
Vertical – 1"=4'

Water Main Lining Sheets:

1" =40'

Water Main and Sewer Restoration Sheets:

1" =40'

All plan drawings coordinate systems shall be set to NAD83 Michigan State Planes, South Zone, International Foot. All vertical elevations shall be in City of Detroit Datum.

The direction North shall be represented on plan sheets as facing upwards or to the left. All construction stationing shall read from left to right on the sheets, directions West to East or North to South.

2.12 Plotting

Plot files will be delivered to DWSD in AutoCAD and PDF format. Settings shall be to a scale and the PDF will print to that scale.

2.13 Electronic Deliverables

When delivering electronic files to DWSD, the following guidelines should be followed:

- USB Flash Memory Drives or Portable Hard Drives are an acceptable method of transferring files. These should be labeled, and a complete list of the included files should also be sent along with the drive.
- A secure private FTP site or third-party file transfer application (Dropbox, OneDrive, etc.) may be used with engineer's approval.
- If files are to be E-mailed, a standard "ZIP" file should first be created of the files. This "ZIP" file can then be E-mailed to the appropriate personnel. All required external references, fonts, etc., should also be delivered along with the electronic drawing files. The maximum file size for this type of deliverable is 20MB. If larger then refer to one of the above methods.

2.14 Quality Control

During the Project Design milestones (60%, 90% and 100%) DWSD may perform a quality audit on pdf submittals received. This is to ensure that the DWSD standards provided are being followed as closely as possible.

Check prints shall be submitted at 30%, 60%, and 90% completion or as required.

The checker will return the marked print to the originator to have the corrections made.

All comments will be transferred to a response log (excel spreadsheet) and responses will be submitted to DWSD and discussed at a review meeting before submitting revised drawings.

DWSD will provide backcheck comments for revised 90% drawings before submitting 100% drawings.

Please refer to the DETROIT WATER AND SEWARAGE DEPARTMENT Capital Improvement Program Management Organization – Program Procedures Manual for additional quality control information.

2.15 Conclusion

This Policy Manual has been established as a guideline to be used when working on DWSD projects. These standards apply to DWSD projects only. The standards should NOT be reproduced or copied in any way without the prior express, written permission of DWSD. This Policy Manual may be updated by DWSD at any time due to changes in AutoCAD Technology or DWSD CAD standards. In the event this occurs, the revised portions will be reprinted and redistributed.

Appendix A

DWSD Standard Title Blocks


The following pages illustrate the standard title blocks used for all DWSD contract documents. Title blocks MUST be used without any modification. Any Deviation requires the permission of the DWSD Project Manager.

Drawings Sizes and Arrangement

•	8.5" x 11"	For details, report figures and joint permit application drawings.
---	------------	--------------------------------------------------------------------

• 11" x 17" For report figures.

• 22" x 34" For construction plan sets.

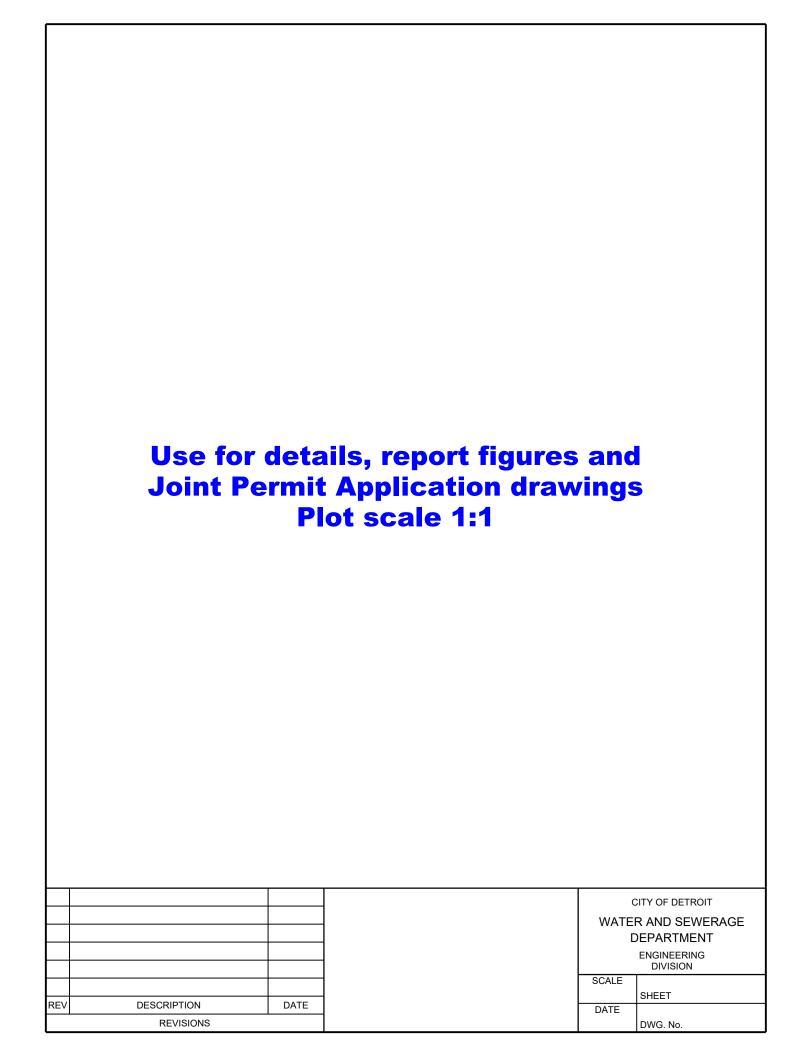

For 11"x17" report figures and half size construction documents use plot scale 1:2

For 22"x34" full size construction documents use plot scale 1:1

F			DESIGNED BY:	SEAL / STAMP	
E			-		CONTRACT NAME
D			DRAWN BY:		
С			CHECKED BY:	-	SHEET TITLE
В			-		OHLL HILL
Α			MANAGER:	-	
	DESCRIPTIONS / REVISIONS CHK'D AP	PPR. DATE	-		

CITY OF DETROIT
DETROIT Water & Sewerage Department

CONSULTANT IDENTIFICATION

CITY OF DETROIT
WATER AND SEWERAGE DEPARTMENT
ENGINEERING DIVISION

RANGE

DETROIT
Water & Sewerage
Department

TOWN

DETROIT RAGE DEPARTMENT IG DIVISION	DRMS. No. CS-XXXX DWSD CONTRACT No. XX-XXX FILE No.
	DRAWING No.
SECTION PORTION CODE	XX-XXX

Appendix B

The following pages represent DWSD contract documents from selected DWSD water main and sewer projects. They are attached for reference purposes only.

Attached Water Main Design Sheets

	COVER SHEET
G-1	INDEX SHEET
G-2	SCHEDULE OF QUANTITIES
G-3	LOCATION MAP
G-4	WATER MAIN INTERVENTIONS MAP
G-5	LEGEND, ABBREVIATIONS AND GENERAL NOTES
G-6	WAYNE COUNTY NOTES
G-7	SOIL EROSION AND SEDIMENTATION CONTROL NOTES, C.E.D. NOTES AND CONTROL POINTS
WM-5	PLAN AND PROFILE SHEET – HORIZONTAL DIRECTIONAL DRILL INSTALLATION
WM-12	PLAN AND PROFILE SHEET – OPEN CUT INSTALLATION
WM-23	PLAN AND PROFILE SHEET – PIPE BURST INSTALLATION
WMR-5	RESTORATION SHEET - HORIZONTAL DIRECTIONAL DRILL INSTALLATION
WMR-12	RESTORATION SHEET - OPEN CUT INSTALLATION
WMR-23	RESTORATION SHEET - PIPE BURST INSTALLATION
SD-1	STANDARD DETAILS WATER MAIN
SD-2	STANDARD DETAILS WATER MAIN
SD-3	STANDARD DETAILS WATER MAIN
SD-4	STANDARD DETAILS SOIL EROSION AND SEDIMENTATION CONTROL
SD-5	STANDARD DETAILS SOIL EROSION AND SEDIMENTATION CONTROL
SD-6	STANDARD DETAILS RESTORATION 1
SD-7	STANDARD DETAILS RESTORATION 2
SD-8	STANDARD DETAILS RESTORATION 3
SD-9	STANDARD DETAILS RESTORATION 4
SD-10	RESTORATION TREE PLANTINGS SCHEDULE AND DETAIL
SD-11	ELECTRICAL SERVICE ENTRANCE DETAILS

Attached Sewer Design Sheets

	COVER SHEET
G-1	INDEX SHEET
G-2	SCHEDULE OF QUANTITIES
G-3	LOCATION MAP
G-4	SEWER INTERVENTIONS MAP
G-5	SEWER INTERVENTIONS MAP
G-6	ABBREVIATIONS AND GENERAL NOTES
G-7	SOIL EROSION AND SEDIMENTATION CONTROL NOTES AND C.E.D. NOTES
INDEX-P&MH	PIPE AND MANHOLE REHABILITATION REPAIRS
A-P&MH (1 of 2)	PIPE AND MANHOLE REHABILITATION REPAIRS
A-P&MH (2 of 2)	PIPE AND MANHOLE REHABILITATION REPAIRS
INDEX-O&M	O&M PIPE AND MANHOLE REHABILITATION REPAIRS
A-O&M (1 of 2)	O&M PIPE AND MANHOLE REHABILITATION REPAIRS
A-O&M (2 of 2)	O&M PIPE AND MANHOLE REHABILITATION REPAIRS
S-1	EXTERNAL POINT REPAIR AND RESTORATION
TP-1	TYPICAL TRAFFIC CONTROL DETAILS
TP-2	TYPICAL TRAFFIC CONTROL DETAILS
TP-3	MAINTENANCE OF TRAFFIC INFORMATION
SD-1	STANDARD DETAILS SEWER
SD-2	STANDARD DETAILS SEWER
SD-3	STANDARD DETAILS SEWER
SD-4	STANDARD DETAILS SOIL EROSION AND SEDIMENTATION CONTROL
SD-5	STANDARD DETAILS SOIL EROSION AND SEDIMENTATION CONTROL
SD-6	STANDARD DETAILS RESTORATION
SD-7	STANDARD DETAILS RESTORATION
SD-8	STANDARD DETAILS RESTORATION
SD-9	STANDARD DETAILS RESTORATION
SD-10	RESTORATION TREE PLANTING SCHEDULE AND DETAIL

MIKE DUGGAN, MAYOR CITY OF DETROIT WATER AND SEWERAGE DEPARTMENT ENGINEERING DIVISION CONTRACT NO. WS-715, DWRF NO. 7483-01

WATER IMPROVEMENTS
WESTSIDE NEIGHBORHOODS
(MCNICHOLS EVERGREEN/MILLER GROVE/
MINOCK PARK/RIVERDALE/ROSEDALE PARK)

CONTRACT DRAWINGS APRIL 27, 2020



ISSUED FOR PROCUREMENT

DETROIT CITY COUNCIL

BRENDA JONES, PRESIDENT
MARY SHEFFIELD, PRESIDENT PROTEM
JANEÉ AYERS, AT LARGE
ANDRÉ L. SPIVEY
JAMES TATE
SCOTT BENSON
RAQUEL CASTAÑEDA-LÓPEZ
GABE LELAND
ROY McCALISTER JR.

BOARD OF WATER COMMISSIONERS

Water & Sewerage

Department

MICHAEL EINHEUSER, CHAIRMAN
MARY E. BLACKMON, VICE CHAIRPERSON
LANE COLEMAN
JOHN HENRY DAVIS
LINDA D. FORTE
JANE C. GARCIA
JONATHAN C. KINLOCH

GARY BROWN DIRECTOR PAI FNCIA MOR

PALENCIA MOBLEY, P.E.
DEPUTY DIRECTOR/CHIEF ENGINEER

MOHAMAD FARHAT, P.E.
DIRECTOR OF ENGINEERING AND CONSTRUCTION

EXECUTIVE/ADMINISTRATIVE STAFF

TIMOTHY CAVITT
CHIEF OPERATING OFFICER

THOMAS NAUGHTON CHIEF FINANCIAL OFFICER

SHEET NO.	DESCRIPTION
	COVER SHEET
G-1	INDEX SHEET
G-2	SCHEDULE OF QUANTITIES
G-3	LOCATION MAP
G-4	WATER MAIN INTERVENTIONS MAP
G-5	LEGEND, ABBREVIATIONS, AND GENERAL NOTES
G-6	WAYNE COUNTY NOTES
G-7	SOIL EROSION AND SEDIMENTATION CONTROL NOTES, C.E.D. NOTES AND CONTROL POINTS
	WATER MAIN PLAN AND PROFILE
WM-1	PLAN AND PROFILE - BURT RD GRAND RIVER AVE. TO MCNICHOLS RD. (MCNICHOLS EVERGREEN)
WM-2	PLAN AND PROFILE - AUBURN ST OUTER DRIVE TO STA 17+00 (MINOCK PARK)
WM-3	PLAN AND PROFILE - AUBURN ST STA 17+00 TO STA 24+00 (MINOCK PARK)
WM-4	PLAN AND PROFILE - AUBURN ST STA 24+00 TO STA 31+00 (MINOCK PARK)
WM-5	PLAN AND PROFILE - AUBURN ST STA 31+00 TO STA 38+00 (MINOCK PARK)
WM-6	PLAN AND PROFILE - AUBURN ST STA 38+00 TO GRAND RIVER AVE. (MINOCK PARK)
WM-7	PLAN AND PROFILE - MINOCK ST FENKELL AVE. TO STA 15+00 (MINOCK PARK)
WM-8	PLAN AND PROFILE - MINOCK ST STA 15+00 TO STA 21+00 (MINOCK PARK)
WM-9	PLAN AND PROFILE - MINOCK ST STA 21+00 TO STA 27+00 (MINOCK PARK)
WM-10	PLAN AND PROFILE - MINOCK ST STA 27+00 TO GRAND RIVER AVE. (MINOCK PARK)
WM-11	PLAN AND PROFILE - CHALFONTE AVE ARTESIAN ST. TO STAHELIN RD. (ROSEDALE PARK)
WM-12	PLAN AND PROFILE - PENROD ST LYNDON AVE. TO EATON AVE. (ROSEDALE PARK)
WM-13	PLAN AND PROFILE - RIDGE RD FLORENCE ST. TO STA 16+00 (RIVERDALE)
WM-14	PLAN AND PROFILE - RIDGE RD STA 16+00 TO RIVERDALE DR. (RIVERDALE)
WM-15	PLAN AND PROFILE - BRAMELL ST PURITAN AVE. TO STA 17+50 (RIVERDALE)
WM-16	PLAN AND PROFILE - BRAMELL ST STA 17+50 TO STA 23+50 (RIVERDALE)
WM-17	PLAN AND PROFILE - BRAMELL ST - STA 23+50 TO STA 29+50 (RIVERDALE)
WM-18	PLAN AND PROFILE - BRAMELL ST STA 29+50 TO MCNICHOLS RD. (RIVERDALE)
WM-19	PLAN AND PROFILE - BRAMELE ST STA 29+30 TO MCNICHOLS RD. (MVERDALE) PLAN AND PROFILE - PURITAN AVE BEAVERLAND ST. TO CHATHAM (RIVERDALE)
WM-20	PLAN AND PROFILE - LAMPHERE ST VERNE AVE. TO STA 7+50 (RIVERDALE)
WM-21	PLAN AND PROFILE - LAMPHERE ST VENNE AVE. 10 STA 7+30 (RIVERDALE) PLAN AND PROFILE - LAMPHERE ST STA 7+50 TO PURITAN AVE. (RIVERDALE)
WM-22	PLAN AND PROFILE - DOLPHIN ST GROVE ST. TO DEHNER ST. (RIVERDALE)
WM-23	PLAN AND PROFILE - VERNE AVE DOLPHIN ST. TO LAHSER RD. (RIVERDALE)
WM-24	PLAN AND PROFILE - VERNE AVE DOLFTIM ST. TO DATISER RD. (RIVERDALE) PLAN AND PROFILE - BLACKSTONE ST GRAND RIVER AVE. TO STA 8+00 (MILLER GROVE)
WM-25	PLAN AND PROFILE - BLACKSTONE ST STA 8+00 TO FLORENCE ST. (MILLER GROVE)
WM-26	PLAN AND PROFILE - BLACKSTONE ST STA 8+00 TO PLOKENCE ST. (WILLER GROVE) PLAN AND PROFILE - PURITAN AVE BLACKSTONE ST. TO BURT RD. (MILLER GROVE)
WM-27	PLAN AND PROFILE - PORTIAN AVE BLACKSTONE ST. TO BORT RD. (WILLER GROVE) PLAN AND PROFILE - BURT RD GRAND RIVER AVE. TO STA 6+00 (MILLER GROVE)
WM-28	PLAN AND PROFILE - BURT RD STA 6+00 TO FLORENCE ST. (MILLER GROVE)
WM-29	PLAN AND PROFILE - PIERSON ST GRAND RIVER AVE. TO STA 7+00 (MILLER GROVE)
WM-30	PLAN AND PROFILE - PIERSON ST STA 7+00 TO PURITAN AVE. (MILLER GROVE)
WM-31	PLAN AND PROFILE - BRAILE ST FLORENCE ST. TO PURITAN AVE. (MILLER GROVE)
WM-32	PLAN AND PROFILE - PATTON ST GRAND RIVER AVE. TO STA 6+00 (MILLER GROVE)
WM-33	PLAN AND PROFILE - PATTON ST STA 6+00 TO PURITAN AVE. (MILLER GROVE)
WM-34	WM SHEETS SEWER STRUCTURE DETAILS RELINING BLAND SOUTHERED SERVICE DR. LYNDON AVE. TO STA 22 LOC (ROSEDALE RARK)
WL-1	RELINING PLAN - SOUTHFIELD SERVICE DR LYNDON AVE. TO STA 23+00 (ROSEDALE PARK)
WL-2	RELINING PLAN - SOUTHFIELD SERVICE DR STA 23+00 TO GRAND RIVER AVE. (ROSEDALE PARK)
WL-3	RELINING PLAN - LAHSER RD MCNICHOLS RD. TO GROVE ST., KESSLER ST. TO PURITAN AVE. (RIVERDALE)
WL-4	RELINING PLAN - WESTBROOK ST VERNE AVE. TO PURITAN AVE. (MILLER GROVE)
WL-5	WL SHEETS SEWER STRUCTURE DETAILS

	RESTORATION PLANS
WMR-1	WATER MAIN RESTORATION PLAN - BURT RD MCNICHOLS RD. TO GRAND RIVER AVE. (MCNICHOLS EVERGREEN)
WMR-2 WMR-3	WATER MAIN RESTORATION PLAN - AUBURN ST OUTER DRIVE TO STA 17+00 (MINOCK GROVE) WATER MAIN RESTORATION PLAN - AUBURN ST STA 17+00 TO STA 24+00 (MINOCK GROVE)
WMR-4	WATER MAIN RESTORATION PLAN - AUBURN ST STA 24+00 TO STA 31+00 (MINOCK GROVE)
WMR-5	WATER MAIN RESTORATION PLAN - AUBURN ST STA 31+00 TO STA 31+00 (MINOCK GROVE) WATER MAIN RESTORATION PLAN - AUBURN ST STA 31+00 TO STA 38+00 (MINOCK GROVE)
WMR-6	, , , ,
WMR-7	WATER MAIN RESTORATION PLAN - AUBURN ST STA 38+00 TO GRAND RIVER AVE. (MINOCK GROVE)
	WATER MAIN RESTORATION PLAN - MINOCK ST FENKELL AVE. TO STA 15+00 (MINOCK GROVE)
WMR-8	WATER MAIN RESTORATION PLAN - MINOCK ST STA 15+00 TO STA 21+00 (MINOCK GROVE)
WMR-9	WATER MAIN RESTORATION PLAN - MINOCK ST STA 21+00 TO STA 27+00 (MINOCK GROVE)
WMR-10	WATER MAIN RESTORATION PLAN - MINOCK ST STA 27+00 TO GRAND RIVER AVE. (MINOCK GROVE)
WMR-11	WATER MAIN RESTORATION PLAN - CHALFONTE AVE ARTESIAN ST. TO STAHELIN RD. (ROSEDALE PARK)
WMR-12	WATER MAIN RESTORATION PLAN - PENROD ST LYNDON AVE. TO EATON AVE. (ROSEDALE PARK)
WMR-13	WATER MAIN RESTORATION PLAN - RIDGE RD FLORENCE ST. TO STA 16+00 (RIVERDALE)
WMR-14	WATER MAIN RESTORATION PLAN - RIDGE RD STA 16+00 TO RIVERDALE DR. (RIVERDALE)
WMR-15	WATER MAIN RESTORATION PLAN - BRAMELL ST PURITAN AVE. TO STA 17+50 (RIVERDALE)
WMR-16	WATER MAIN RESTORATION PLAN - BRAMELL ST STA 17+50 TO STA 23+50 (RIVERDALE)
WMR-17	WATER MAIN RESTORATION PLAN - BRAMELL ST - ST 23+50 TO STA 29+50 (RIVERDALE)
WMR-18	WATER MAIN RESTORATION PLAN - BRAMELL ST STA 29+50 TO MCNICHOLS RD. (RIVERDALE)
WMR-19	WATER MAIN RESTORATION PLAN - PURITAN AVE BEAVERLAND ST. TO CHATHAM (RIVERDALE)
WMR-20	WATER MAIN RESTORATION PLAN - LAMPHERE ST VERNE AVE. TO STA 7+50 (RIVERDALE)
WMR-21	WATER MAIN RESTORATION PLAN - LAMPHERE ST STA 7+50 TO PURITAN AVE. (RIVERDALE)
WMR-22	WATER MAIN RESTORATION PLAN - DOLPHIN ST GROVE ST. TO DEHNER ST. (RIVERDALE)
WMR-23	WATER MAIN RESTORATION PLAN - VERNE AVE DOLPHIN ST. TO LAHSER RD. (RIVERDALE)
WMR-24	WATER MAIN RESTORATION PLAN - BLACKSTONE ST GRAND RIVER AVE. TO STA 8+00 (MILLER GROVE)
WMR-25	WATER MAIN RESTORATION PLAN - BLACKSTONE ST STA 8+00 TO FLORENCE ST. (MILLER GROVE)
WMR-26	WATER MAIN RESTORATION PLAN - PURITAN AVE BLACKSTONE ST. TO BURT RD. (MILLER GROVE)
WMR-27	WATER MAIN RESTORATION PLAN - BURT RD GRAND RIVER AVE. TO STA 6+00 (MILLER GROVE)
WMR-28	WATER MAIN RESTORATION PLAN - BURT RD STA 6+00 TO FLORENCE ST. (MILLER GROVE)
WMR-29	WATER MAIN RESTORATION PLAN - PIERSON ST GRAND RIVER AVE. TO STA 7+00 (MILLER GROVE)
WMR-30	WATER MAIN RESTORATION PLAN - PIERSON ST STA 7+00 TO PURITAN AVE. (MILLER GROVE)
WMR-31	WATER MAIN RESTORATION PLAN - BRAILE ST FLORENCE ST. TO PURITAN AVE. (MILLER GROVE)
WMR-32	WATER MAIN RESTORATION PLAN - PATTON ST GRAND RIVER AVE. TO STA 6+00 (MILLER GROVE)
WMR-33	WATER MAIN RESTORATION PLAN - PATTON ST STA 6+00 TO PURITAN AVE. (MILLER GROVE)
WLR-1	WATER MAIN RESTORATION PLAN - SOUTHFIELD SERVICE DR LYNDON AVE. TO STA 23+00 (ROSEDALE PARK)
WLR-2	WATER MAIN RESTORATION PLAN - SOUTHFIELD SERVICE DR STA 23+00 TO GRAND RIVER AVE. (ROSEDALE PARK)
WLR-3	WATER MAIN RESTORATION PLAN - LAHSER RD MCNICHOLS RD. TO GROVE ST., KESSLER ST. TO PURITAN AVE. (RIVERDALE)
WLR-4	WATER MAIN RESTORATION PLAN - WESTBROOKE ST VERNE AVE TO PURITAN AVE. (MILLER GROVE)
VV LIX-4	DETAILS
TD 4	
TP-1	TRAFFIC PLAN - TYPICAL TRAFFIC CONTROL DETAILS
TP-2	TRAFFIC PLAN - TYPICAL TRAFFIC CONTROL DETAILS
TP-3	TRAFFIC PLAN - MAINTENANCE OF TRAFFIC INFORMATION
SD-1	STANDARD DETAILS WATERMAIN
SD-2	STANDARD DETAILS WATERMAIN
SD-3	STANDARD DETAILS WATERMAIN
SD-4	STANDARD DETAILS SOIL EROSION AND SEDIMENTATION CONTROL
SD-5	STANDARD DETAILS SOIL EROSION AND SEDIMENTATION CONTROL
SD-6	STANDARD DETAILS RESTORATION-1
SD-7	STANDARD DETAILS RESTORATION-2
SD-8	STANDARD DETAILS RESTORATION-3
SD-9	STANDARD DETAILS RESTORATION-4
SD-10	RESTORATION TREE PLANTINGS SCHEDULE AND DETAIL
	ELECTRICAL SERVICE ENTRANCE DETAILS

REVIEWED AND ACCEPTED BY WATER AND SEWERAGE D	
ENGINEER OF WATER SYSTEMS	DATE
DIRECTOR OF ENGINEERING AND CONSTRUCTION	DATE

F	DESIGNED BY: SEAL / STAMP	DETROIT WATER AND SEWERAGE DEPARTMENT		MDEQ SRF Project No. 7483-01
D	DRAWN BY:	CAPITAL IMPROVEMENT PROGRAM	CITY OF DETROIT WATER AND SEWERAGE DEPA	REF. No. CS-1812 DWSD CONTRACT No.
В	CHECKED BY:	INDEX	DETROIT Water & Sewerage	FILE No.
A ISSUED FOR PROCUREMENT DESCRIPTIONS / REVISIONS CHK'D APP	4/27/20 MANAGER: PR. DATE		Department	DRAWING No. PORTION CODE - - -

		1 1	,,,,,,,,,,,,,,,,,,,,,,,,,,,,,,,,,,,,,,				.	1,,,,,,	1,,,,,,,,		1419.4.44	14/9.4.40		.,,,,,,	45 1404 4		-					م میباد			- Luna aa		1,4,9,4,00		<u>,,,,,,,,,,,,,,,,,,,,,,,,,,,,,,,,,,,,,</u>			a T			
Unit	Item		/M-1 WM-2	WIVI-3	WIVI-4	WM-5 WM-6	o WIVI-/	WIVI-8	WIVI-9	WIVI-10	WIVI-11	WM-12	WIM-13 \	VIVI-14 WIVI-	-15 WM-1	16 WM-1	/ WM-18	WM-19	WIVI-20	WIM-21 V	WM-22 WM-2	3 WIVI-24	WIVI-25	WM-26 WM-2	27 WIVI-28	WIM-29	WIVI-30	WM-31 W	/IVI-32 \	WIVI-33	WL-1	WL-2	WL-3	WL-4 (Contingency
	B Fire Hydrant Assembly, Rem	61	3 2	1	2	2 1	1	1 1	1 1	1	1	1	2	2 3	2	1	1		1		1 3	3	2	1	2	1	2	1	1	2	3	4	2	4	
	9 Fire Hydrant Assembly, Install	75	3 3	2	2	2 2	1	2	2	1	1	1	3	2 3	2	2	1	1	1	1	1 3	3	2	1	2	2	2	2	2	2	4	4	3	4	
	Water Main, Abandon, Fill with Flowable Fill, 6 inch	3,623								250	344								702		527 225	47		470	388										
	Water Main, Abandon, Fill with Flowable Fill, 8 inch	7,470 7	737	63									580	540 75	5	115		560		66		770	610			700	860	605	589	600					
	Gate Valve and Box, Rem, 6 inch	1																																	1
	Gate Valve and Box, Rem, 8 inch	1																																	1
<u> </u>	Gate Valve and Box, 8 inch	41	1	1	1	2 1	1	1	1	1	4	1		1	1	1	1	3	2	4	1	1	1	2 1				1	1		1	2		2	
	Gate Valve and Well, Abandon, Fill with Flowable Fill, 6 inch	7									2								1	2	2														
EA 3	Gate Valve and Well, Abandon, Fill with Flowable Fill, 8 inch	7																1		1		2					1	1	1						
EA 3	Gate Valve and Well, Rem, 6 inch	12	1	2		1	1		1			1							1	1	2				1										
EA 3	Gate Valve and Well, Rem, 8 inch	25				1 1					2		1	1 2	1	1		2			1		1	2			1	1			1	1	2	3	
EA 3	Gate Valve and Well, 8 inch	23	1										2	1 1						1	3 3	1			1		2				1	1	4	1	
LFT 4	Water Main, Open Cut, Ductile Iron, 8 inch	6,767	58 20	231	20	83 40	20	86	70	271	137	40	600	551 20	7 105	120	20	111	178	272	176 165	797	65	58 149	41	700	846	46	106	89	62	62	87	78	
LFT 4	Water Main, Pipe Bursting, HDPE, 6 inch to 8 inch	4,890	680	469	680	85	480	514	530	234		730									488														
LFT 4	Water Main, Pipe Bursting, HDPE, 8 inch to 8 inch	3,583				532 491								543	3 495	480	540							502											
LFT 4	Water Main, Direction Drill, HDPE, 8 inch	5,956	675								276							470	619	550	384	38	554	451	366			560	494	519					
LFT 4	Water Main, Concrete Encasement	35				15			20																										
- I	Water Main, Lining, 8 inch	4,390																													1238	1161	775	1216	
	Water Main, Connect to Existing	57	2 1			2 1	1			1	4	2	1	1 1			1	2	2	4	4 3	3	1	4 1	1	1	1	2	1	1	1	1	4	2	
	7 Water Main, Temporary	11,656	750	750	750	750 575	550	650	650	556		830		800	0 650	535	610				100												850	1300	
	Water Service, 1 inch, Short	303	1 10	11	13	16 8	13	11	10	7		19	5	6 10		11	9		9	6	9	10	9	6	7	8	10	15	9	11				23	
	Water Service, 1 inch, Long	282	9	14	17	12 9	8	11	7			17		12		11	8		11	9	3	12	11	3	8	10	11	15	8	9			5	22	
) Water Service, 1.5 inch, Short	1																																	1
EA 5	<u> </u>	1																																	1
	2 Water Service, 2 inch, Short	1																								1	1			1					
	3 Water Service, 3 inch	3	1																		1			1											
	Water Service, Reconnect Existing Copper Service, 1 inch	10										1	2						1	1			1	2						1			1		
	Water Service, Reconnect Existing Copper Service, 1.5 inch	2																						- -									1		1
	Water Service, Reconnect Existing Copper Service, 2 inch	3								1																							2		
	Water Service, Remove and Replace Lead Service Line, 1 inch	9,785	25 300	275	325	475 275	250	325	300	175		1300	20	40 32	5 325	350	350		325	300	100	380	300	50	250	325	300	705	375	280			100	560	
	Water Service, Hydro-Vac	603	2 19	25	30	28 17	21	22		8		37	7	6 22			17		21	16	12 1	22		12			21		17	22			q	45	
	Water Service, Remove and Replace Curb Box	121		-23		20 17			'				,	<u> </u>					<u></u>	10	14 1			12	15	10									121
	Water Service, Remove and Replace Curb Stop	121		+					+ +	+							+									+	1		+	+					121
	L Electrical Grounding System	477	2 19	25	30	28 17	21	22	17	Ω		37		22	2 21	22	17		21	16	12 1	7	21	12	15	+		30	17	22					
	2 Pitcher Style Filters and Refill Filter Cartridges	549	2 19	25	30	20 17	21	22	17	ρ Q		37	7	6 22	_	_	17		21	16	12 1	22	21	12		18	21	30	17	22					
	Water Main, Hydrostatic Pressure Test	25,586 7	733 700	700	700	700 531	500	600	600	505	413	770	600	551 750			560	581	797	822	560 653	835	619	560 600		700	846	- 50	600	608	1300	1223	862	1294	
		 	733 700				_					770					_								_		+								
	Water Main, Chlorination and Flushing	25,586 7 74	733 /00	700	700	700 531	500	600		505	413			551 750		600	560	581	797	822	560 653	_			407	700	846		600	608	1300	1223	862	1294	
	Water Main, Bacteriological Test	- 	2 2			2 2	2	2	2	2	2		2	2 2	2		<u> </u>		2		2 2	2	2	2 2	2	-	-		2						
	Permit Allowance	ALLOW																								1									
	7 Contaminated Material Allowance	ALLOW							+	-												-				-	1								
LS 6	Provisional Allowance	ALLOW																																	

Unit Item	Total WMR-1 V	VMR-2 WMR-3	WMR-4	WMR-5 WI	/IR-6 WMR-7	WMR-8	WMR-9 W	/MR-10 WMR-:	1 WMR-12	WMR-13	WMR-14 WMR-	15 WMR-16	6 WMR-17	WMR-18 WMR-1	.9 WMR-20) WMR-21	WMR-22 WN	/IR-23 WMR-	24 WMR-25	WMR-26	WMR-27 WMF	-28 WMR-29	WMR-30	WMR-31 WN	R-32 WMR-	33 WLR-1	WLR-2	WLR-3	WLR-4
1 Mobilization/Demobilization	1																											(•
2 Material Testing	1																												
3 Traffic Control	1																											·	'
4 Pre-Construction Site Documentation	1																												
5 Project Sign	4																												
6 Closeout	1																												
7 Sidewalk, Rem	40																												
8 Sidewalk, Conc, 4 inch	2,444 6	53 76	88	97 !	54 85	121	93	235 75	108	79	17 82	58	78	47 12	86	50	56	27 34	59	21	30 47	32	47	82	6 75	39	51	27	120
9 Sidewalk, Conc, 6 inch	48	5			5	11		21								6													
10 ADA Ramp, w/ Curb	438	9 16		12			15	39			35	16	33	16	17	27	36	11	21	19			16		4 31	8	5		13
11 Curb and Gutter, Rem	20																												
12 Curb and Gutter, Conc	1,408 15	15		58 !	38	34	67	37 61	9	239	112 178	60	102	55	20	20		40				14				56	77	20	10
13 Pavement, Rem	4,540														33	138		655				1642	1867		27			10	18
14 Driveway, Conc, 6 inch	340 18	25 61	10		9 7	15		37 14	8	33	43	26				14						6				14			
15 Aggregate Base, No. 22A, 6-inch	7,642 65	78		31			85	20 14	5	264	250 338	23	19	194	95	275		1189		6		2124	2436		60		9	14	28
16 Concrete Base, 8 inch	564								5		34	23	19			47	52 1	L31 17	19	7	93 12				21		9	55	
17 Concrete Base, 10 inch	78	78																											
18 HMA Pavement, Rem, Milling, 2 inch Depth to 4 inch Depth	3,777 99	62		29				17	39	525	370 166	40	25			77	248 1	L44 45	20	17	1373 43				259			129	
19 HMA Pavement, 36A, 1.5 inch	4,897 164			60				31	44	789	620 200	62	44			124	300 2	276 62	39	24	1467 55				280		21	184	'
20 HMA Pavement, 13A, 2 inch	5,535 236			97				46	44	1052	870 200	62	44			124	300 2	276 62	39	24	1467 55				280		21	184	
21 HMA Pavement, 5E3, 2 inch	140	140																											
22 Concrete Paving, 9 inch	6,910						85	20			304			194	95	261		1189		6		2119	2436		60			14	28
23 Structure, Adjust Existing Casting to Grade	33 1							1		4				1		2	2	4			3	5	10						
24 Mulched Seeding	3,767 26	122 193	106	100	33 74	112	73	41 93	163	277	393 126	157	175	82 95	125	112	95	46 60	62	24	46 57	44	83	93	4 70	23	19	16	127
25 Tree, Rem, 6 inch to 18 inch Diameter	3								1																				
26 Tree, Rem, Greater than 18 inch Diameter	2	1				1																							
27 Tree, Install	5	1				1			1																			(

F					DESIGNED BY:	SEAL / STAMP
E						
D					DRAWN BY:	
С					CHECKED BY:	
В					CHECKED BY.	
Α	ISSUED FOR PROCUREMENT			4/27/20	MANAGER:	
	DESCRIPTIONS / REVISIONS	CHK'D	APPR.	DATE		

DETROIT WATER AND SEWERAGE DEPARTMENT CAPITAL IMPROVEMENT PROGRAM

SCHEDULE OF QUANTITIES - WATER MAIN, AND RESTORATION





SECTION MAP

CITY OF DETROIT
WATER AND SEWERAGE DEPARTMENT
ENGINEERING DIVISION

7483-01

REF. No.

CS-1812

DWSD CONTRACT No.


WS-715


FILE No.


DRAWING No.

E

G-2

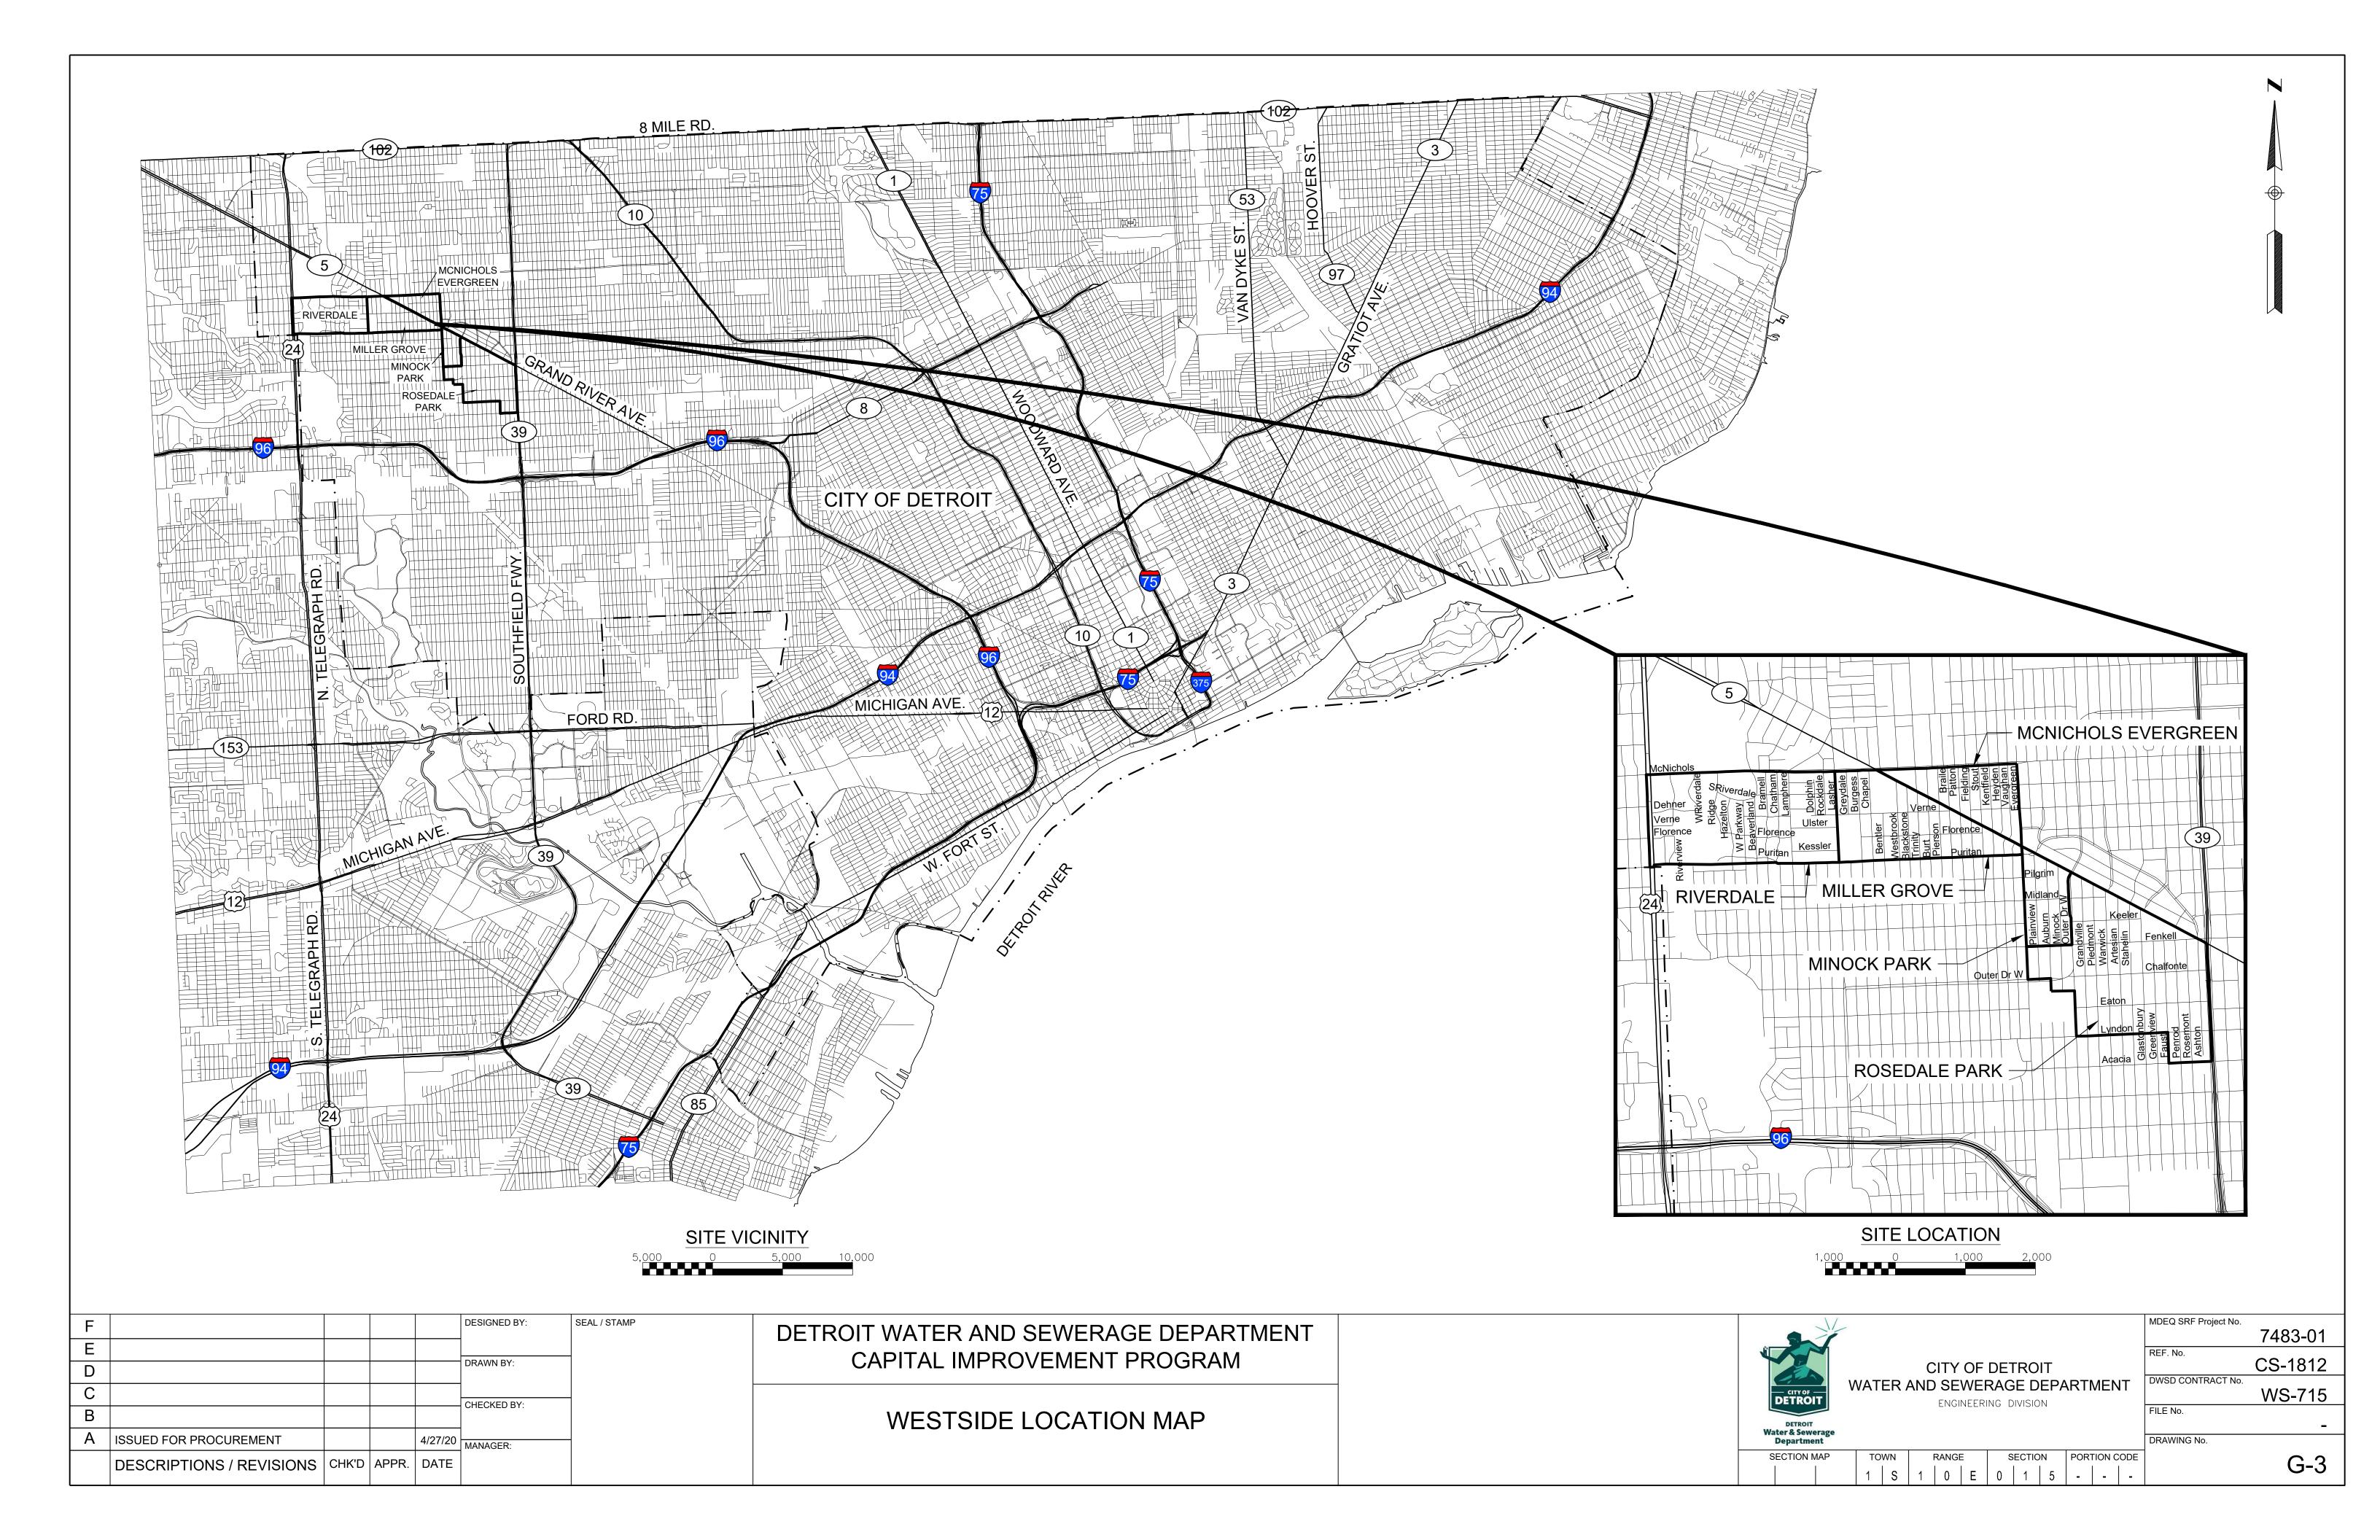

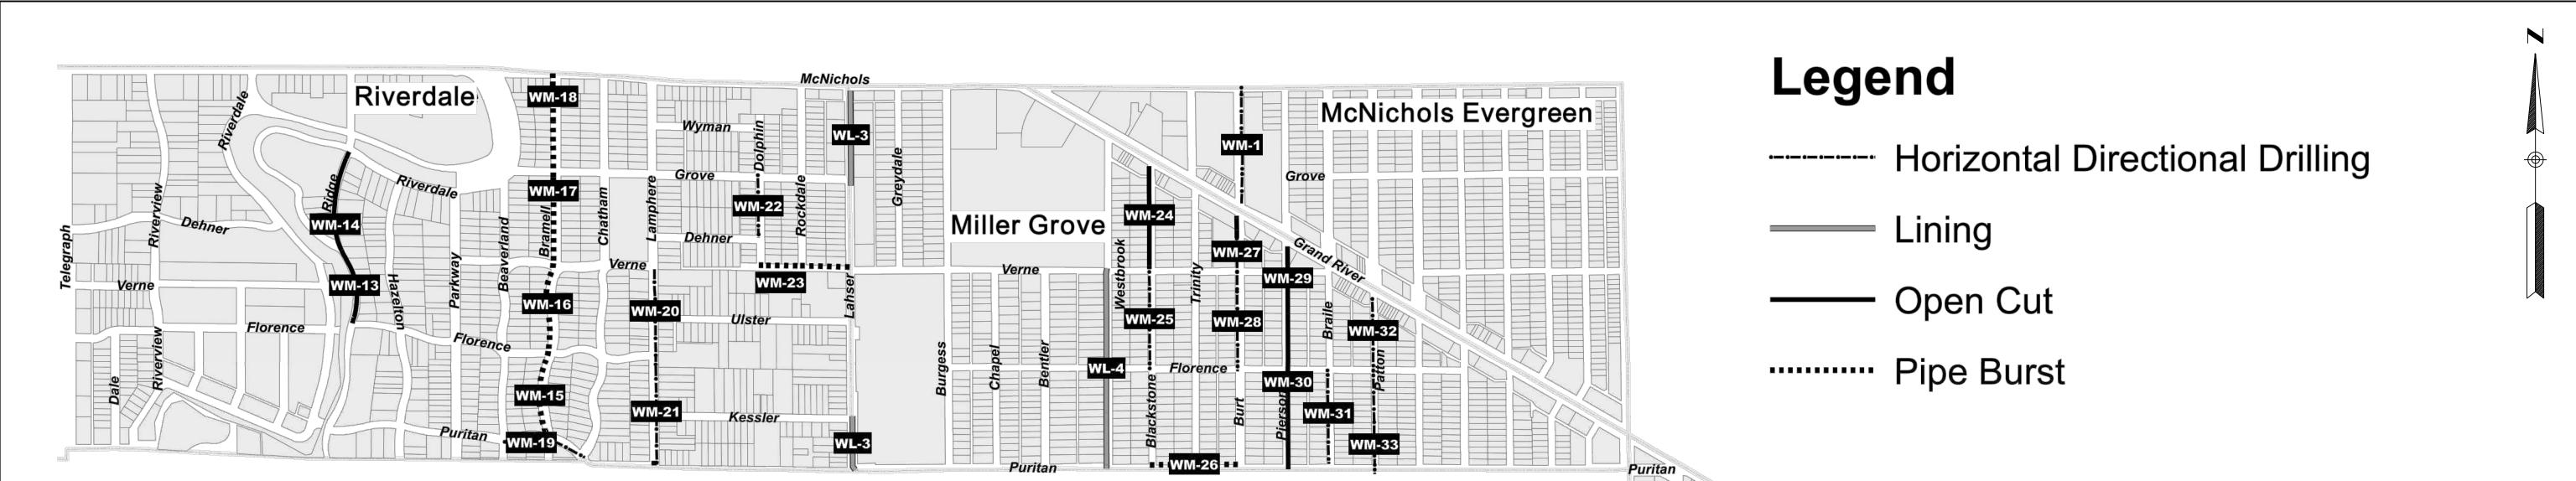

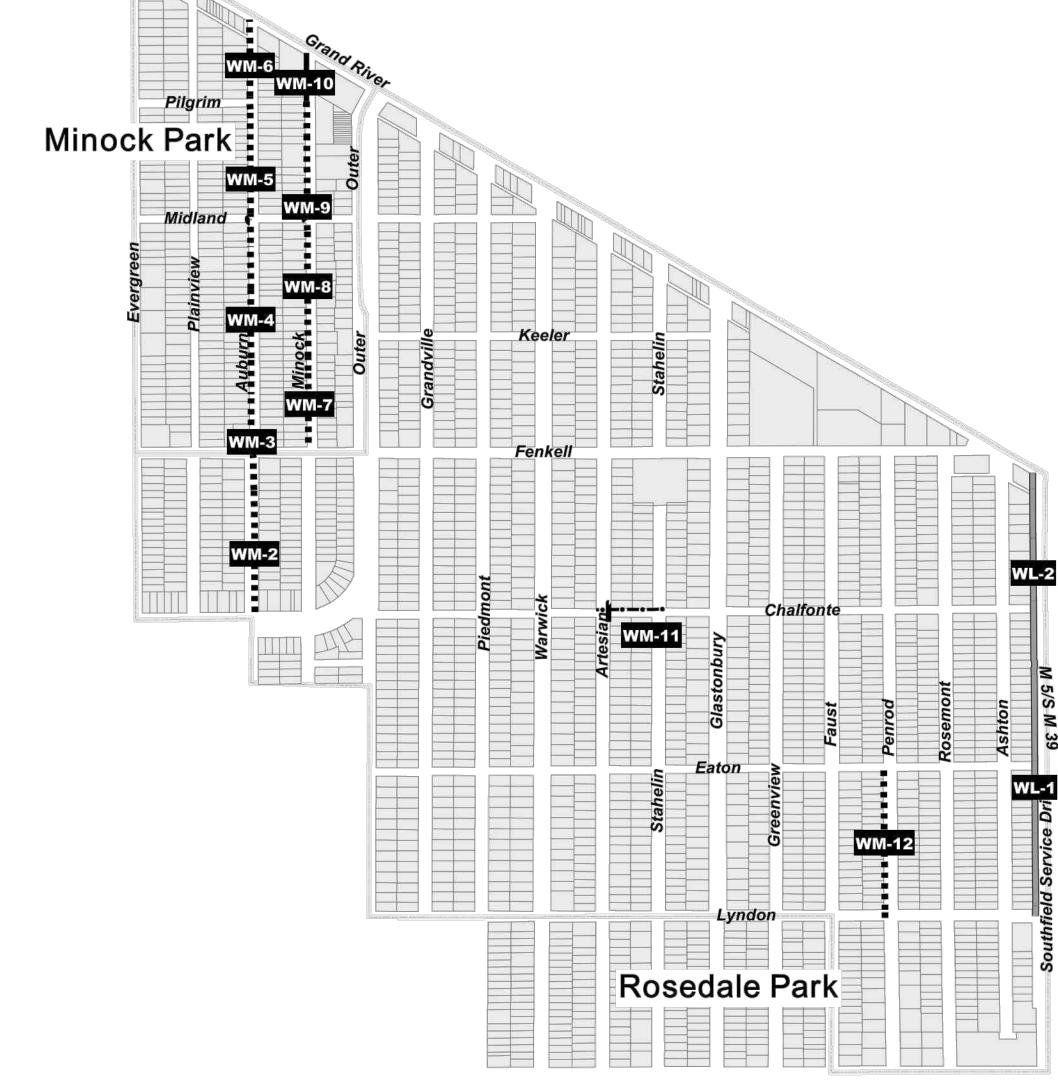

F					DESIGNED BY:	SEAL / STAMP
E						
D					DRAWN BY:	
С					CHECKED BY:	
В					CHECKED BY.	
Α	ISSUED FOR PROCUREMENT			4/27/20	MANAGER:	
	DESCRIPTIONS / REVISIONS	CHK'D	APPR.	DATE		

DETROIT WATER AND SEWERAGE DEPARTMENT CAPITAL IMPROVEMENT PROGRAM

WATER MAIN INTERVENTIONS MAP




CITY OF DETROIT	CITY OF DETROIT WATER AND SEWERAGE DEPARTMENT ENGINEERING DIVISION
DETROIT Water & Sewerage Department	

SECTION MAP

MDEQ SRF Project No.	
	7483-01
REF. No.	00 1010
	CS-1812
DWSD CONTRACT No.	
	WS-715
FILE No.	
	-
DRAWING No	

G-4

PORTION CODE

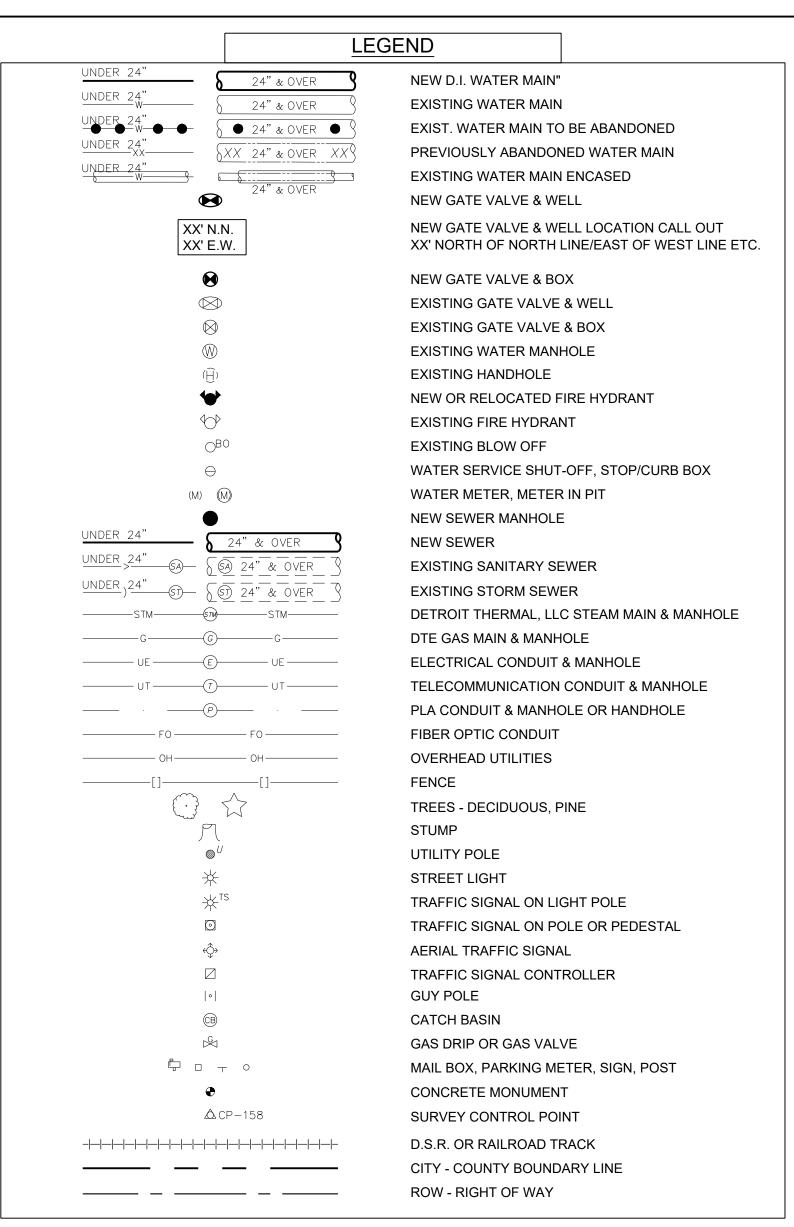

ABBREVIATIONS

ASPH	ASPHALT PAVEMENT	PLA PU	BLIC LIGHTING AUTHORITY
AC	ASBESTOS CEMENT PIPE	ROW	RIGHT OF WAY
C.E.D.	CITY ENGINEERING DIVISION	SAC	ASPHALT ABOVE CONCRETE
CONC.	CONCRETE	SPL/NPL/EPL/WPL	SOUTH/NORTH/EAST/WEST
DTE/D.E. CO	DETROIT EDISON COMPANY		PROPERTY LINE
DWSD	DETROIT WATER AND SEWERAGE DEPT.	PROP.	PROPOSED
EX.	EXISTING	STM	STORM
F.G.	FINISH GROUND	UN-DEAD	UNKNOWN MATERIAL - DEAD
HORIZ	HORIZONTAL	VERT.	VERTICAL
HDD	HORIZONTAL DIRECTIONAL DRILLING	WM	WATER MAIN
НМА	HOT MIX ASPHALT	WMR	WATER MAIN RESTORATION
HYD.	HYDRANT	WS	WATER SERVICE
I.E.	INVERT ELEVATION	WTR.	WATER

- 1. THE COORDINATES SHOWN ON THESE PLANS ARE BASED ON NORTH AMERICAN DATUM OF 1983. THE ELEVATIONS SHOWN ON THESE PLANS ARE BASED ON CITY OF DETROIT VERTICAL DATUM.
- 2. A DETAILED SURVEY OF THE STREETS INVOLVED IN THIS CONTRACT HAS BEEN MADE. UNDERGROUND STRUCTURES AND UTILITIES SHOWN ARE FROM FIELD MEASUREMENTS AND INFORMATION FURNISHED TO THE ENGINEER BY THE MAJOR SERVICE COMPANIES. NO GUARANTEE IS MADE AS TO THE ACCURACY OR COMPLETENESS.
- 3. THE CONTRACTOR TO VERIFY ALL EXISTING STRUCTURES AND UTILITIES IN THE FIELD PRIOR TO WORK COMMENCING.
- 4. BIDDER SHALL VERIFY TYPES AND LOCATIONS OF PAVEMENTS AND CURBS OF STREETS AND ALLEYS (ESPECIALLY AT INTERSECTIONS) WITH RESPECT TO THEIR INTERFERENCE WITH THE WATER MAIN REPLACEMENT AND/OR INSTALLATION AND SHALL INCLUDE COST OF CROSSING AND RESTORATION USING THE RELEVANT UNIT PRICE ITEMS.
- 5. ALL SIDEWALKS, DRIVEWAYS, SERVICE WALKS, CURBS, UTILITY POLES, TRAFFIC SIGNAL POLES, LIGHT POLES, TREES, LAWNS ETC., MAY NOT BE SHOWN ON THESE DRAWINGS. THE BIDDER SHALL VISIT THE PROJECT SITE AND MAKE THEIR OWN DETERMINATION OF THE SITUATION AND INCLUDE ALL WORK AND RESTORATION INVOLVING THESE IMPROVEMENTS USING THE RELEVANT UNIT PRICE ITEMS.
- 6. EXACT LOCATION AND DEPTH OF EXISTING WATER MAINS SHALL BE VERIFIED IN THE FIELD BY THE CONTRACTOR.
- 7. WATER MAIN CONSTRUCTION OR REPLACEMENT IN CLOSE PROXIMITY TO UTILITY POLES, CATCH BASINS, TREES, ETC., MAY REQUIRE TUNNELING AND/OR THE USE OF CASING PIPES OR APPLYING BENDS TO OFFSET OBSTRUCTION. THE SUPPORT OF THESE STRUCTURES SHALL BE CONSIDERED INCIDENTAL TO THE CONTRACT WORK AND THEREFORE INCLUDED IN THE UNIT PRICE OF THE PIPE INSTALLATION.
- 8. UNLESS OTHERWISE NOTED AND SHOWN ON THE DRAWINGS, ALL SERVICE CONNECTIONS 3 INCHES AND LARGER ON EXISTING WATER MAINS ARE ASSUMED AS TAPPING SLEEVE AND VALVE CONNECTIONS AND SHALL BE RECONNECTED TO THE NEW WATER MAIN BY INSTALLING TEES, GATE VALVES AND GATE BOXES, ALL AT THE ESTABLISHED UNIT PRICE.
- 9. THE CONTRACTOR SHALL REPLACE ALL EXISTING FITTINGS WITH NEW FITTINGS, AT NO ADDITIONAL COST TO THE DWSD, UNLESS OTHERWISE NOTED ON DRAWINGS.
- 10. ALL EXISTING FIRE HYDRANT CONNECTIONS EMPLOYING TAPPING SLEEVE AND VALVE (T.S.&V.) SHALL HAVE THEIR CONNECTION TO THE WATER MAIN REPLACED. THE CONTRACTOR SHALL RECONNECT ALL EXISTING HYDRANTS (TO REMAIN) TO THE NEW WATER MAIN BY INSTALLING/REPLACING REQUIRED TEE, GATE VALVE, GATE BOX AND WATER MAIN PIPES. TAPPING SLEEVES WILL NOT BE USED FOR HYDRANT CONNECTIONS.
- 11. THE CONTRACTOR SHALL REPLACE ALL SINGLE NOZZLE HYDRANTS WITH STANDARD 5-BR250 FIRE HYDRANTS, AT THE ESTABLISHED UNIT PRICE FOR FIRE HYDRANT ASSEMBLY.
- 12. DAMAGE TO EXISTING VALVE WELLS OCCURRING DURING PIPE AND/OR VALVE INSTALLATION SHALL BE REPAIRED BY THE CONTRACTOR, AS DIRECTED BY THE ENGINEER, AT NO ADDITIONAL COST TO DWSD REPAIRING OF THE WELL SHALL INCLUDE, BUT NOT BE LIMITED TO, BRICK REPLACEMENT, REMORTARING JOINTS AND ADJUSTING THE FRAMES AND COVERS TO GRADE. WORN FRAMES AND COVERS LOCATED IN THE PAVEMENT SHALL BE EXCHANGED FOR NEW FRAMES AND COVERS PER THE STANDARD DRAWINGS. REMOVAL AND REPLACEMENT OF FRAMES AND COVERS SHALL BE REQUIRED AS DIRECTED BY THE ENGINEER. FRAMES COVERS AND VALVES SHALL BE SALVAGED AND RETURNED TO DWSD AT NO COST TO THE OWNER.
- 13. DWSD WATER MAIN THRUST RESTRAINT WILL BE ATTAINED WITH THE USE OF LOCKING GASKETS AS PER THE DETAILED SPECIFICATIONS. ON SOME OCCASIONS, DWSD'S STANDARD CONCRETE THRUST BLOCKS MAY BE CALLED OUT TO BE PLACED ON FITTINGS, AS NOTED ON THE DRAWINGS. IF REQUIRED, VERTICAL THRUST BLOCKS FOR TOP BENDS WILL REQUIRE REINFORCING STEEL. IF VERTICAL THRUST BLOCKS ARE APPROVED BY THE ENGINEER, THE CONTRACTOR SHALL PLACE VERTICAL THRUST BLOCKS AT ALL VERTICAL BENDS 22-1/2 DEGREES AND LARGER.
- 14. THE CONTRACTOR SHALL PROVIDE TEMPORARY RESTRAINTS (BRACED PLUGS, CAPS, VALVES, ETC.) AS REQUIRED TO KEEP ALL EXISTING WATER MAINS IN SERVICE OR WITH MINIMAL SHUT DOWN TIME AS DIRECTED BY THE ENGINEER, UNLESS TEMPORARY SERVICES ARE PROVIDED. THE BIDDER SHALL INCLUDE THIS WORK IN THE UNIT PRICE OF THE PIPE INSTALLATION.
- 15. IN COMPLIANCE WITH MICHIGAN PUBLIC ACT 53 OF THE ACTS OF 1974, THE CONTRACTOR SHALL NOTIFY, 3 WORKING DAYS (72 HOURS) IN ADVANCE OF CONSTRUCTION, ALL PUBLIC AND PRIVATE OWNERS HAVING EXISTING FACILITIES IN OR NEAR THE IMMEDIATE WORKING AREA. THE CONTRACTOR SHALL BE RESPONSIBLE FOR VERIFYING UTILITY LOCATIONS AND NOTIFYING MISS DIG (PHONE 1-800-482-7171).
- 16. ALL SIDEWALK AND SIDEWALK RAMP REPLACEMENT, IN THE CITY OF DETROIT RIGHT-OF-WAY, SHALL BE ADA COMPLIANT. IN ADDITION, THE SIDEWALK CROSS SLOPE SHALL NOT BE GREATER THAN 2% AND SHALL BE SLOPED TO ASSURE DRAINAGE TO THE STREET (TRY TO MAINTAIN A MINIMUM 1% SLOPE IN THE DIRECTION OF FLOW).
- 17. MANHOLE COVERS, GATE BOXES, FIRE HYDRANTS AND ANY SURFACE ITEMS SHALL NOT BE LOCATED IN SIDEWALK RAMPS, LANDINGS OR CROSSWALKS. STOP BOXES SHALL BE LOCATED 1 FOOT BEYOND THE PROPERTY LINE WITHIN PROPERTY.

GENERAL NOTES

- 18. THE BIDDER'S ATTENTION IS DIRECTED TO THE SPECIFICATIONS AND STANDARD DRAWINGS FOR THE REQUIREMENTS OF THE CITY ENGINEERING DIVISION OF THE DEPARTMENT OF PUBLIC WORKS (D.P.W.), CITY OF DETROIT.
- 19. IF PARKING RESTRICTIONS ADJACENT TO THE CONTRACTOR'S WORK ZONE DO NOT ALLOW OVERNIGHT PARKING OR RESTRICT DAYTIME PARKING, THE CONTRACTOR SHALL PROVIDE ACCESS TO PRIVATE PROPERTIES DURING CONSTRUCTION. THIS INCLUDES, BUT IS NOT LIMITED TO, PROVIDING A TEMPORARY RAMP TO CROSS ANY TEMPORARY WATER PIPES OR EXCAVATIONS THAT MAY LIMIT ACCESS TO DRIVEWAYS.
- 20. THE TRAFFIC REQUIREMENTS SET FORTH BY THE CITY OF DETROIT DEPARTMENT OF PUBLIC WORKS (D.P.W.), TRAFFIC ENGINEERING DIVISION, THE WAYNE COUNTY DEPARTMENT OF PUBLIC SERVICES (WCDPS) AND THE MICHIGAN DEPARTMENT OF TRANSPORTATION (M.D.O.T.) ARE INCLUDED IN THE CONTRACT SPECIFICATIONS. WHERE THE REQUIREMENTS CONFLICT, THE MOST STRINGENT WILL GOVERN.
- 21. "FIRE HYDRANT ASSEMBLY" SHALL INCLUDE FURNISHING AND INSTALLING NEW 5-BR250 FIRE HYDRANT, 6-INCH SERVICE GATE VALVE, SHOE, FROST JACKET, TEE AND ALL RELATED PIPING AND APPURTENANCES. THE CONTRACTOR SHALL ASCERTAIN THE EXACT LOCATION FOR THE NEW HYDRANT FROM THE D.F.D. AND THE ENGINEER IN SUFFICIENT TIME PRIOR TO CONSTRUCTION. THE HYDRANT TEE SHALL BE CONSIDERED INCIDENTAL WITH FIRE HYDRANT ASSEMBLY REPLACEMENT. REMOVAL AND/OR SALVAGE AND DELIVERY TO DWSD OF AN EXISTING HYDRANT SYSTEM SHALL BE AS DIRECTED BY THE ENGINEER. COSTS ASSOCIATED SHALL BE INCLUDED IN THE UNIT PRICE OF THE HYDRANT REMOVAL ITEM. NEW HYDRANTS SHALL NOT BE LOCATED BEYOND A TEN-FOOT RADIUS OF THE ORIGINAL HYDRANT LOCATION UNLESS APPROVED IN WRITING BY THE DWSD ENGINEER.
- 22. AT LOCATIONS WHERE THERE IS INSUFFICIENT VERTICAL (18") OR HORIZONTAL (3') CLEARANCE BETWEEN NEW WATER MAIN AND EXISTING UTILITIES, THE CONTRACTOR SHALL CONSTRUCT THE NEW WATER MAIN AS DIRECTED BY THE DWSD ENGINEER. THIS INCLUDES THE USE OF VERTICAL OR HORIZONTAL BENDS WHERE REQUIRED. THE USE OF BENDS SHALL BE INCIDENTAL TO THE WORK AND COSTS THEREFORE SHALL BE INCLUDED IN THE LINEAR FOOT UNIT PRICE OF PIPE INSTALLATION.
- 23. NEW WATER MAINS ARE TO BE INSTALLED AT A MINIMUM OF TEN FEET (10') HORIZONTALLY FROM SANITARY AND STORM SEWERS, WHENEVER POSSIBLE. IF TEN FEET (10') HORIZONTAL CLEARANCE CANNOT BE ATTAINED, THE NEW WATER MAIN SHALL BE INSTALLED AT THE LOCATION SHOWN ON THE PLANS, AS DIRECTED BY THE DWSD ENGINEER.
- 24. A MINIMUM OF 18 INCHES OF VERTICAL SEPARATION SHALL BE MAINTAINED AT ALL TIMES WHERE A WATER MAIN CROSSES A SANITARY OR STORM SEWER WITH A FULL LENGTH OF PIPE CENTERED ON THE CROSSING SO THAT JOINTS ARE AS FAR FROM THE SEWER CROSSING AS POSSIBLE TO MINIMIZE POTENTIAL FOR CROSS CONTAMINATION. ACTUAL DEPTHS OF EXISTING WATER MAINS AND SEWERS SHALL BE VERIFIED IN THE FIELD. REFER TO DETAIL NO. 312333-07.
- 25. THE CONTRACTOR SHALL RECONNECT ALL EXISTING DI AND COPPER SERVICES TO THE NEW WATER MAIN. FOR SERVICES THREE INCHES AND LARGER, INSTALL REQUIRED TEE, GATE VALVE, GATE BOX AND DI WATER MAIN PIPES. FOR SERVICES AT LEAST ONE INCH AND SMALLER THAN THREE INCHES, INSTALL CORPORATION STOP AND COPPER TUBING. FOR SERVICES SMALLER THAN ONE INCH, INSTALL CORPORATION STOP, ONE INCH COPPER TUBING AND REDUCER.
- 26. EXISTING WATER MAINS ARE TO BE REPLACED ACCORDING TO THE SIZE AND MATERIAL SHOWN IN THE SPECIFICATIONS AND ON THE DRAWINGS, AND DUCTILE IRON WATER MAINS ARE TO BE INSTALLED WITH AN 8-MIL POLYETHYLENE WRAP.
- 27. THE MINIMUM BURIAL DEPTH FOR NEW WATER MAIN SHOULD NOT BE LESS THAN 5 FEET TO PROTECT FROM FREEZING. IF THE BURIAL DEPTH WILL BE LESS THAN 5 FEET, THE OWNER SHALL BE NOTIFIED AND OTHER MEANS OF INSULATION SHOULD BE USED. THE FORM OF INSULATION AND LOCATION OF INSTALLATION MAY OR MAY NOT BE INDICATED ON THE DRAWINGS. REFER TO DWSD'S STANDARD DETAIL FOR WATER MAIN TRENCH INSULATION.
- 28. EXISTING WATER MAINS TO BE CUT AND ABANDONED FOR NEW WATER MAIN CONSTRUCTION SHALL BE BULK HEADED AND FILLED WITH FLOWABLE FILL PER THE DETAILED SPECIFICATIONS.
- 29. THE CONTRACTOR IS REFERRED TO THE DETAILED SPECIFICATIONS REGARDING "SHEETING AND BRACING" REQUIREMENTS. THE CONTRACTOR SHALL PROVIDE SHEETING AND BRACING TO PROTECT ADJACENT PAVEMENT, CURBS, SIDEWALKS, PIPELINES, CONDUITS, THE WORK AND PERSONNEL. THE CONTRACTOR SHALL BE TOTALLY RESPONSIBLE FOR ANY AND ALL DAMAGES AND INJURIES RESULTING FROM A FAILURE TO PROVIDE ADEQUATE SHEETING AND BRACING, AT NO ADDITIONAL COST TO DWSD
- 30. IF A CRANE, BACKHOE OR A BOOM WILL BE USED IN THE VICINITY OF DETROIT EDISON OVERHEAD LINES, THE DETROIT EDISON COMPANY MUST BE NOTIFIED THREE WORKING DAYS PRIOR TO SUCH USE.
- 31. THE CONTRACTOR SHALL EXPOSE EXISTING WATER MAINS AT POINTS OF CONNECTION AND VERIFY THEIR LOCATION AND ELEVATION PRIOR TO PIPE LAYING.
- 32. THE CONTRACTOR SHALL CUT AND CAP OR PLUG EXISTING WATER MAINS TO REMAIN IN SERVICE WHERE REQUIRED.
- 33. ALL 4" C.I. BLOW-OFF ASSEMBLIES, C.I. PLUGS AND CAPS TO BE INSTALLED AND/OR REMOVED BY THE CONTRACTOR HAVE NOT BEEN SHOWN ON THE DRAWINGS.

- 34. THE DRAWINGS INDICATE THE ARRANGEMENT, GENERAL DESIGN AND EXTENT OF THE WATER MAIN ALTERATIONS. THE MAINS AND CONNECTIONS ARE SHOWN, MORE OR LESS, IN DIAGRAM AND IN THEIR GENERAL LOCATIONS, EXCEPT WHERE IN CERTAIN CASES THE DRAWINGS MAY INCLUDE DETAILS GIVING THE EXACT LOCATION AND ARRANGEMENT. DUE TO THE SMALL SCALE OF THE DRAWINGS, IT IS NOT POSSIBLE TO INDICATE ALL OFFSETS, FITTINGS, VALVES AND ACCESSORIES THAT ARE REQUIRED. THE CONTRACTOR SHALL CAREFULLY INVESTIGATE THE STRUCTURAL AND OTHER CONDITIONS AFFECTING ALL THE WORK AND SHALL ARRANGE AND PERFORM HIS WORK UNDER THIS CONTRACT ACCORDINGLY, FURNISHING AND INSTALLING SUCH ITEMS OF MATERIAL AS MAY BE REQUIRED TO MEET SUCH CONDITIONS.
- 35. THE CONTRACTOR IS RESPONSIBLE FOR PROTECTING ALL EXISTING SEWERS, WATER MAINS, DRAINS AND DRAINAGE DITCHES INCLUDING ANY PUBLIC OR PRIVATE UTILITY, OVERHEAD OR UNDERGROUND, BY THE MEANS OF POTHOLING OR OTHER METHODS. IF ANY UTILITIES ARE DAMAGED DURING CONSTRUCTION THEY SHALL BE RESTORED BY THE CONTRACTOR AT NO ADDITIONAL COST TO THE CITY, TO THE SATISFACTION OF THE ENGINEER, THE UTILITY OWNER AND THE AUTHORITIES HAVING JURISDICTION.
- 36. ALL PREVIOUSLY ABANDONED OR LIVE UTILITIES, WATER MAINS, STORM SEWERS, AND COMBINED SEWERS MAY NOT BE SHOWN ON THE DRAWINGS. NO GUARANTEE IS MADE AS TO THEIR ACCURACY OR COMPLETENESS. SHOULD THE CONTRACTOR NEED MORE INFORMATION, A TIMELY REQUEST TO INDIVIDUAL UTILITY COMPANIES FOR THEIR FACILITY INFORMATION AND DWSD FOR WATER AND SEWER INFORMATION SHOULD BE MADE.
- 37. REFER TO SOIL EROSION AND SEDIMENTATION CONTROL NOTES ON G-10.
- 38. CURB OR CURB AND GUTTER CALLED OUT TO BE INSTALLED SHALL BE PLACED PER THE CITY OF DETROIT'S STANDARD DETAIL INCLUDED IN THESE PLANS.
- 39. FOR RESTORATION ITEMS, MATERIALS AND WORKMANSHIP SHALL BE IN ACCORDANCE WITH THE CITY OF DETROIT DEPARTMENT OF PUBLIC WORKS CITY ENGINEERING DIVISION STANDARD SPECIFICATIONS FOR PAVING AND RELATED CONSTRUCTION AND THE MICHIGAN DEPARTMENT OF TRANSPORTATION 2012 STANDARD SPECIFICATIONS FOR CONSTRUCTION EXCEPT WHERE OTHERWISE INDICATED ON THESE PLANS AND SPECIFICATIONS.
- 40. CONTRACTOR IS ADVISED THAT THE MAXIMUM PAYMENT DIMENSIONS FOR ACCESS PITS ASSOCIATED WITH LINING OF EXISTING WATER MAINS IS 10-FT BY 10-FT, THE MAXIMUM PAYMENT DIMENSION FOR ACCESS PITS ASSOCIATED WITH HORIZONTAL DIRECTIONAL DRILLING IS 10-FT BY 5-FT, AND THE MAXIMUM PAYMENT DIMENSION FOR ACCESS PITS ASSOCIATED WITH PIPE BURSTING IS 20-FT BY 8-FT, OR AS INDICATED ON THE DRAWINGS. IF CONTRACTOR'S ACCESS PITS EXCEED THESE PLAN AREAS, THE ASSOCIATED RESTORATION TO CONDITIONS STATED ON THE DRAWINGS FOR THESE AREAS OUTSIDE THE MAXIMUM PAYMENT DIMENSIONS WILL BE AT NO COST TO THE OWNER. ALL OTHER RESTORATION LIMITS ARE AS SHOWN ON THE RESTORATION DRAWINGS.
- 41. ACCESS PITS FOR TRENCHLESS INSTALLATIONS SHOWN ON THE DRAWINGS INDICATE THE ANTICIPATED LOCATIONS OF THE PITS BASED ON ENGINEERING JUDGEMENT. HOWEVER, ACTUAL LOCATIONS, NUMBER AND SIZING OF ACCESS PITS SHALL BE DETERMINED BY THE CONTRACTOR AND BASED ON CHOSEN MEANS AND METHODS FOR INSTALLATION OF PROPOSED IMPROVEMENTS. CONTRACTOR IS RESPONSIBLE FOR SIZING, SPACING AND ASSOCIATED RESTORATION OF ACCESS PITS, AT NO ADDITIONAL COST AND TO THE SATISFACTION OF THE OWNER.
- 42. THE CONTRACTOR IS TO COMPLETE ALL SURFACE RESTORATION PRIOR TO SUBSTANTIAL COMPLETION. IF TEMPORARY RESTORATION CONDITIONS EXIST THROUGH THE WINTER, OR LONGER THAN 6 WEEKS, COLD PATCHES/TEMPORARY PAVEMENTS ARE PERMITTED AS DIRECTED BY THE ENGINEER. ALSO REFER TO AGREEMENT BETWEEN OWNER AND CONTRACTOR FOR CONSTRUCTION CONTRACT (STIPULATED PRICE), BOOK 1 OF BIDDING DOCUMENTS CONTRACT TIMES FOR HARD SURFACE RESTORATION.
- 43. COORDINATE SHUTDOWN OF THE EXISTING WATER MAIN WITH THE OWNER/ENGINEER A MINIMUM OF FIVE (5) WORKING DAYS IN ADVANCE. IN ORDER TO MAKE CONNECTION AND INSTALL NEW VALVES, THE EXISTING MAIN MAY ONLY BE SHUT-DOWN FOR A MAXIMUM OF TEN (10) HOURS. NO ADDITIONAL SHUTDOWNS ARE PERMITTED UNLESS APPROVED IN WRITING BY THE OWNER. CONTRACTOR IS NOT ALLOWED TO PROCEED WITH A SHUT-DOWN OF ANY EXISTING WATER MAIN WITHOUT WRITTEN APPROVAL OF THE SHUT-DOWN REQUEST PLAN.
- 44. CONTRACTOR IS RESPONSIBLE FOR ANY NECESSARY REPAIRS TO PRIVATE PROPERTIES THAT ARE MADE TO ACCOMMODATE CONSTRUCTION OF PROPOSED IMPROVEMENTS, AT NO ADDITIONAL COST AND TO THE SATISFACTION OF THE OWNER.
- 45. CONTRACTOR TO PERFORM WORK IN ACCORDANCE WITH THE STANDARD DETAILS AND SPECIFICATIONS INCLUDED IN THE CONTRACT DOCUMENTS.
- 46. STANDARD DETAILS SHOWN ON THE STANDARD DETAIL (SD) DRAWINGS SHALL BE APPLIED FOR ALL NEW CONSTRUCTION.
- 47. DETAILS AND INFORMATION SHOWN ON THE TRAFFIC PLANNING (TP) DRAWINGS SHALL BE APPLIED FOR ALL NEW CONSTRUCTION AND RESTORATION.
- 48. STANDARD DETAILS SHOWN ON THE DRAWING SD-11 SHALL BE APPLIED FOR ALL SERVICE CONNECTIONS CONNECTED TO HDPE WATER MAIN AND CONNECTED TO ISOLATED LENGTHS OF D.I. WATER MAIN (D.I. WATER MAIN CONNECTED TO HDPE WATER MAIN ON BOTH ENDS).

MDEQ SRF Project No. DESIGNED BY SEAL / STAMP DETROIT WATER AND SEWERAGE DEPARTMENT 7483-01 CAPITAL IMPROVEMENT PROGRAM CS-1812 DRAWN BY: CITY OF DETROIT D DWSD CONTRACT No WATER AND SEWERAGE DEPARTMENT DETROIT C WS-715 ENGINEERING DIVISION CHECKED BY: FILE No. В LEGEND, ABBREVIATIONS, AND **Water & Sewerage** 4/27/20 | MANAGER: ISSUED FOR PROCUREMENT DRAWING No. Department **GENERAL NOTES** SECTION MAP PORTION CODE SECTION G-5 | DESCRIPTIONS / REVISIONS | CHK'D | APPR. | DATE

WAYNE COUNTY (W.C.D.P.S.) NOTES

ALL WORK WITHIN WAYNE COUNTY'S JURISDICTION SHALL BE DONE AS DIRECTED BY THE WAYNE COUNTY ENGINEER, CURRENT WAYNE COUNTY SPECIFICATIONS AND STANDARDS SHALL APPLY WHERE DIFFERENT FROM THESE NOTES AT THE TIME OF CONSTRUCTION.

1. TRAFFIC CONTROL NOTES:

- A. SEE TRAFFIC RESTRICTIONS IN SPECIFICATIONS.
- B. ONE LANE OF THROUGH TRAFFIC SHALL BE MAINTAINED IN EACH DIRECTION AT ALL TIMES.
- C. AT SIGNALIZED INTERSECTIONS, WHERE A CENTER LEFT-TURN-LANE IS PROVIDED, ONE LANE OF THROUGH TRAFFIC AND A LEFT-TURN-LANE SHALL BE MAINTAINED IN ALL DIRECTIONS WITHIN 250 FEET OF THESE INTERSECTIONS AT ALL TIMES.
- D. ALL TRAFFIC CONTROL DEVICES SHALL BE MAINTAINED, INSTALLED, AND/OR SALVAGED AND RESET IN ACCORDANCE WITH CURRENT M.D.O.T. STANDARDS AND SPECIFICATIONS.
- E. THE REMOVAL AND INSTALLATION OF PAVEMENT MARKINGS SHALL ALSO CONFORM TO THE CURRENT M.D.O.T. STANDARDS AND SPECIFICATIONS
- F. ALL CHARGES INCURRED BY THE DEPARTMENT TO REPLACE AND/OR MAINTAIN TRAFFIC CONTROL ITEMS REMOVED AND NOT REPLACED BY THE CONTRACTOR, WILL BE BILLED TO THE CONTRACTOR.
- G. ALL CONSTRUCTION STAGING AND TRAFFIC CONTROL DEVICES SHALL BE IN ACCORDANCE WITH THE MICHIGAN MANUAL OF UNIFORM TRAFFIC CONTROL DEVICES (MMUTCD).

2. EXISTING UTILITIES:

- A. ALL UTILITIES, INCLUDING DRAINAGE FACILITIES, SHALL BE LOCATED PRIOR TO EXCAVATION IN THE W.C.D.P.S. RIGHT-OF-WAY.
- B. M.D.O.T. FACILITIES ARE NOT LOCATED THROUGH THE MISS DIG SYSTEM.

3. EXISTING SIGNS:

- A. APPLICABLE WARNING, REGULATORY, AND GUIDE SIGNS SHALL NOT BE REMOVED, BUT SHALL BE RETAINED DURING THE PROGRESS OF THE WORK IN THEIR EXISTING LOCATION UNLESS OTHERWISE DIRECTED BY W.C.D.P.S. OR ITS INSPECTOR.
- B. ALL SIGNS REQUIRING RELOCATION DUE TO THE CONTRACTOR'S OPERATIONS SHALL BE SALVAGED, AS PER THE CURRENT VERSION OF THE M.D.O.T. STANDARD SPECIFICATIONS FOR CONSTRUCTION, AND REINSTALLED BY THE CONTRACTOR AT THE ORIGINAL LOCATION UNLESS OTHERWISE DIRECTED BY M.D.O.T. OR THEIR INSPECTING AGENCY, OR THE COUNTY ENGINEER.
- C. SALVAGED SIGNS SHALL BE RE-INSTALLED NO LATER THAN ONE (1) DAY AFTER THE COMPLETION OF THE WORK OR THIRTY (30) DAYS AFTER THEIR REMOVAL, WHICHEVER OCCURS FIRST.

4. PEDESTRIAN TRAFFIC:

- A. SAFE AND ADEQUATE TRAVEL ROUTE FOR PEDESTRIANS SHALL BE MAINTAINED AT ALL TIMES THROUGHOUT THE PROJECT.
- B. THE CONTRACTOR SHALL SUBMIT A PEDESTRIAN TRAFFIC PLAN TO THE W.C.D.P.S. DISTRICT TRAFFIC AND SAFETY DIVISION FOR REVIEW AND APPROVAL PRIOR TO STARTING CONSTRUCTION.
- C. PEDESTRIANS SHALL NOT BE DETOURED INTO THE EXISTING ROADWAY. INDICATE THE METHODS OF MAINTAINING PEDESTRIAN TRAFFIC THROUGH THE WORK AREA, WHEN APPLICABLE.

5. WAYNE COUNTY DPS GENERAL NOTES:

- A. ALL WORK WITHIN THE WAYNE COUNTY ROAD RIGHT-OF-WAY (ROW) AND DRAIN EASEMENT SHALL BE IN ACCORDANCE WITH THE CURRENT STANDARDS AND GENERAL SPECIFICATION, INCLUDING SOIL EROSION AND SEDIMENTATION CONTROL OF THE WAYNE COUNTY DEPARTMENT OF PUBLIC SERVICES, AND M.D.O.T. 2012, OR LATEST VERSION, SPECIFICATION FOR CONSTRUCTION.
- B. THESE PLANS ARE NOT VALID WITHOUT ATTACHMENT OF THE WAYNE COUNTY PERMIT SPECIFICATIONS FOR CONSTRUCTION WITHIN ROAD ROW, PARKS, DRAIN EASEMENTS OR SANITARY SEWER UNDER THE JURISDICTION OF WAYNE COUNTY. (07/01/93) REVISED 12-15-2004.
- C. CONTRACTOR SHALL CONTACT MISS DIG AT 811 TO IDENTIFY AND FLAG/MARK THE LOCATIONS OF ALL UNDERGROUND UTILITIES AT THE PROPOSED CONSTRUCTION AREAS PRIOR TO START OF CONSTRUCTION, AND SHALL BE RESPONSIBLE FOR DETERMINING THE EXACT LOCATIONS AND ELEVATIONS OF ALL UNDERGROUND UTILITIES, AND RESOLVE ANY CONFLICT BETWEEN THE PROPOSED WORK AND THE EXISTING UNDERGROUND OR ABOVEGROUND UTILITIES.
- D. CONTRACTOR SHALL MAINTAIN 18" MINIMUM VERTICAL CLEARANCE AND 3 FEET MINIMUM HORIZONTAL CLEARANCE BETWEEN THE PROPOSED AND EXISTING UTILITIES. ANY PROPOSED UTILITIES PERMITTED TO CROSS UNDER THE ROAD OR DRAIN, MUST BE PLACED A MINIMUM OF 7 FEET BELOW THE LOWEST POINT OF ROAD, OR 6 FEET BELOW THE DRAIN BOTTOM. OVERHEAD WIRES/CABLES MUST BE INSTALLED 18 FEET MINIMUM ABOVE THE ROAD CENTERLINE. TO RELOCATE ANY UTILITY WITHIN THE ROAD ROW, THE CONTRACTOR SHALL COORDINATE THE RELOCATION WITH THE UTILITY COMPANY AND AS DIRECTED BY THE WAYNE COUNTY ENGINEER.
- E. ALL SURVEY MONUMENTS/CORNERS AND BENCH MARKS LOCATED WITHIN THE CONSTRUCTION AREA MUST BE PRESERVED IN ACCORDANCE WITH PUBLIC ACT 74 AS AMENDED(INCLUDING ACT 34,P.A. 2000) AND AS PER WAYNE COUNTY PERMIT RULE 1.5. THE PERMIT HOLDER AND CONTRACTOR SHALL COORDINATE THE WORK WITH A PROFESSIONAL SURVEYOR LICENSED IN THE STATE OF MICHIGAN DURING CONSTRUCTION ACTIVITIES FOR THE PURPOSE OF WITNESSING PRESERVING OR REPLACING SURVEY MONUMENTS AND MONUMENT BOXES.
- F. EXPOSURE OF ANY UTILITIES UNDER THE PAVEMENT WILL NOT BE PERMITTED, UNLESS APPROVED BY THE WAYNE COUNTY ENGINEER. PAVEMENT REMOVAL AND REPLACEMENT SHALL BE PERFORMED PER APPLICABLE WAYNE COUNTY STANDARD DETAILS AN AS DIRECTED BY THE WAYNE COUNTY ENGINEER.
- G. CONTRACTOR SHALL RESTORE ALL DISTURBED AREAS WITHIN THE WAYNE COUNTY ROAD ROW AND DRAIN EASEMENT WITH 3" TOPSOIL, THM SEED MIX AND MULCH. SLOPES STEEPER THAN 1 ON 3 SHALL BE RESTORED BY PLACING SOD ON 2" TOPSOIL.
- H. ALL BACKFILLS UNDER OR WITHIN 3 FEET OF THE PROPOSED OR EXISTING PAVEMENT, CURB OR SIDEWALK SHALL CONFORM TO THE WAYNE COUNTY TRENCH "B" BACKFILL REQUIREMENTS. TRENCH "A" BACKFILL MAY BE USED WITHIN THE ROAD ROW AREAS UNDER CONDITIONS OTHER THAN THOSE SPECIFIED FOR TRENCH "B".
- I. CONTRACTOR IS RESPONSIBLE FOR RESTORING OR REPLACING ALL DISTURBED LANDSCAPED AREAS, SPRINKLER SYSTEMS, FENCES, SIGNS, MAIL BOXES, ETC. WITHIN THE WAYNE COUNTY ROAD ROW AND/OR AS DIRECTED BY THE COUNTY ENGINEER.
- CONTRACTOR SHALL MAINTAIN TWO-WAY TRAFFIC AT ALL TIMES. OTHERWISE, DETOURING TRAFFIC MUST BE PER APPROVED PLANS. ALL SIGNING AND TRAFFIC CONTROL DEVICES SHALL BE IN ACCORDANCE WITH THE LATEST EDITION OF M.M.U.T.C.D.

- K. BEFORE PLACEMENT OF AGGREGATE BASE, WAYNE COUNTY TESTING AND INSPECTION OFFICE WILL INSPECT THE SUB-BASE AND MAY RECOMMEND UNDERCUTTING, WHICH IS TO BE BACK FILLED WITH APPROVED MATERIAL (C.I.P).
- L. OVERNIGHT VEHICLE PARKING AND STORAGE OF CONSTRUCTION MATERIALS AND EQUIPMENT ARE NOT PERMITTED WITHIN THE WAYNE COUNTY ROADS RIGHT-OF-WAY.
- M. CONTRACTOR SHALL NOTIFY THE WAYNE COUNTY TRAFFIC SIGNAL SHOP AT (734)955-2154 AT LEAST 72 HOURS PRIOR TO START OF WORK AT OR NEAR ANY SIGNALIZED INTERSECTIONS.
- N. CONTRACTOR SHALL NOTIFY WAYNE COUNTY 72 HOURS PRIOR TO START OF CONSTRUCTION. CONTACT FLOYD SPANN AT (734)858-2764.
- O. MAINTAIN A SAFE AND ADEQUATE TRAVEL ROUTE FOR PEDESTRIANS AT ALL TIMES THROUGHOUT THE PROJECT DURATION.
- P. REMOVE ALL ABANDONED UNUSED WATER MAIN FROM THE COUNTY ROADS ROW OR AS DIRECTED BY THE WAYNE COUNTY ENGINEER.
- Q. THE WAYNE COUNTY ENGINEER SHALL DETERMINE IF WEATHER LIMITATIONS ALLOW FOR PAVEMENT REMOVAL AND/OR MAY REQUIRE TEMPORARILY PAVEMENT.
- R. FOR TEMPORARILY PAVEMENT REPLACEMENT OF ROADS AND/OR DRIVE APPROACHES, THE PAVEMENT MUST INCLUDE 3" OF COLD PATCH OR H.M.A. UNTIL PERMANENT REPAIR IS DONE. THESE PAVEMENTS MUST BE MAINTAINED BY PERMIT HOLDER OR THEIR REPRESENTATIVE.
- S. FOR PERMANENT PAVEMENT REPLACEMENT, PROVIDE COLD WEATHER CONCRETE PROTECTION AS SPECIFY PER WAYNE COUNTY SPECIFICATION AND M.D.O.T. REQUIREMENT.

6. WATER MAIN CONSTRUCTION:

- A. ALL OPEN CUTS SHALL BE PLATED DURING NON-WORKING HOURS OR AS DIRECTED BY THE COUNTY ENGINEER.
- B. ALL OPEN CUT TRENCHES WITH VERTICAL FACES GREATER THAN FIVE FEET SHALL HAVE SHORING, BRACING OR BOX TRENCH TO PREVENT TRENCH COLLAPSES AND SHALL MEET M.I.O.S.H.A. STANDARDS.
- C. PROVIDE 7' MIN. COVER FOR PROPOSED WATER MAINS WITHIN W.C. ROAD PAVEMENTS, MEASURED FROM GUTTER LINE. MAINTAIN 7' MIN. ACROSS ROAD TO FARTHER OF 3' BEHIND CURB OR TO STORM SEWER.
- D. WHERE DIRECTED BY COUNTY ENGINEER, JACK AND BORE 20" (DEPENDING ON WATER PIPE SIZE) STEEL CASING HAVING 11/32" WALL THICKNESS (TYP. FOR ALL DRIVES WHERE THERE IS NO. EX. WATER MAIN TO BE REMOVED) LOCATE BORE HOLES AT 10' MIN. FROM E./P.
- E. "TRENCH B BACKFILL "SHALL BE PLACED UNDER AND/OR WITHIN THREE FEET OF PAVEMENT, SIDEWALK OR CURB, WHERE TRENCH IS CONSTRUCTED (SEE ATTACHMENT), AND AS PER W.C.D.P.S. PERMIT
- F. BORE WATER MAIN UNDER ALL TREES. FOR WATER MAIN IN WAYNE COUNTY RIGHT-OF-WAY, SEE " FOR TUNNELING UNDER TREES" IN THE WAYNE COUNTY SPECIFICATIONS. OTHERWISE, USE SPECIFICATIONS USED IN SPECIFICATIONS PORTION OF THE CONTRACT DOCUMENTS.
- G. TRENCHED AREAS SHALL BE PLATED DURING NON-WORKING HOURS. ALL UTILITY CUTS IN LANES OPEN TO TRAFFIC SHALL BE PLATED PRIOR TO THE PLACING OF ASPHALT SURFACE.
- H. PROVIDE 18" (MIN.) VERTICAL CLEARANCE BETWEEN THE PROPOSED WATER MAINS AND ANY OTHER EXISTING UTILITIES OR SEWERS WITHIN THE RIGHT-OF-WAY.
- ANY WATER MAIN OR STRUCTURE THAT IS TO BE ABANDONED WITHIN THE WAYNE COUNTY R.O.W. MUST BE REMOVED COMPLETELY.
- J. ALL PROPOSED ABANDON WATER MAIN LINES TO BE FILLED WITH FLOWABLE FILL MATERIAL PER WAYNE COUNTY SPECIAL PROVISION FOR FLOWABLE FILL (WC206A) OR AS DIRECTED BY THE COUNTY ENGINEER.
- K. CONCRETE SHALL NOT BE PLACED DIRECTLY UPON A FROZEN SUBGRADE. THE SUBGRADE SHALL BE COVERED WITH A LAYER OF STRAW OR HAY 12 INCHES IN THICKNESS TO PROTECT AGAINST FREEZING. SUBGRADE IS TO BE CLEANED OF ALL LOOSE STRAW BEFORE PLACING CONCRETE. CONCRETE SHALL BE COVERED WITH STRAW, HAY OR PROTECTIVE COVERING, AS SPECIFIED BY THE ENGINEER AND SHALL REMAIN IN PLACE UNTIL THE CONCRETE HAS DEVELOPED A COMPRESSIVE STRENGTH OF NOT LESS THAN 3,000 PSI OR FOR A MINIMUM PERIOD OF 14 DAYS.

7. UTILITY NOTES:

- A. ALL DISTURBED UTILITIES MUST BE REPLACED OR RELOCATED AS DIRECTED BY THE COUNTY ENGINEER & THE UTILITY COMPANY REPRESENTATIVE.
- B. THE CONTRACTOR IS RESPONSIBLE FOR AVOIDING ANY CONFLICT BETWEEN THE PROPOSED WATER MAINS AND ANY EXISTING UTILITY.
- C. ALL PROPOSED UTILITIES WITHIN WAYNE COUNTY ROAD R.O.W. SHALL BE PLACED PER WAYNE COUNTY TRENCH DETAILS "S-12" & "S-13", OR AS DIRECTED BY THE COUNTY ENGINEER.

8. SECTION CORNERS

- A. SECTION CORNERS, IF DISTURBED DURING CONSTRUCTION OR DUE TO CONSTRUCTION ACTIVITIES, SHALL BE RESET AND REWITNESSED IN ACCORDANCE WITH MICHIGAN COMPILED LAW, CHAPTER 54.
- B. SECTION CORNER WITNESS POINTS SHALL BE PROTECTED AT ALL TIMES. IF DISTURBED, THEY SHALL BE RESTORED IN ACCORDANCE WITH STATE OF MICHIGAN LAW.
- C. SALVAGE OR REPLACE THE MONUMENT BOXES OF DISTURBED SECTION CORNERS AS DIRECTED BY THE COUNTY ENGINEER.

9. WAYNE COUNTY DPS ROAD PAVEMENT AND DRIVE APPROACH RECONSTRUCTION NOTES:

- A. SAW-CUT FULL DEPTH THE EXISTING PAVEMENT TO THE NEAREST JOINT WITHIN WAYNE COUNTY ROAD RIGHT-OF-WAY AND REMOVE THE EXISTING PAVEMENT AND CURB OR AS DIRECTED BY WAYNE COUNTY ENGINEER.
- B. CONSTRUCT WAYNE COUNTY ROAD PAVEMENT PER WAYNE COUNTY STANDARDS DETAIL "PR-I" OR "PR-2" AS APPLICABLE, OR AS DIRECTED BY THE WAYNE COUNTY ENGINEER.
- C. PLACE 9" OF 21AA AGGREGATE COMPACTED TO MINIMUM 95% DENSITY OF MAXIMUM UNITE WEIGHT OR AS DIRECTED BY WAYNE COUNTY ENGINEER.
- D. CONSTRUCT WAYNE COUNTY ROAD PAVEMENT REPAIR WITH MINIMUM 2" H.M.A. TOP (F) ON MINIMUM 10" NON-REINFORCED CONCRETE WC 35 P MIX (3500 PSI AT 28 DAYS) AND INTEGRAL STRAIGHT CURB TYPE "4" AS PER WAYNE COUNTY STANDARDS DETAIL "RS-3" OR AS DIRECTED BY WAYNE COUNTY ENGINEER.
- E. TIE THE NEW PAVEMENT TO THE EXISTING PAVEMENT WITH #5 EPOXY COATED THE BARS AT MAXIMUM 43-INCH ON CENTER LONGITUDINALLY AND AT 18-INCH ON CENTER TRANSVERSELY AS PER WAYNE COUNTY STANDARDS DETAIL "RS-2" OR AS DIRECTED BY THE COUNTY ENGINEER.
- F. PLACE THE CONSTRUCTION JOINTS OF THE NEW PAVEMENT TO MATCH THE EXISTING PAVEMENT JOINTS OR AS DIRECTED BY WAYNE COUNTY ENGINEER.
- G. REPLACE ANY DAMAGED CURB AS A RESULT OF THIS PROJECT ACTIVITY AS PER WAYNE COUNTY STANDARD DETAIL "D-7" OR AS DIRECTED BY THE COUNTY ENGINEER.
- H. ANY DAMAGED UNDERDRAIN AS A RESULT OF THIS PROJECT ACTIVITY SHALL BE RECONSTRUCTED AS PER WAYNE COUNTY STANDARD DETAIL "S-14" OR AS DIRECTED BY THE COUNTY ENGINEER.
- I. ANY DAMAGED SIDEWALK AS A RESULT OF THIS PROJECT ACTIVITY SHALL BE RECONSTRUCTED AS PER
- WAYNE COUNTY DETAILS "RS-5" OR AS DIRECTED BY THE COUNTY ENGINEER.

 .. MAINTAIN 2% MAXIMUM TRANSVERSAL SLOPE ON THE SIDEWALK.
- M. ANY DAMAGED SIDEWALK RAMPS SHOULD BE REPLACED TO MATCH THE ADA REQUIREMENTS AS PER M.D.O.T STANDARDS DETAIL "R-28-I" ON SHEETS SD-8 AND SD-9.
- N. STRUCTURE ADJUSTMENT SHALL BE DETERMINED AT THE SITE BY WAYNE COUNTY ENGINEER.
- N. STRUCTURE ADJUSTMENT SHALL BE DETERMINED AT THE SITE BY WAYNE COUNTY ENGINEER.
- O. RELOCATE, RESTORE OR REPLACE ANY TRAFFIC SIGNS THAT ARE AFFECTED BY THIS CONSTRUCTIONS AS DIRECTED BY THE COUNTY ENGINEER.
- P. CURB HEIGHT ADJUSTMENT WILL BE DETERMINED AT SITE AS DIRECTED BY THE WAYNE COUNTY ENGINEER TO MAINTAIN A POSITIVE FLOW FOR OVER CURB DRAINAGE.
- Q. FOR COMMERCIAL DRIVE APPROACHES RECONSTRUCT THE EXISTING DRIVE APPROACH OPENING PER WAYNE COUNTY STANDARDS DETAILS "D-6" OR AS DIRECTED BY WAYNE COUNTY ENGINEER.
- R. ANY DAMAGED STRUCTURE AS RESULT OF THIS CONSTRUCTION ACTIVITY SHALL BE ADJUSTED AND/OR RECONSTRUCTED AS DIRECTED BY THE WAYNE COUNTY ENGINEER.

10. WAYNE COUNTY COMMERCIAL DRIVE APPROACH CONSTRUCTION NOTES:

- A. SAW CUT FULL DEPTH OF THE EXISTING PAVEMENT AT 12" FROM BACK OF CURB AND REMOVE PAVEMENT, CURB AND CURB DROP OR AS DIRECTED BY WAYNE COUNTY ENGINEER.
- B. CONSTRUCT THE DRIVE APPROACH OPENING PER WAYNE COUNTY STANDARDS DETAILS "D-6" OR AS DIRECTED BY WAYNE COUNTY ENGINEER.
- C. CONSTRUCT CURB AND CURB DROP PER WAYNE COUNTY STANDARDS DETAILS "D-7" OR AS DIRECTED BY WAYNE COUNTY ENGINEER.
- D. PLACE MINIMUM 6" OF 21AA BASE COURSE AGGREGATE COMPACTED IN PLACE TO 95% MAXIMUM DENSITY OF ITS UNIT WEIGHT UNDER THE PROPOSED DRIVE APPROACH OR AS DIRECTED BY WAYNE COUNTY ENGINEER.
- E. CONSTRUCT THE DRIVE APPROACH WITH 8" NON-REINFORCED CONCRETE P1 MIX AND INTEGRAL STRAIGHT CURB TYPE "3" AS PER WAYNE COUNTY STANDARDS DETAIL "RS-3" OR AS DIRECTED BY WAYNE COUNTY ENGINEER.
- F. DROP CURB TO ZERO HEIGHT AT FACE OF SIDEWALK.
- G. PLACE 1" EXPANSION JOINT BEHIND THE CURB THROUGHOUT THE DRIVE APPROACH OR AS DIRECTED BY WAYNE COUNTY ENGINEER.
- H. CONSTRUCT THE SIDEWALK THROUGHOUT THE DRIVE APPROACH WITH 8" NON REINFORCED CONCRETE PER WAYNE COUNTY STANDARDS DETAILS "RS-5" OR AS DIRECTED BY WAYNE COUNTY ENGINEER.
- I. MAINTAIN MAX 2% TRANSVERSAL SLOPE ON THE SIDEWALK
- J. PLACE 12" EXPANSION JOINT AT SIDEWALK FACES.
- K. STRUCTURE ADJUSTMENT SHALL BE DETERMINED AT THE SITE BY WAYNE COUNTY ENGINEER
- L. RECONSTRUCT EXISTING DISTURBED RESIDENTIAL DRIVE APPROACH PER WAYNE COUNTY STANDARD DETAIL "D-1" AND/OR AS DIRECTED BY THE WAYNE COUNTY ENGINEER.

11. PIPE BURSTING NOTES:

- A. THE CONTRACTOR IS TO EXERCISE DUE CARE AND CAUTION TO PROTECT COUNTY FACILITIES FROM DAMAGE DURING THE PIPE BURSTING OPERATION. THE PERMIT HOLDER AND CONTRACTOR SHALL BE RESPONSIBLE FOR ANY AND ALL DAMAGES THAT COUNTY FACILITIES SUSTAIN AS A RESULT OF PIPE BURSTING OPERATION. REPAIR OF ANY FACILITIES SHALL BE AS DETERMINED BY THE COUNTY ENGINEER.
- B. THE CONTRACTOR IS TO CLOSELY MONITOR THE AFFECTS THE PIPE BURSTING HAS ON OTHER UTILITIES WITHIN THE CONSTRUCTION INFLUENCE AREA. THE REPAIR OF ANY DAMAGES TO OTHER FACILITIES SHALL BE THE RESPONSIBILITY OF THE PERMIT HOLDER/CONTRACTOR.
- C. SHOULD ANYTHING PREVENT THE COMPLETION OF THE INSTALLATION OF THE WATER MAIN USING THE PIPE BURSTING METHOD, THE REMAINDER OF THE WATER MAIN SHALL BE CONSTRUCTED BY METHODS APPROVED BY THE WAYNE COUNTY ENGINEER.
- D. PIPE FOR PIPE BURSTING SHALL BE FUSABLE PVC (AWWA C903), DUCTILE IRON PIPE SIZE, DR-18, 235 PSI, WITH BUTT FUSED JOINTS PER SECTION 33 0523 PIPE BURSTING.
- E. TRACER WIRE SHALL BE INSTALL ON ALL WATER MAIN.
- F. CONTRACTOR SHALL POTHOLE, LOCATE, AND OBTAIN ELEVATION OF GAS MAIN, GAS SERVICE, WATER MAIN, WATER SERVICES, SEWERS, UNDERGROUND TELEPHONE, ELECTRIC, CABLE TV AND ALL OTHER BURIED UTILITEIS PRIOR TO BEGINNING PIPE BURSTING WORK. SEE PIPE BURSTING SPECIFICATIONS FOR REQUIREMENTS FOR BORE PATH PLANNING.
- G. WATER SERVICES CONNECTED TO PVC WATER MAINS SHALL USE BRONZE, FULLY CIRCULAR SERVICE SADDLES PER SPECIFICATION SECTION 33 1100. WATER SERVICE CONNECTIONS LARGER THAN 1" ON PIPE BURST WATER MAINS REQUIRE A RESTRAINING HARNESS.
- H. IF THE ROAD PAVEMENT HEAVED/DAMAGED, THE CONTRACTOR IS REPONSIBLE TO RECONSTRUCT THE ROAD PAVEMENT PER NOTES & DETAILS SHOWN AND MUST STOP THIS METHOD AND CHOOSE ANOTHER METHOD OF WATERMAIN REPLACEMENT AS DIRECTED BY THE WAYNE COUNTY ENGINEER. CONTRACTOR IS RESPONSIBLE FOR ANY DAMAGE TO ROADS, SIDEWALKS, TREES, SIGNAGE AND DRIVEWAYS AS A RESULT OF PIPE BURSTING AND/OR CONTRACTOR OPERATIONS.

THE FOLLOWING WAYNE COUNTY STANDARD DETAILS APPLY TO WAYNE COUNTY ROADS IN THIS CONTRACT. THESE DETAILS MAY BE OBTAINED ONLINE AT:

https://www.waynecounty.com/departments/publicservices/engineering/construction-permit.aspx

- D-6 Commercial Driveway Approach
- D-7 Curb Detail A, B & C, Concrete Curb Cap, Integral Curb And Walk
- P-1 Primary Road Class "A" Cross Section
- P-5 Joint Layout
- PR-1 Pavement Repair Patching Class "A" Road (Under 20 Years Old)
- PR-2 Pavement Repair Patching Class "A" Road (Over 20 Years Old)
- RS-1 General Notes
- RS-2 Pavement Joints
- RS-3 Curb & Gutter Details
 RS-5 Concrete Sidewalk
- S-1 General Notes Storm Drainage
- S-2 Manhole A
- S-3 Manhole B S-5 Manhole D
- S-6 Catch Basin A
- S-7 Inlet A S-12 Sewer Trench A & B
- S-13 Sewer Trench D Culvert Installation

S-16 Frame And Cover S

- S-14 Underdrain
 S-15 Frame And Cover A, Cover C
- S-17 Concrete Cradle, Cast Iron Trap

PRE CONSTRUCTION MEETING
A PRE-CONSTRUCTION MEETING SHALL
BE REQUIRED PRIOR TO COMMENCING
THE ROAD PAVING ACTIVITY.

MDEQ SRF Project No. DESIGNED BY: SEAL / STAMP DETROIT WATER AND SEWERAGE DEPARTMENT 7483-01 REF. No. CAPITAL IMPROVEMENT PROGRAM CS-1812 DRAWN BY: CITY OF DETROIT D DWSD CONTRACT No WATER AND SEWERAGE DEPARTMENT DETROIT WS-715 ENGINEERING DIVISION CHECKED BY: FILE No. WAYNE COUNTY NOTES **Water & Sewerage** 4/27/20 MANAGER: ISSUED FOR PROCUREMENT DRAWING No. Department SECTION MAP PORTION CODE SECTION G-6 DESCRIPTIONS / REVISIONS | CHK'D | APPR. | DATE

SOIL EROSION AND SEDIMENTATION CONTROL

- 1. THE CONTRACTOR'S ATTENTION IS DIRECTED TO THE EROSION CONTROL SEDIMENTATION AND CONTAINMENT OF CONSTRUCTION DETAILS SPECIFICATION 01 57 13, IN THE CONTRACT DOCUMENTS, WHERE REFERENCE IS MADE TO THE CONTRACTOR'S RESPONSIBILITIES CONCERNING THIS MATTER.
- 2. THE CONTRACTOR SHALL ARRANGE HIS CONSTRUCTION OPERATIONS IN SUCH A MANNER THAT THE CONSTRUCTION AREA WILL NOT BE SUSCEPTIBLE TO SOIL EROSION AND THAT THE CONSTRUCTION OPERATIONS WILL NOT CREATE ANY SILTATION PROBLEMS.
- 3. THE CONTRACTOR SHALL EMPLOY NECESSARY MEANS AND METHODS TO PREVENT EXCAVATED AND LOOSE SOIL MATERIAL FROM BEING COLLECTED ON TIRES OF TRUCKS AND OTHER EQUIPMENT AND BEING DEPOSITED ON STREETS AND ROADS TO AND FROM THE CONSTRUCTION SITE.
- 4. THE CONTRACTOR SHALL CONTROL DUST AT THE CONSTRUCTION SITE AND ON THE PUBLIC STREETS USED AS HAUL ROADS. THE CONTRACTOR SHALL BE FAMILIAR WITH AND FOLLOW THE REGULATIONS OUTLINED BY THE CITY OF DETROIT FUGITIVE DUST ORDINANCE NO. 32-17 CHAPTER 22, ARTICLE 5.
- 5. THE DISTANCE BETWEEN THE POINT OF COMPLETE BACK FILLING AND THE PIPE LAYING SHALL NOT EXCEED 40 FEET.
- 6. THE CONTRACTOR SHALL EMPLOY POSITIVE MEANS TO PREVENT SOIL AND OTHER DEBRIS FROM ENTERING THE EXISTING STREET DRAINAGE SYSTEM. THE EXISTING CATCH BASIN AND DRAIN SYSTEM IS THE CONTRACTOR'S RESPONSIBILITY TO MAINTAIN TO AT LEAST THE CONDITIONS PRIOR TO CONSTRUCTION.
- 7. IN ADDITION TO THE ABOVE REQUIREMENTS, THE CONTRACTOR'S ATTENTION IS DIRECTED SPECIFICALLY TO DIVISION 14F, "EROSION CONTROL PROGRAM" OF THE CITY ENGINEERING DEPARTMENT'S CURRENT "STANDARD SPECIFICATIONS FOR PAVING AND RELATED CONSTRUCTION" LOCATED AT: https://detroitmi.gov/document/standard-specifications-paving-and-related-construction
- 8. THE CONTRACTOR SHALL PERFORM ALL ACTIVITIES NECESSARY TO COMPLY WITH THE TEMPORARY EROSION AND SEDIMENT CONTROL SPECIFICATION AND THE CITY ENGINEERING EROSION CONTROL PROGRAM.
- 9. PERMITTEE AND CONTRACTORS ARE SUBJECT TO: PUBLIC ACT 451 OF 1994, AS AMENDED PART 201. IN THE EVENT OF EXCAVATION ENCOUNTERING ENVIRONMENTAL CONTAMINATION OR AN UNDERGROUND TANK IN MDOT AND/OR OTHER PROJECT RIGHT OF WAY, WORK WITHIN THE RIGHT OF WAY SHALL CEASE UNTIL ALL ACTIONS/NOTIFICATIONS SPECIFIED BY PART 201 HAVE BEEN COMPLETED.
- 10. REFER TO SHEETS SD-4 AND SD-5 FOR SOIL EROSION AND SEDIMENTATION CONTROL DETAILS.
- 11. ALL SOIL EROSION AND SEDIMENTATION CONTROL WORK IS CONSIDERED INCIDENTAL TO THE CONTRACT, WITH THE EXCLUSION OF THE GREEN STORMWATER INFRASTRUCTURE WORK.

C.E.D. NOTES

CITY OF DETROIT, DPW, CITY ENGINEERING DIVISION REQUIREMENTS

- 1. THE CONTRACTOR SHALL OBTAIN A CITY OF DETROIT STREET RIGHT-OF-WAY PERMIT FROM THE INSPECTION PERMIT OFFICE OF THE ENGINEERING DIVISION.
- 2. THE CONTRACTOR SHALL COMPLY WITH ALL THE CITY ENGINEERING DIVISION STREET RIGHT-OF-WAY PERMIT REQUIREMENTS.
- 3. NEW GATE VALVE WELLS, FIRE HYDRANTS AND ANY SURFACE ITEMS SHALL NOT BE LOCATED IN SIDEWALK RAMPS, LANDINGS AND/OR CROSSWALKS.
- 4. ALL NEWLY CONSTRUCTED OR RECONSTRUCTED SIDEWALKS IN THE CITY OF DETROIT'S RIGHT-OF-WAY, SHALL HAVE A MAXIMUM 2% CROSS-SLOPE. IN ADDITION THERE SHALL BE A SUFFICIENT SLOPE ON THE SIDEWALK TO ASSURE DRAINAGE TO THE STREET (TRY TO MAINTAIN AT LEAST A 1% SLOPE IN THE DIRECTION OF FLOW).
- 5. THE CONTRACTOR IS REQUIRED TO MEET D.P.W. ROADWAY PATCHING AND SIDE WALK PATCHING PER DIVISION 15 AND AS DETAILED IN THESE PLANS, AND ADA RAMP DETAILS PER MDOT STANDARD PLAN R-28-SERIES.
- 6. THE CONSTRUCTION CONTRACTOR NEEDS TO SUBMIT THE CONSTRUCTION PHASING AND DURATION OF EACH PHASE IN ORDER TO MINIMIZE THE IMPACT TO VEHICULAR AND PEDESTRIAN TRAFFIC.
- 7. WHENEVER SIDEWALKS ARE CLOSED, PEDESTRIAN DETOUR SIGNS NEED TO BE POSTED.

PRE CONSTRUCTION MEETING

A PRE-CONSTRUCTION MEETING SHALL BE REQUIRED PRIOR TO COMMENCING THE ROAD PAVING ACTIVITY.

TO REPORT AN EMERGENCY FIELD CONDITION CALL:

DTE ENERGY ELECTRICAL(800) 477-4747	
INTERNATIONAL TRANSMISSION CO(877) 482-4829	
DETROIT PUBLIC LIGHTING AUTHORITY(313) 324-8290	
DETROIT WATER & SEWERAGE DEPT(313) 267-8000	
DTE ENERGY GAS(800) 947-5000	
CONSUMERS ENERGY GAS(800) 477-5050	
SUNOCO PIPELINE LP(313) 969-9478/(313) 590-9598/(313) 215-1843	
SBC/AT&T (800) 288-2020	
COMCAST CABLE (800) 934-6489	

(313) 628-5627

CONTROL POINTS										
Point #	Elevation	Northing	Easting							
CP-200	149.90	332784.35	13423666.66							
CP-201	150.16	332431.20	13423666.76							
CP-202	152.62	333573.26	13421639.79							
CP-203	152.90	333576.42	13421616.00							
CP-204	151.19	334099.49	13423580.36							
CP-205	151.57	334278.30	13423602.64							
CP-206	164.74	333641.14	13423603.63							
CP-207	159.13	333732.09	13423626.60							
CP-208	144.07	333869.60	13419613.39							
CP-209	143.89	333836.07	13419619.53							
CP-210	139.01	334073.66	13419477.12							
CP-211	131.77	334374.19	13419436.00							
CP-5000	131.02	334715.68	13419509.23							
CP-5001	132.52	334218.85	13419432.66							
CP-5002	144.05	333859.75	13419610.73							
CP-5003	150.53	335134.69	13420871.94							
CP-5004	151.40	334660.94	13420894.64							
CP-5005	152.15	333962.94	13420927.04							
CP-5006	155.12	333333.57	13420962.55							
CP-5007	158.04	332860.16	13420919.21							
CP-5008	155.70	332742.41	13421078.83							
CP-5009	150.78	332681.23	13421640.87							
CP-5010	154.44	333606.19	13421599.76							
CP-5011	150.61	334655.04	13422274.14							
CP-5012	146.95	334007.18	13422306.92							
CP-5013	148.45	334013.55	13422897.85							
CP-5014	149.06	335130.18	13422857.42							
CP-5015	147.85	334802.87	13422872.62							
CP-5016	152.29	333035.92	13423014.54							
CP-5017	150.61	332877.41	13423022.77							
CP-5018	146.85	334122.19	13424631.61							
CP-5019	146.77	333596.97	13424715.61							
CP-5020	146.28	333073.14	13424740.40							

	CONTR	OL POIN	ΓS	
Point #	Elevation	Northing	Easting	
CP-5022	P-5022 150.63		13425588.16	
CP-5023	149.26	333494.87	13425557.63	
CP-5024	150.23	333932.34	13425594.24	
CP-5025	151.85	334340.20	13425516.45	
CP-5026	149.81	335103.39	13425541.09	
CP-5027	150.99	334758.63	13425554.53	
CP-5028	152.55	334301.25	13425878.13	
CP-5029	150.19	333436.76	13425873.56	
CP-5030	150.94	332847.45	13425946.06	
CP-5031	150.44	332790.59	13426250.09	
CP-5032	150.22	333537.34	13426205.60	
CP-5033	147.46	332225.02	13426541.33	
CP-5034	151.12	332884.22	13426501.52	
CP-5035	150.78	333483.57	13426467.53	
CP-5036	151.32	333827.69	13426488.59	
CP-5037	152.36	332698.31	13428939.50	
CP-5038	151.82	332278.72	13428959.91	
CP-5039	151.01	331650.02	13428987.45	
CP-5040	150.38	330963.03	13428970.51	
CP-5041	150.23	330346.59	13429002.75	
CP-5042	149.46	329405.36	13429072.77	
CP-5043	152.02	332516.49	13429272.99	
CP-5044	151.34	331662.48	13429313.88	
CP-5045	150.79	330940.20	13429347.26	
CP-5046	150.32	330380.50	13429374.28	
CP-5047	149.88	329502.75	13431000.27	
CP-5048	150.27	329522.85	13431382.38	
CP-5049	149.21	328690.95	13432644.71	
CP-5050	149.19	327863.43	13432685.75	
CP-5051	152.37	330260.86	13433420.87	
CP-5052	151.31	329568.24	13433454.40	
CP-5053	150.17	328679.10	13433497.79	
CP-5054	149.38	327906.55	13433536.16	
CP-6000	149.00	333961.49	13422901.98	



F					DESIGNED BY:	SEAL / STAMP
Е						
D					DRAWN BY:	
С					CHECKED BY:	
В					CHECKED BY.	
Α	ISSUED FOR PROCUREMENT			4/27/20	MANAGER:	
	DESCRIPTIONS / REVISIONS	CHK'D	APPR.	DATE		

DETROIT WATER AND SEWERAGE DEPARTMENT CAPITAL IMPROVEMENT PROGRAM

DPW TRAFFIC SIGNAL CONDUIT

SOIL EROSION & SEDIMENTATION CONTROL NOTES, C.E.D. NOTES AND CONTROL POINTS




SECTION MAP

CITY OF DETROIT WATER AND SEWERAGE DEPARTMENT

ENGINEERING DIVISION

TO	TOWN RANGE		s	ECTIC	N	PORTION CODE				
1	S	1	0	Е	0	1	5	-	_	_

MDEQ SRF Project No.	
	7483-01
REF. No.	00.4040
	CS-1812
DWSD CONTRACT No.	
	WS-715
FILE No.	
	-
DRAWING No.	
	\sim 7
	G-7

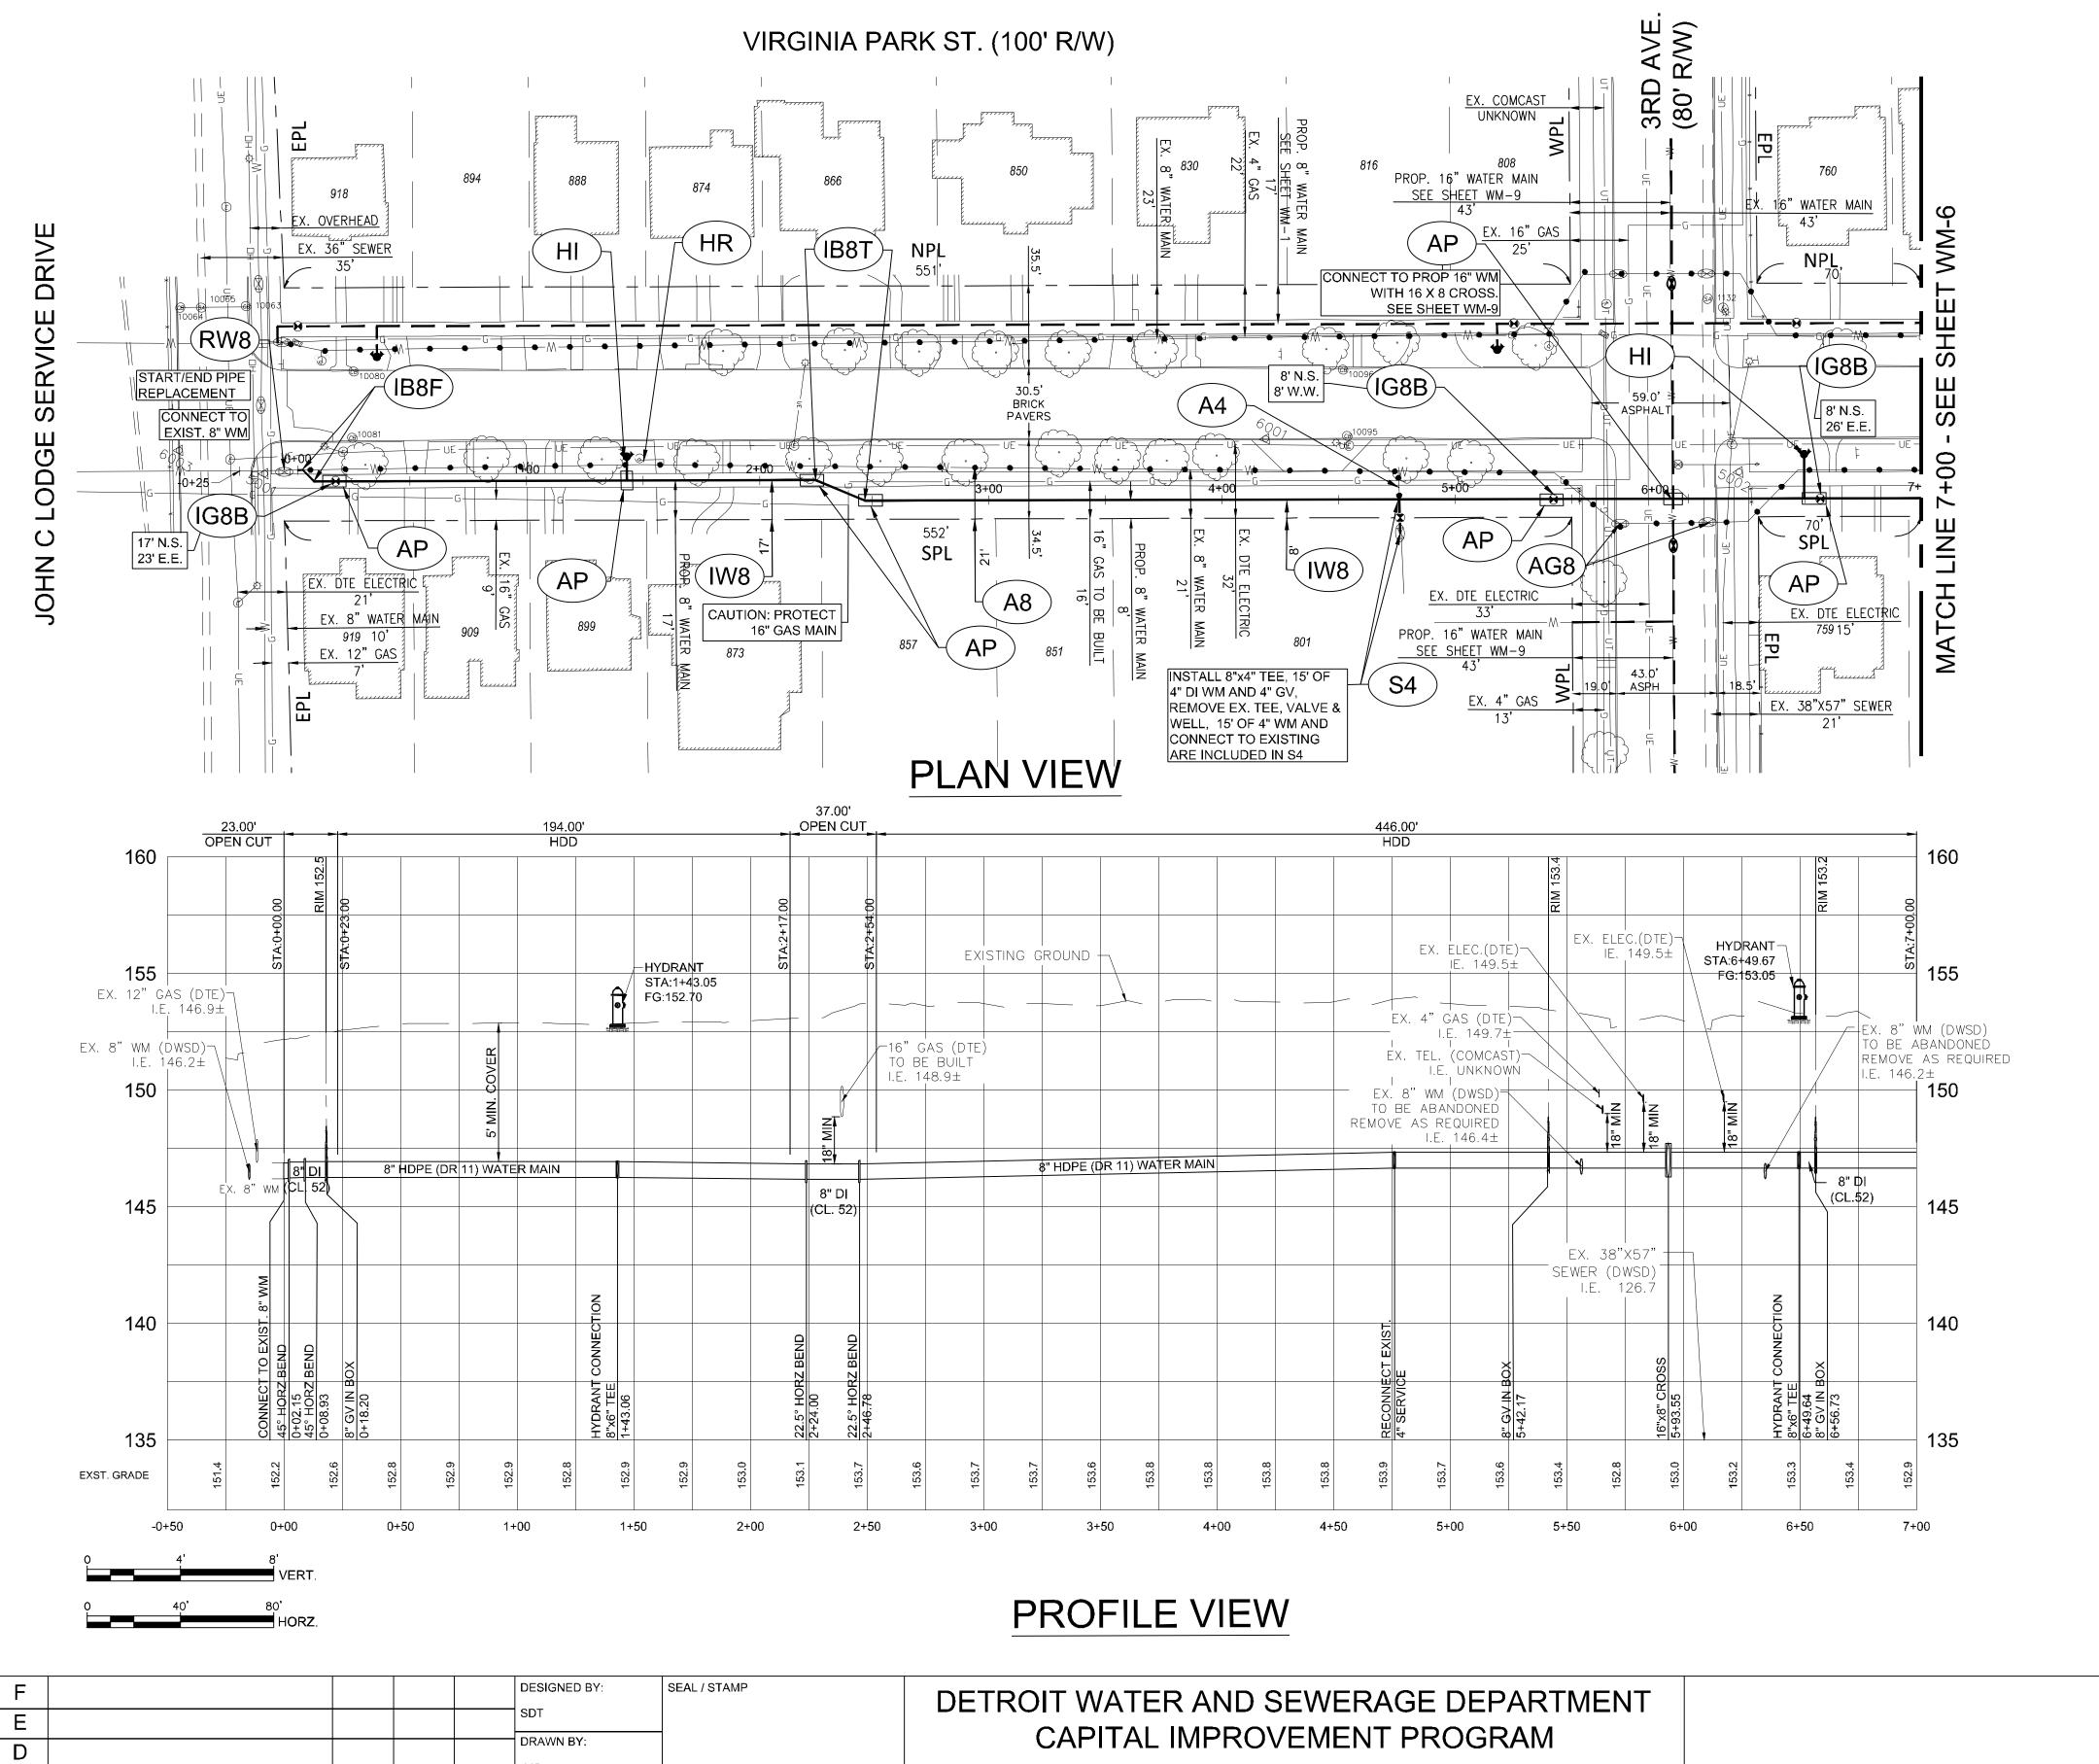

VIRGINIA PARK ST. S WTR. MAIN REPLACEMENT

JOHN C LODGE SERVICE DR. TO STA. 7+00

С

В

A ISSUED FOR PROCUREMENT

| DESCRIPTIONS / REVISIONS | CHK'D | APPR. | DATE

CHECKED BY:

5/4/20 | MANAGER:

KEYED NOTES:

(A8) ABANDON EXIST. 8-INCH WATER MAIN.

(A4) ABANDON EXIST. 4-INCH SERVICE.

AG8 REMOVE EXISTING 8-INCH GATE VALVE & ABANDON WELL AS DIRECTED BY THE ENGINEER.

(AP) ACCESS PIT.

INSTALL NEW 6-INCH FIRE HYDRANT.

REMOVE EXISTING 6-INCH HYDRANT.

B8F) INSTALL 8" - 45° BEND.

IB8T) INSTALL 8" - 22.5° BEND.

IG8B INSTALL 8" DWSD GATE VALVE IN VALVE BOX.

 $\mathsf{W8}$) INSTALL 8-INCH WATER MAIN.

REMOVE EXIST. 8-INCH GATE VALVE & WELL AS DIRECTED BY THE ENGINEER.

S4 RECONNECT EXIST. 4-INCH SERVICE.

SEWER STRUCTURE DETAILS

POINT#	COMPASS	SIZE "	MATERIAL	RIM	I.E.	SURVEYOR'S NOTES
10063	E	12	BRICK	151.09	141.9	
10064			BRICK	151.15	142.5	NO PIPES VISIBLE : BOLTED SHUT
10065			BRICK	151.4		NO PIPES VISIBLE: BOLTED SHUT
10080			CONC	150.42		NO PIPES VISIBLE: FULL OF WATER
10081			CONC	150.54		NO PIPES VISIBLE: FULL OF WATER
10095				151.61		NO PIPES VISIBLE
10096				151.5		NO PIPES VISIBLE
1132	NW	54	BRICK	152.45	132.3	
1132	SW	54	BRICK	152.45	132.3	

	APPROXIMATE NUI						
	1" OR LARGER COPPER SERVICES TO BE	BE REPLACED WITH 1	M MAIN TO CURB BOX TO " OR LARGER COPPER VICE	LEAD SERVICES TO BE REPLACED FROM CURB BOX TO METER	GROUNDING CONNECTIONS		
	RECONNECTED	COPPER LEAD		WITH 1" OR LARGER COPPER SERVICE	CONNECTIONS		
NORTH	-	-	-	-	7		
SOUTH	-	-	5-1",1-3/4"	1"-175'	7		

NOTES:

- 1. THE LOCATION OF SEWER LEADS FROM CATCH BASINS ARE NOT KNOWN. NEW WATER MAIN SHALL BE INSTALLED MEETING THE CLEARANCES INDICATED IN NOTES #24 & 28 ON SHEET G-5.
- 2. USE PIPE DEFLECTIONS AND/ OR BENDS TO MAINTAIN CLEARANCES INDICATED IN NOTES #24 & 28 ON SHEET G-5, WHERE NECESSARY.
- 3. USE VERTICAL BENDS TO GO UNDER EXISTING UTILITIES, AS NEEDED.
- 4. CONTRACTORS ARE ALLOWED TO OPERATE 16" AND SMALLER GATE VALVES. CONTRACTORS SHALL SUBMIT A SHUTDOWN REQUEST SKETCH FOR PLAN OF WATER MAIN SHUTDOWNS FOR THE AREA OF WORK.



	CITYOF DETROIT
	DETROIT Water & Sewerage Department
F	


	R
CITY OF DETROIT	
WATER AND SEWERAGE DEPARTMENT	D'
ENGINEERING DIVISION	


	7483-01
REF. No.	CS-1812
DWSD CONTRACT No.	WS-718
FILE No.	_
DRAWING No.	

MDEQ SRF Project No.

ivi	Departme	nt											
S	ECTION N	1AP	ТО	WN	ı	RANGE	Ξ	s	ECTIC	N	POR	TION C	ODE
	0	М	1	s	1	1	E	0	3	6	_	_	-

WM-5

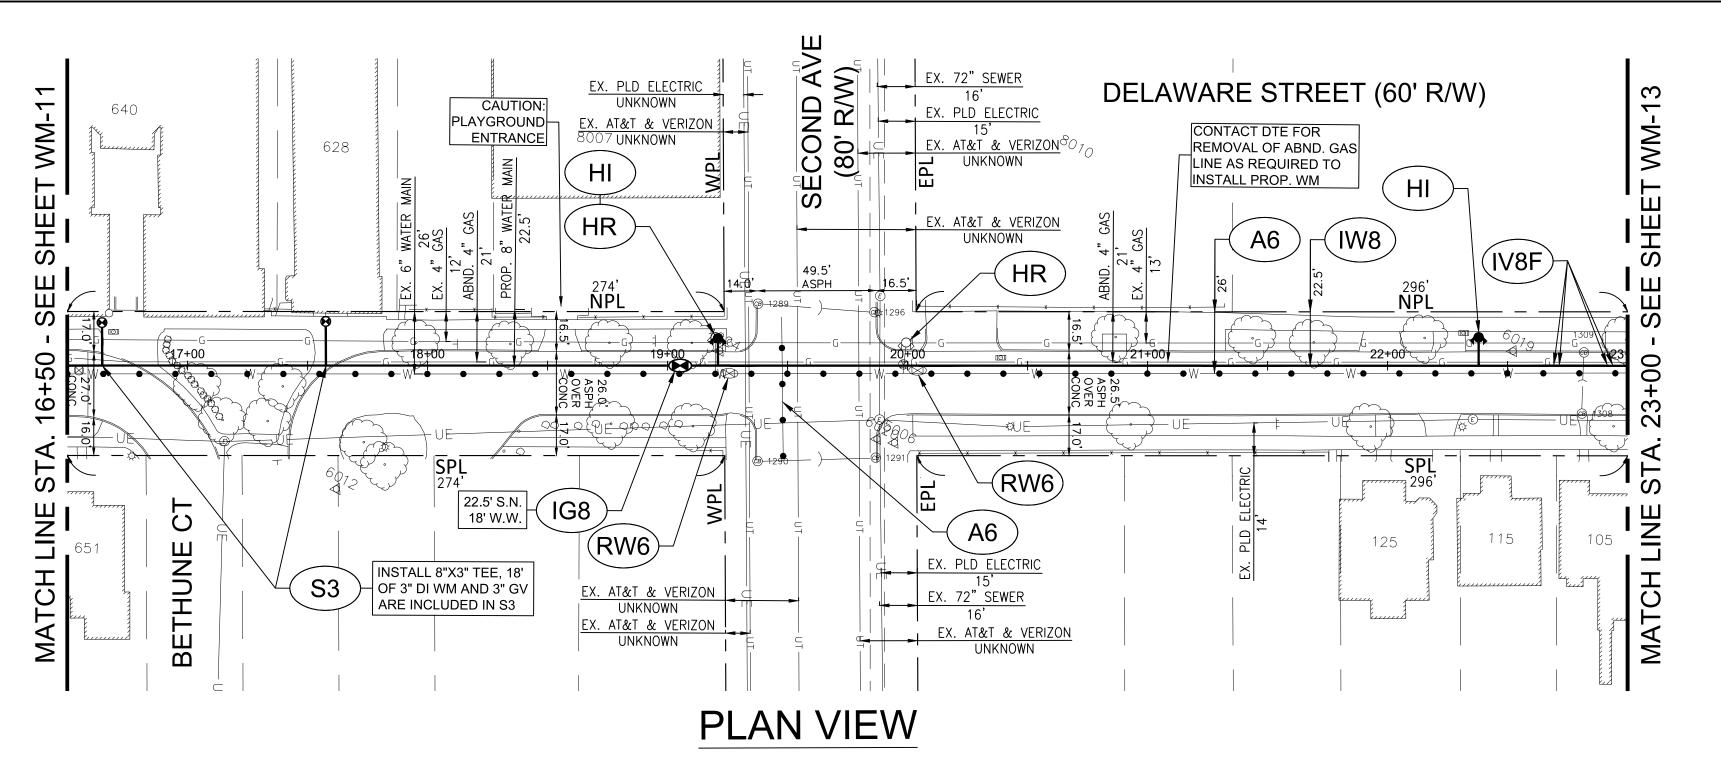

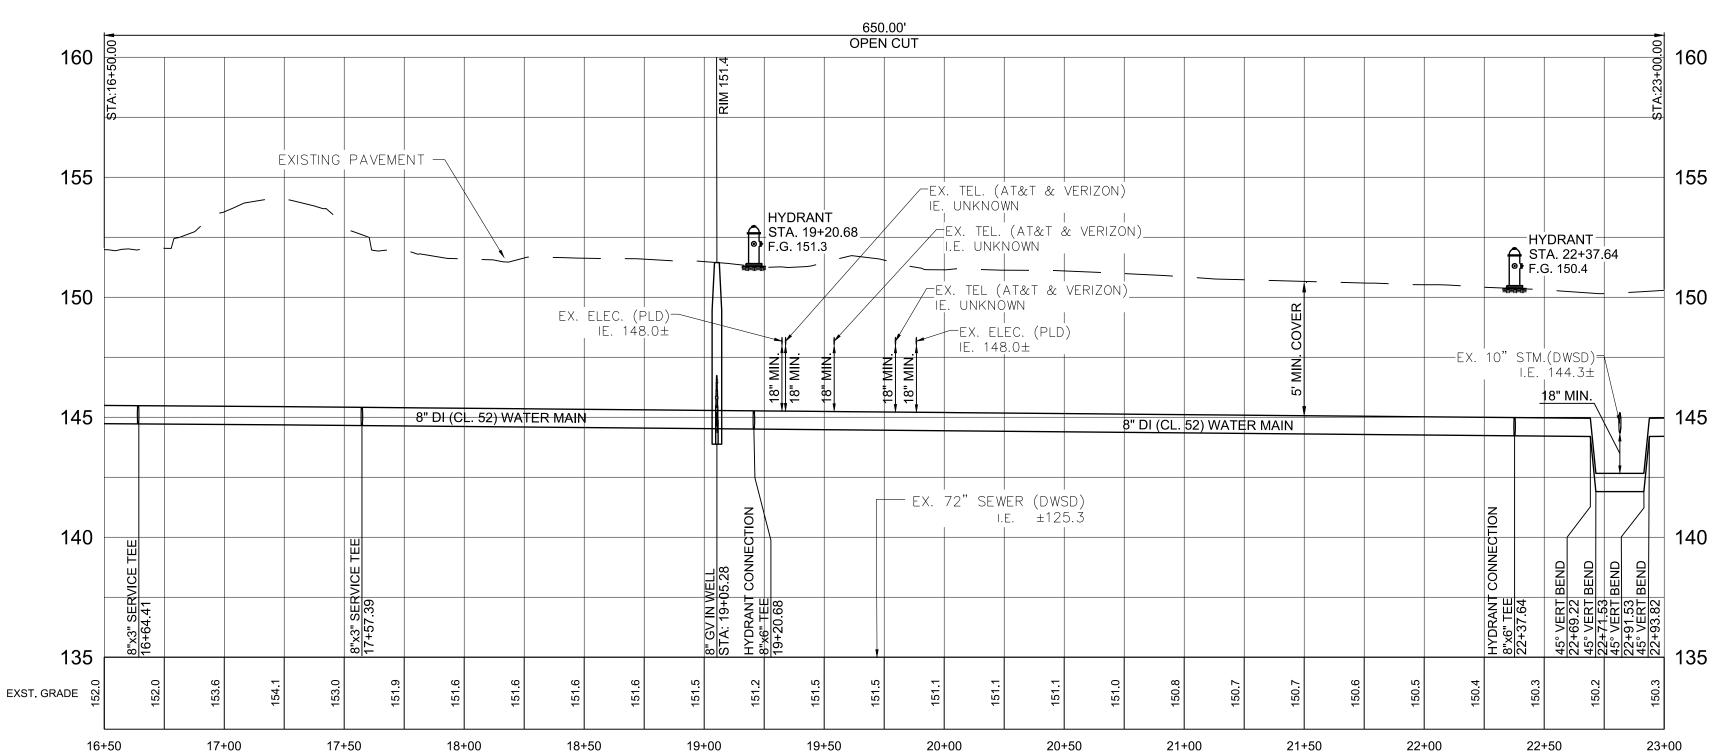

PROFILE VIEW

KEYED NOTES:

(A6) ABANDON EXIST. 6-INCH WATER MAIN.

(HI) INSTALL NEW 6-INCH FIRE HYDRANT.

 $ig(\mathsf{HR}ig)$ REMOVE EXISTING 6-INCH HYDRANT.

INSTALL 8-INCH DWSD GATE VALVE
& CONSTRUCT/FURNISH & INSTALL WELL
AS DIRECTED BY THE ENGINEER.

(IW8) INSTALL 8-INCH WATER MAIN.

REMOVE EXISTING 6-INCH GATE VALVE & WELL AS DIRECTED BY THE ENGINEER.

S3 RECONNECT EXIST. 3-INCH SERVICE.

V8F) INSTALL 8" - 45° VERTICAL BEND.

	SEWER STRUCTURE DETAILS													
POINT#	COMPASS	SIZE	MATERIAL	RIM	I.E.	SURVEYOR'S NOTES								
1289	Е	12"	CONC	150.76	146.21									
1290			NO ACCESS			CAN'T OPEN. BOLT HOLES FILLED WITH ASPHALT.								
1291			NO ACCESS			FULL OF DEBRIS.								
1296	WSW	12"	CLAY	150.77	145.57									
1308	N	10"	CLAY	149.55	144.73									
1309	S	10"	CONC	149.47	144.27									

	APPROXIMATE NUMBER OF SERVICE CONNECTIONS TO BE RECONNECTED / REPLACED											
	1" OR LARGER SERVICES TO BE		MAIN TO CURB BOX TO BE ARGER COPPER SERVICE	LEAD SERVICES TO BE REPLACED FROM CURB BOX TO METER	GROUNDING CONNECTIONS							
	RECONNECTED	COPPER	LEAD	WITH 1" OR LARGER COPPER SERVICE	CONNECTIONS							
NORTH	-	-	-	-								
SOUTH	-	-	2-1", 2-5/8"	1"-40'	0							

NOTES:

SECTION MAP

- THE LOCATION OF SEWER LEADS FROM CATCH BASINS ARE NOT KNOWN. NEW WATER MAIN SHALL BE INSTALLED MEETING THE CLEARANCES INDICATED IN NOTES #24 & 28 ON SHEET G-5.
- 2. USE PIPE DEFLECTIONS AND/ OR BENDS TO MAINTAIN CLEARANCES INDICATED IN NOTES #24 & 28 ON SHEET G-5, WHERE NECESSARY.
- 3. USE VERTICAL BENDS TO GO UNDER EXISTING UTILITIES, AS NEEDED.

SECTION

PORTION CODE

4. CONTRACTORS ARE ALLOWED TO OPERATE 16" AND SMALLER GATE VALVES. CONTRACTORS SHALL SUBMIT A SHUTDOWN REQUEST SKETCH FOR PLAN OF WATER MAIN SHUTDOWNS FOR THE AREA OF WORK.

RANGE





WM-12


F				DESIGNED BY:	DETROIT WATER AND SEWERAGE DEPARTMENT
E				TV	CAPITAL IMPROVEMENT PROGRAM
D				DRAWN BY:	CAPITAL IMPROVEMENT PROGRAM
С				DS/MK	
В				CHECKED BY:	DELAWARE STREET WTR. MAIN REPLACEMENT
A ISSUED FOR PROCUREMENT			5/4/20	MANAGER:	STA. 16+50 TO STA. 23+00
DESCRIPTIONS / REVISIONS	CHK'D	APPR.	DATE	RG	31A. 10+30 10 31A. 23+00



MDEQ SRF Project No.	
	7483-01
REF. No.	00.1010
	CS-1812
DWSD CONTRACT No.	
	WS-718
FILE No.	
	-
DRAWING No	

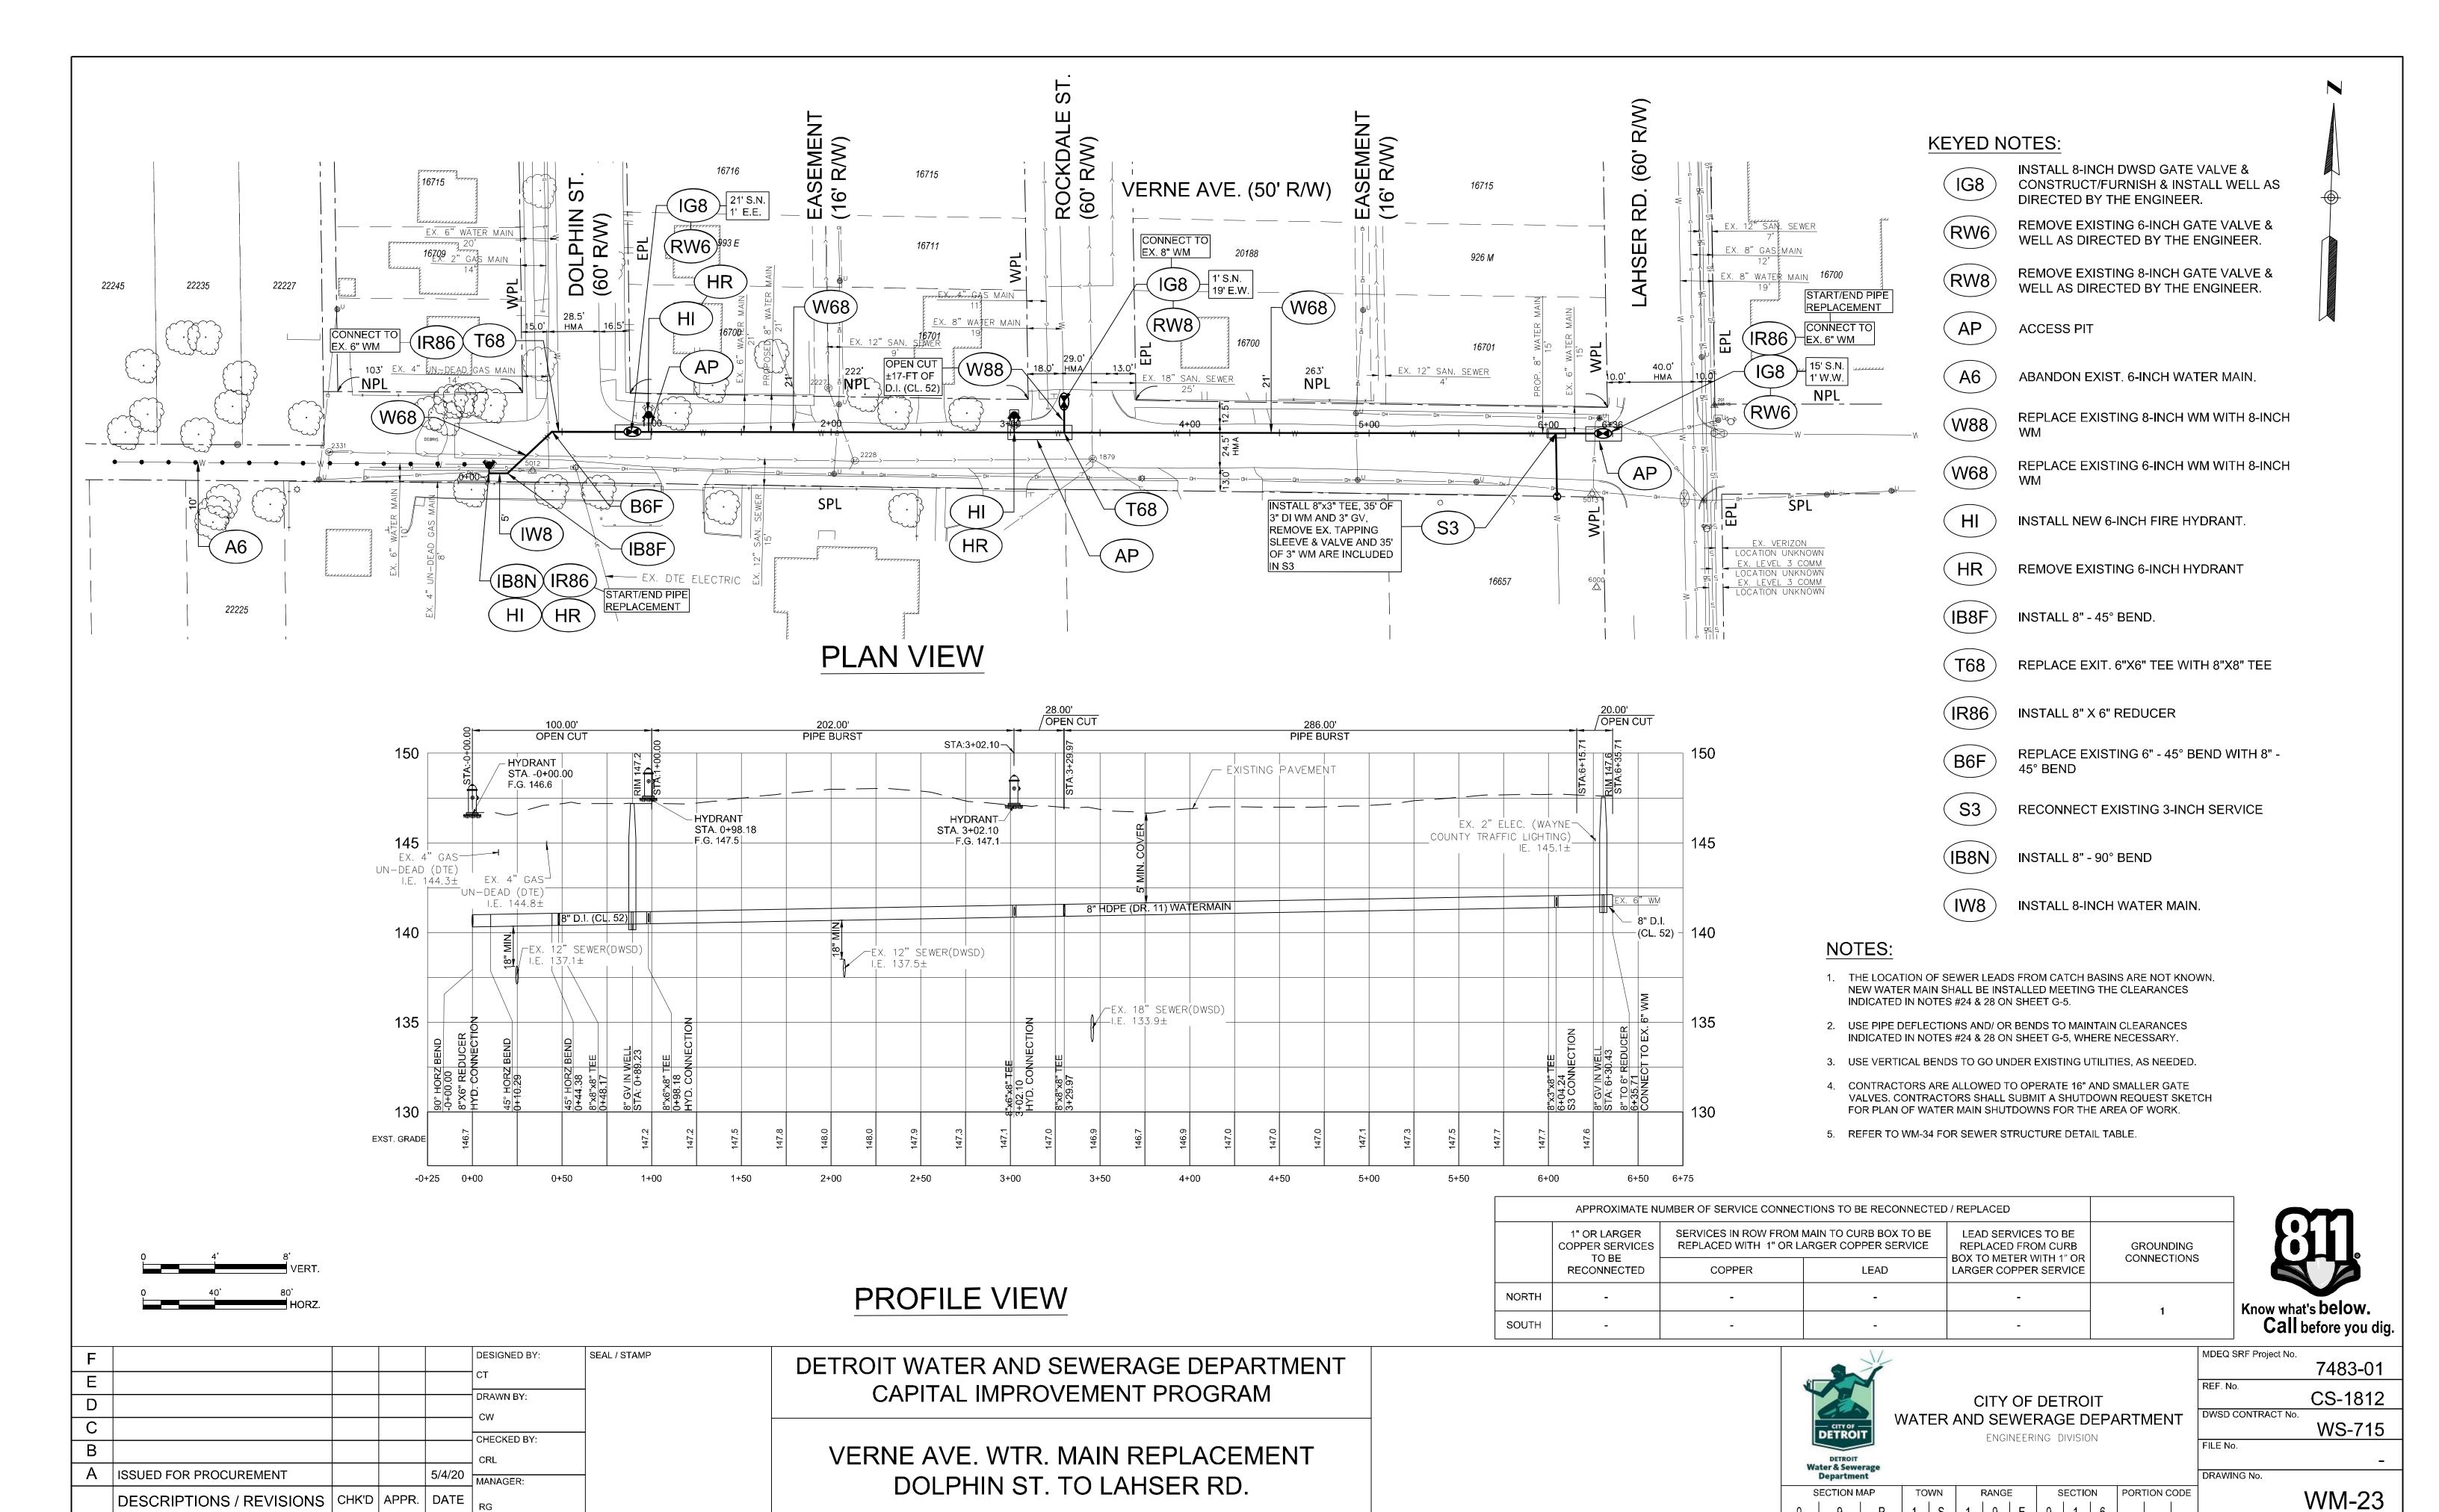

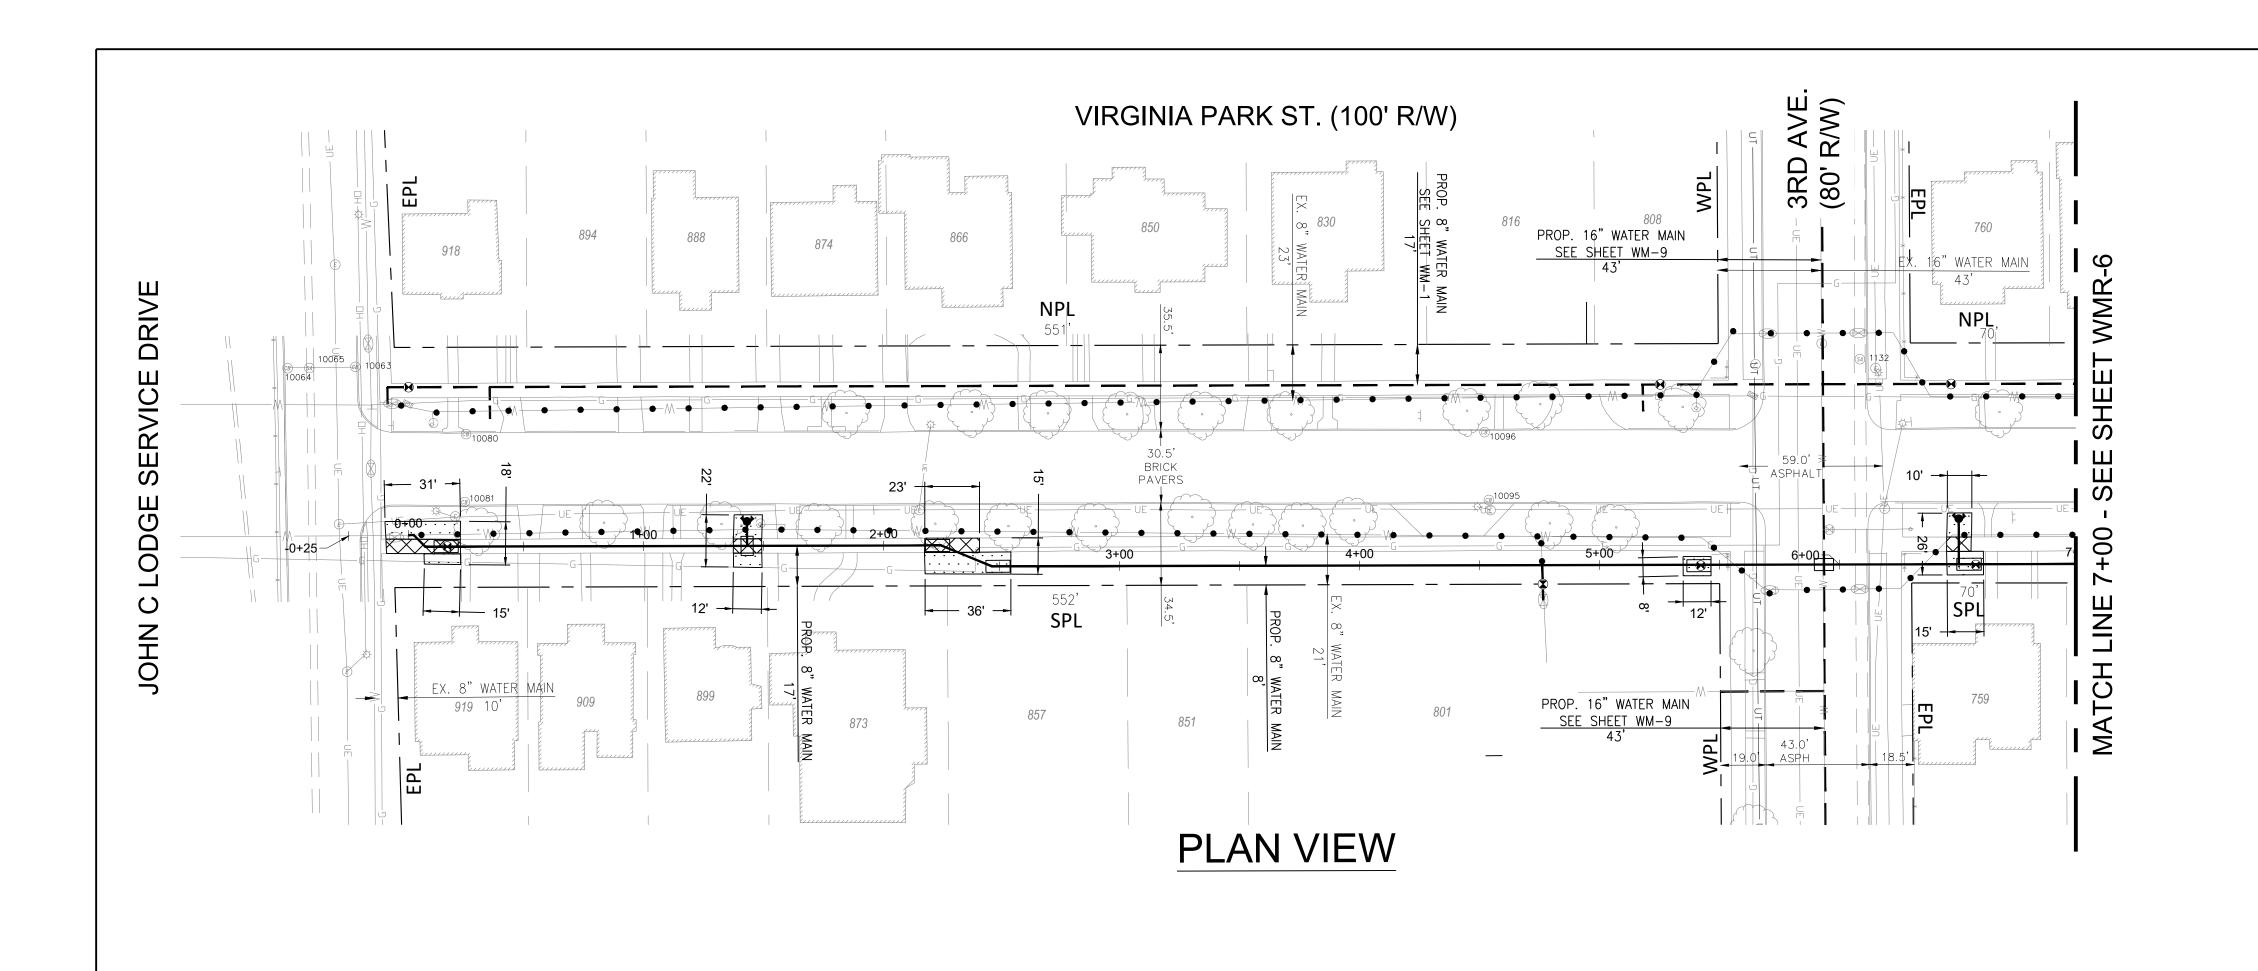

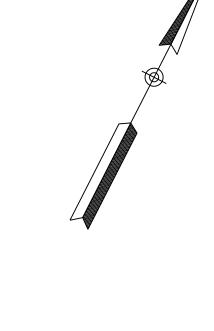

RESTORATION LEGEND

REMOVE AND REPLACE BITUMINOUS PAVEMENT

REMOVE AND REPLACE BRICK PAVEMENT

MULCHED SEEDING

REMOVE AND REPLACE DRIVEWAY, CONCRETE, 6-INCH

REMOVE AND REPLACE SIDEWALK

REMOVE AND REPLACE ADA RAMP(S)
(ARROW INDICATES RAMP DIRECTION)

REMOVE AND REPLACE TREE

TTTTTT REMOVE AND REPLACE CURB AND GUTTER

A) ADJUST CASTING TO GRADE



F					DESIGNED BY:	SEAL / STAMP	DETROIT WATER AND SEWERAGE DEPARTMENT
E					JK		CAPITAL IMPROVEMENT PROGRAM
D					DRAWN BY:		CAPITAL IIVIPROVEIVIENT PROGRAM
С					JM		
В					- CHECKED BY:		VIRGINIA PARK ST. S RESTORATION PLAN
Α	ISSUED FOR PROCUREMENT			5/4/20	MANAGER:		
	DESCRIPTIONS / REVISIONS	CHK'D	APPR.	DATE	RG		JOHN C LODGE SERVICE DR. TO STA. 7+00



CITY OF DETROIT
WATER AND SEWERAGE DEPARTMENT
ENGINEERING DIVISION

SECTION PORTION CODE

1 | E | 0 | 3 | 6 | - | - |

MDEQ SRF Project No.

7483-01

REF. No.

CS-1812


DWSD CONTRACT No.

WS-718

FILE No.

DRAWING No.

WMR-5

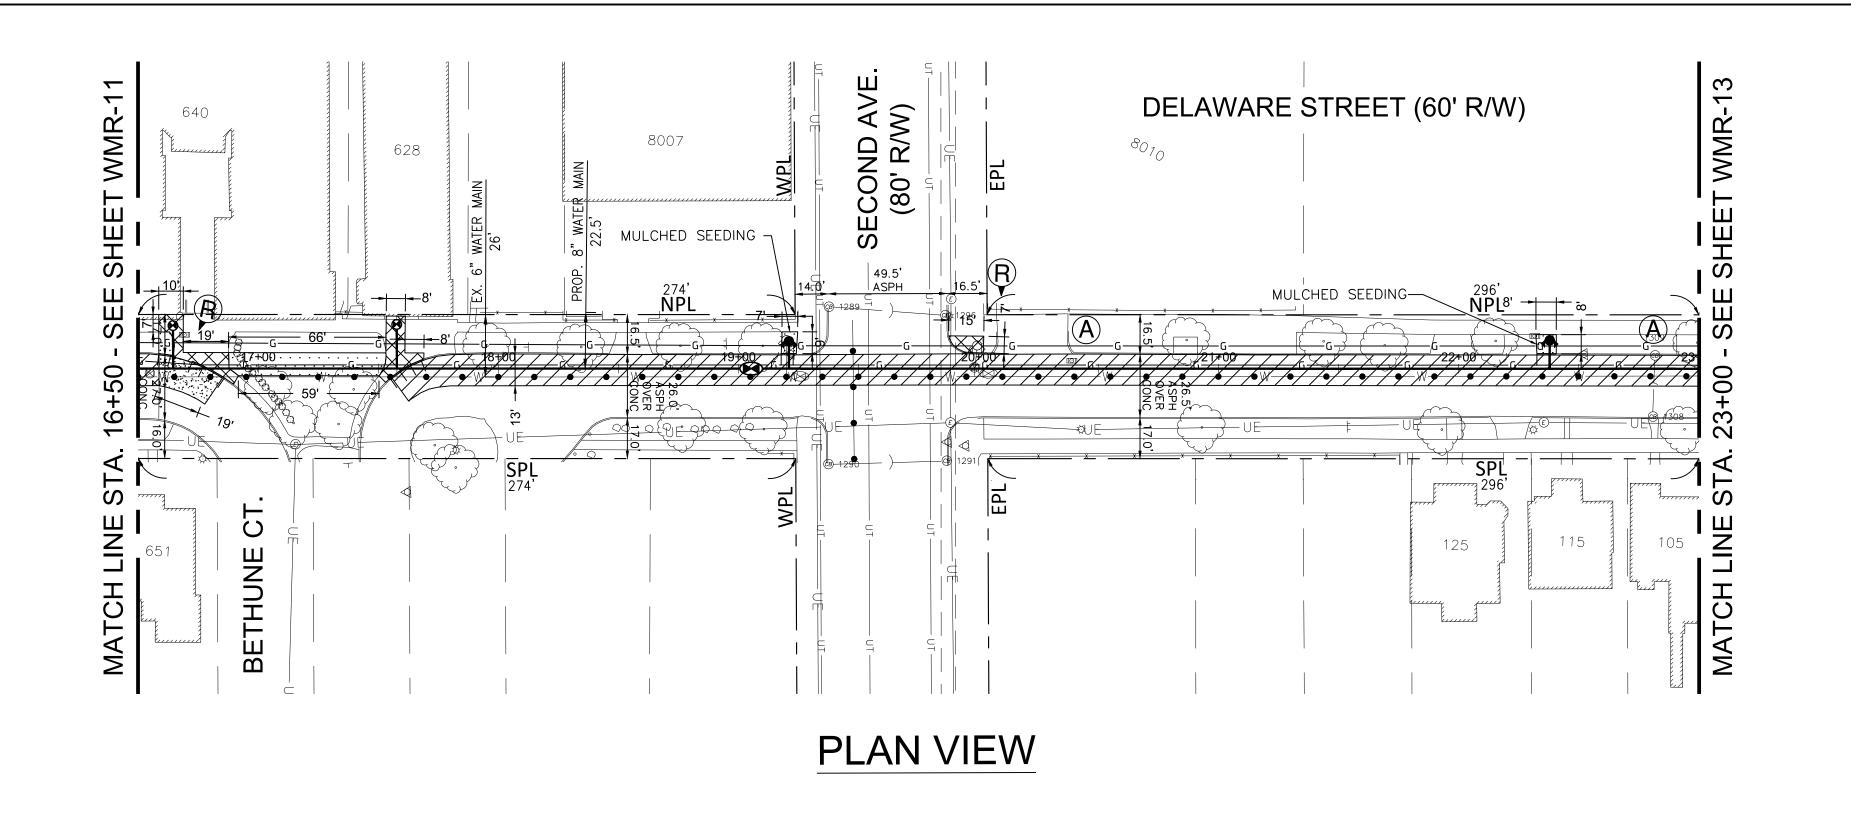

RESTORATION LEGEND

REMOVE AND REPLACE BITUMINOUS OVER CONCRETE PAVEMENT

REMOVE AND REPLACE CONCRETE PAVEMENT

MULCHED SEEDING

REMOVE AND REPLACE DRIVEWAY, CONCRETE, 6-INCH

REMOVE AND REPLACE SIDEWALK

REMOVE AND REPLACE ADA RAMP(S)
(ARROW INDICATES RAMP DIRECTION)


REMOVE AND REPLACE TREE

TTTTTT REMOVE AND REPLACE CURB AND GUTTER

ADJUST CASTING TO GRADE



F	DESIGNED BY:	SEAL / STAMP	DETROIT WATER AND SEWERAGE DEPARTMENT					MDEQ SRF Project No.	7483-01
E	AS		CAPITAL IMPROVEMENT PROGRAM					REF. No.	
D	DRAWN BY:		CAPITAL IIVIPROVEIVIENT PROGRAM		CITY OF			DWSD CONTRACT No.	CS-1812
С	CHECKED BY:			DETROIT	/ATER AND SEWE	RAGE DEPA NG DIVISION	'AR IMEN I		WS-718
В	TV		DELAWARE STREET RESTORATION PLAN	DETROIT	LIVOIIVELIX	TVO DIVISION		FILE No.	_
A ISSUED FOR PROCUREMENT	5/4/20 MANAGER:	_	STA. 16+50 TO STA. 23+00	Water & Sewerage Department				DRAWING No.	
DESCRIPTIONS / REVISIONS			31A. 10+30 10 31A. 23+00	SECTION MAP	TOWN RANGE	SECTION I I	PORTION CODE	lacksquare	VMR-12
				2 0 M			- - -		· · · · · ·

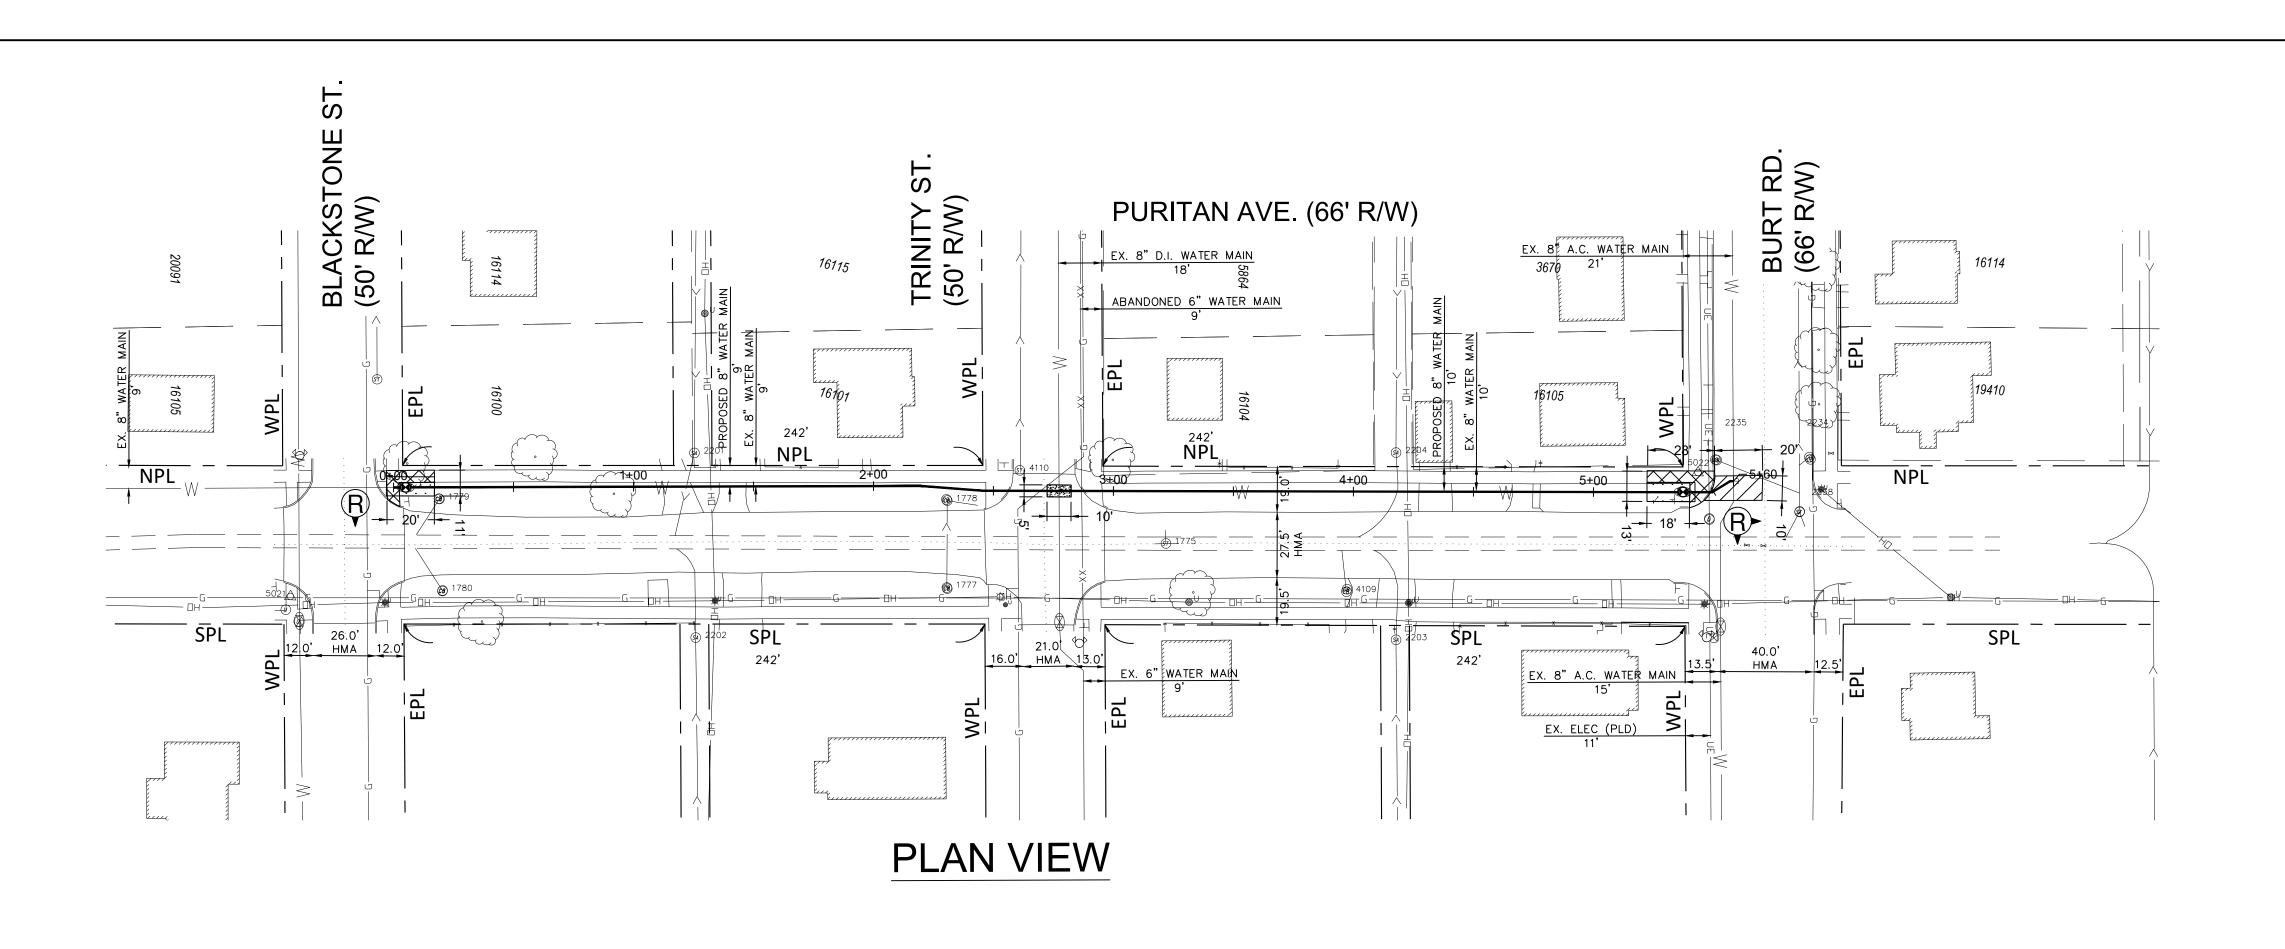

RESTORATION LEGEND

REMOVE AND REPLACE BITUMINOUS PAVEMENT

REMOVE AND REPLACE CONCRETE PAVEMENT

MULCHED SEEDING

REMOVE AND REPLACE DRIVEWAY, CONCRETE, 6-INCH

REMOVE AND REPLACE SIDEWALK

REMOVE AND REPLACE ADA RAMP(S)
(ARROW INDICATES RAMP DIRECTION)


REMOVE AND REPLACE TREE


TTTTT REMOVE AND REPLACE CURB AND GUTTER


A ADJUST CASTING TO GRADE




F	DESIGNED BY: JK	DETROIT WATER AND SEWERAGE DEPARTMENT		MDEQ SRF Project No. 7483-01 REF. No.
D C	DRAWN BY: JM	CAPITAL IMPROVEMENT PROGRAM	CITY OF DETROIT WATER AND SEWERAGE DEPARTMENT	CS-1812
В	ISSUED FOR PROCUREMENT CHECKED BY: CRL MANAGER:	PURITAN AVE. RESTORATION PLAN	DETROIT DETROIT Water & Sewerage Department	FILE No. — DRAWING No.
	DESCRIPTIONS / REVISIONS CHK'D APPR. DATE RG	BLACKSTONE ST. TO BURT RD.	SECTION MAP TOWN RANGE SECTION PORTION CODE 1 0 P 1 S 1 0 E 0 1 5 - - - - -	WMR-26

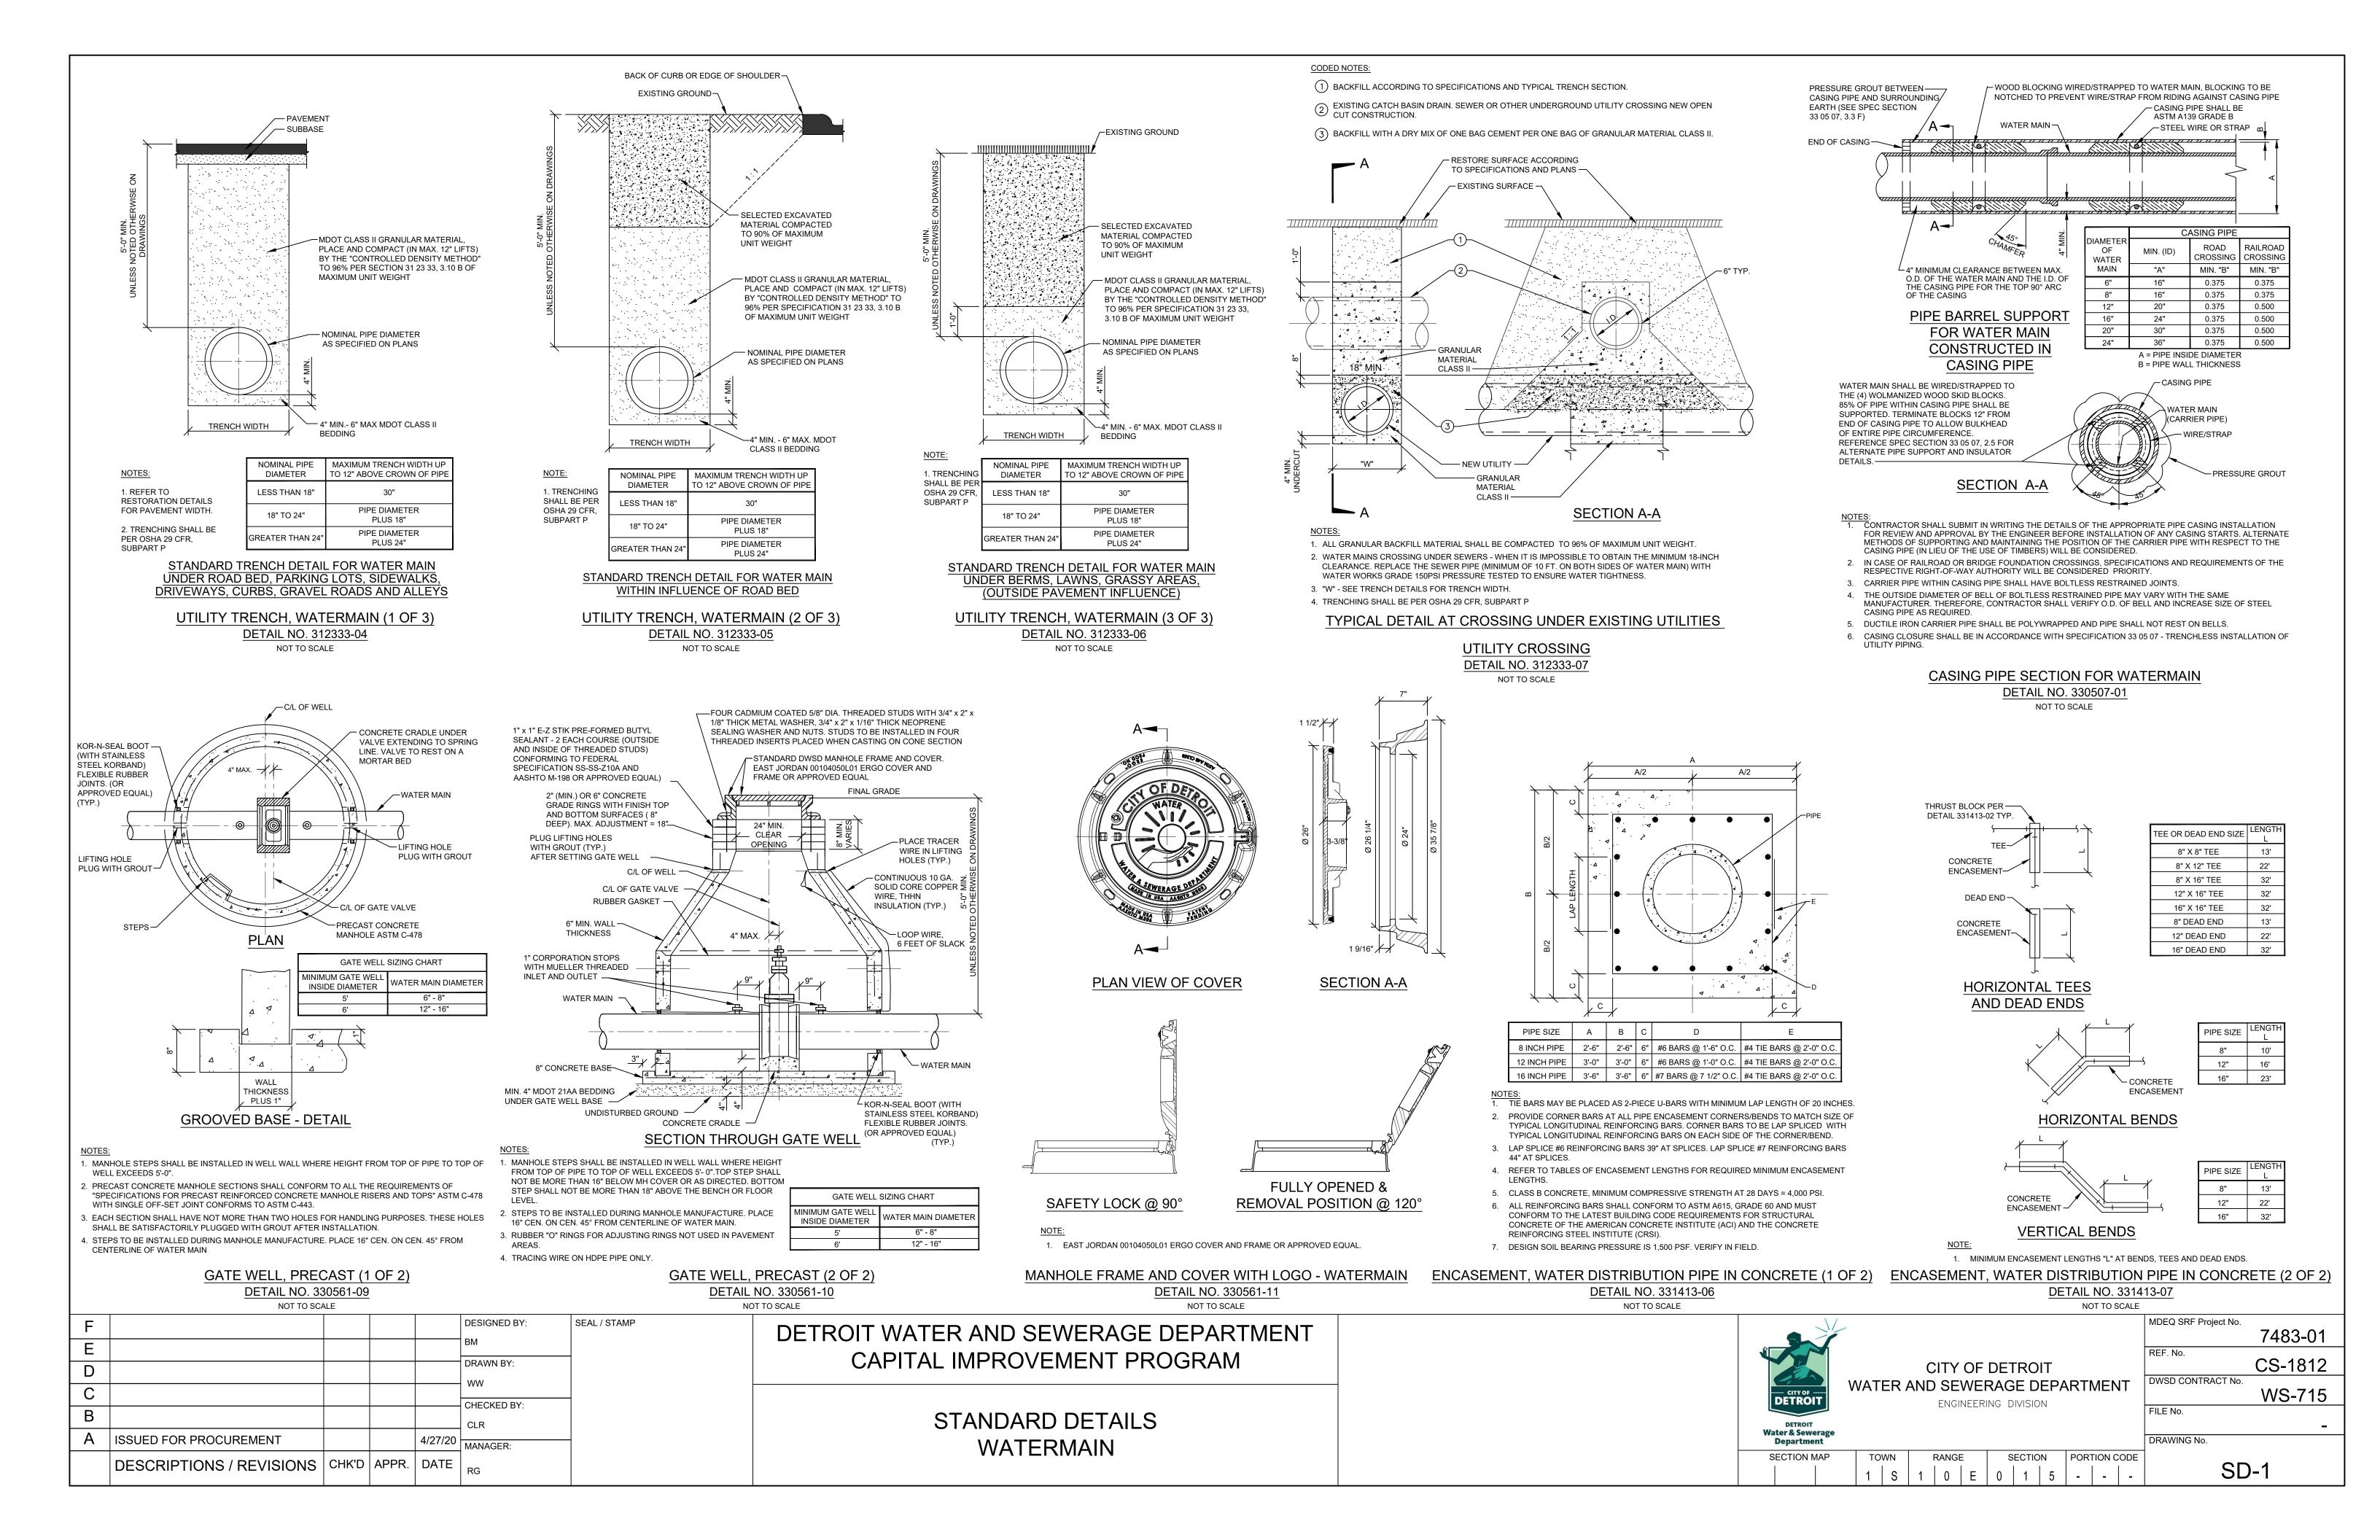

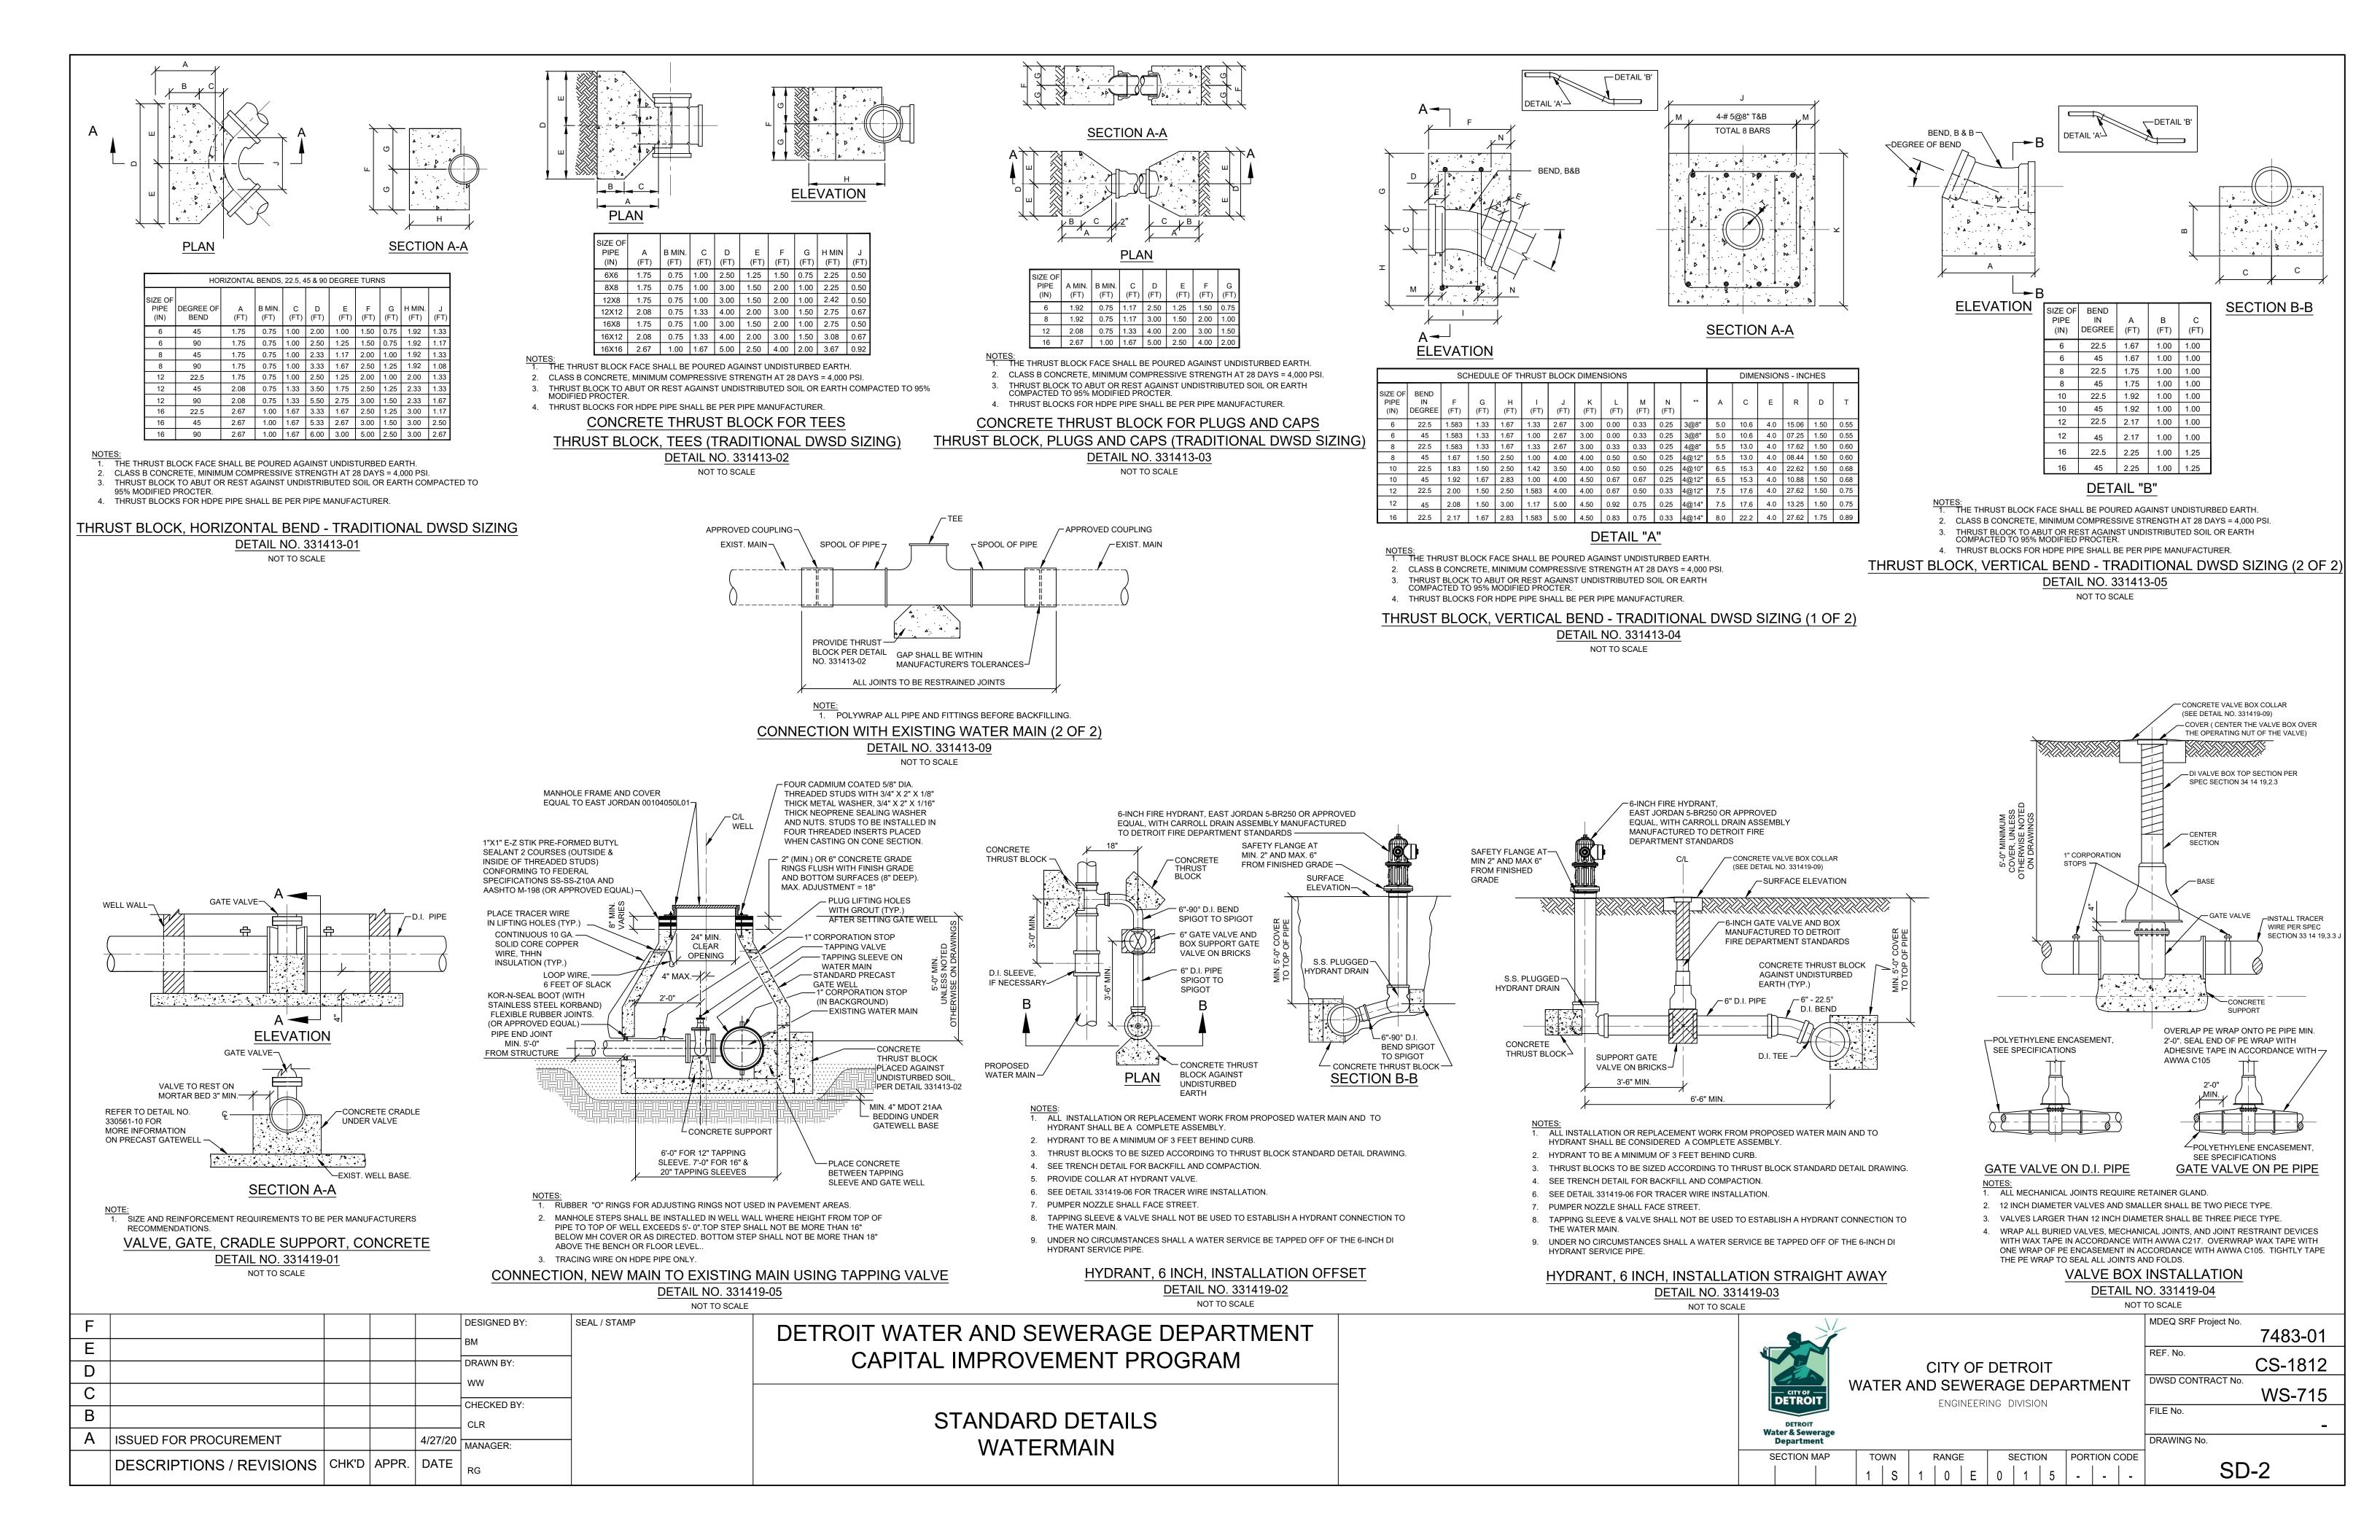

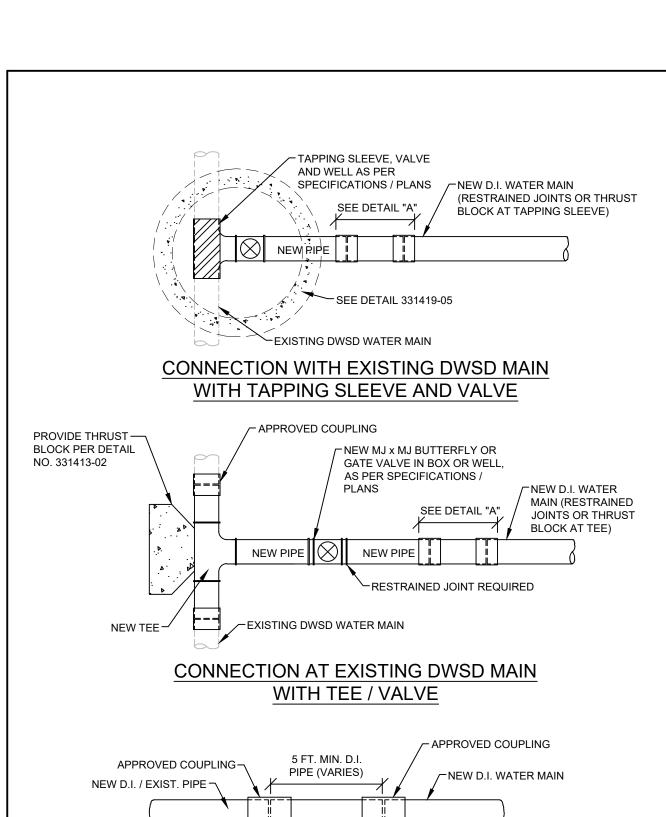

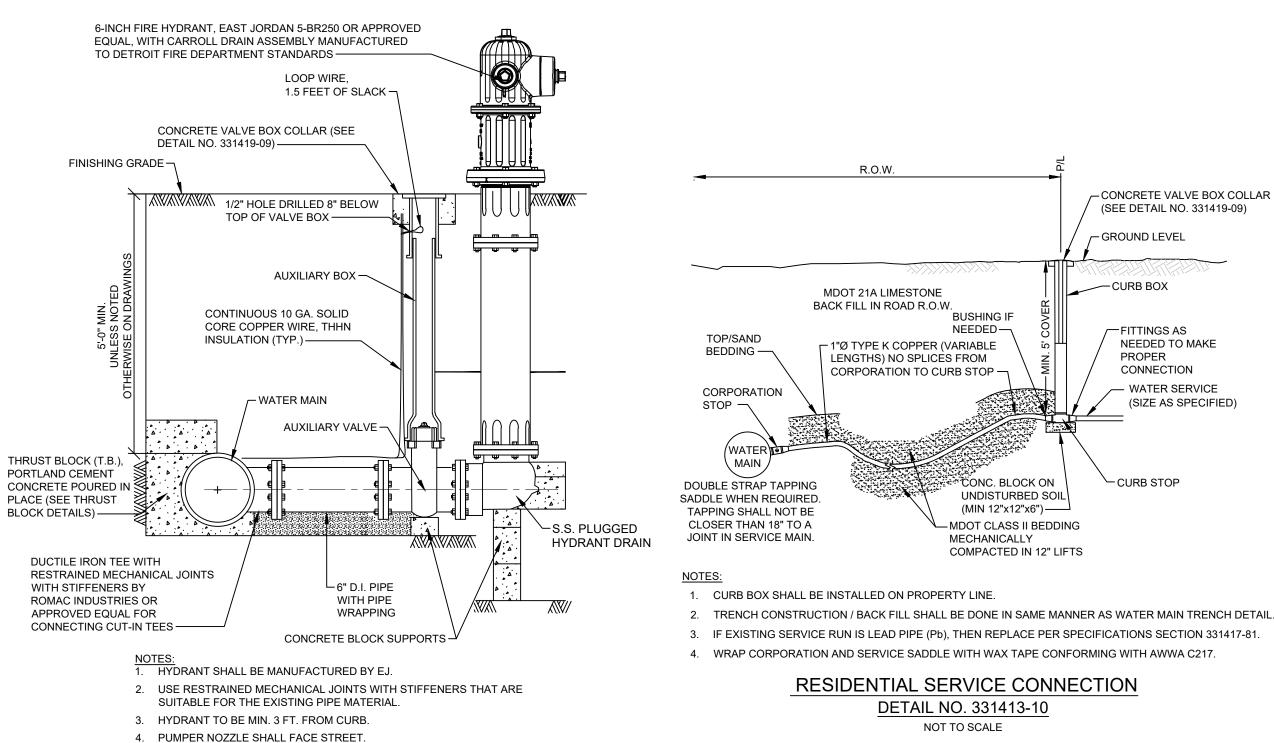

CURB BOX MDOT 21A LIMESTONE BACK FILL IN ROAD R.O.W. **BUSHING IF** FITTINGS AS TOP/SAND - 1"Ø TYPE K COPPER (VARIABLE NEEDED TO MAKE BEDDING — LENGTHS) NO SPLICES FROM CONNECTION CORPORATION TO CURB STOP -WATER SERVICE CORPORATION (SIZE AS SPECIFIED) \ MAIN . CONC. BLOCK ON DOUBLE STRAP TAPPING UNDISTURBED SOIL SADDLE WHEN REQUIRED. (MIN 12"x12"x6")-----TAPPING SHALL NOT BE CLOSER THAN 18" TO A -MDOT CLASS II BEDDING JOINT IN SERVICE MAIN. MECHANICALLY COMPACTED IN 12" LIFTS

RESIDENTIAL SERVICE CONNECTION

DETAIL NO. 331413-10

NOT TO SCALE

PIPE MATERIAL PIPE MATERIAL PER PLAN -RESTRAINED MECHANICAL JOINT WITH STIFFENER

USE RESTRAINED MECHANICAL JOINTS WITH STIFFENERS THAT ARE SUITABLE FOR THE PIPE MATERIAL. STIFFENERS SHALL BE BY ROMAC INDUSTRIES OR

- CONCRETE VALVE BOX COLLAR

(SEE DETAIL NO. 331419-09)

LOOP WIRE.

1.5 FEET OF SLACK

APPROVED EQUAL POLYWRAP VALVE PER DETAIL 331419-04.

1/2" HOLE DRILLED

8" BELOW TOP OF

CONTINUOUS 10 GA. SOLID

CORE COPPER WIRE, THHN

1" CORPORATION

INSULATION (TYP.)——


VALVE BOX —

- CONCRETE VALVE BOX COLLAR

(SEE DETAIL NO. 331419-09)

3. 12 INCH DIAMETER VALVES AND SMALLER SHALL BE TWO PIECE TYPE. 4. VALVES LARGER THAN 12 INCH DIAMETER SHALL BE THREE PIECE TYPE.

> VALVE BOX (HDPE PIPE) NOT TO SCALE

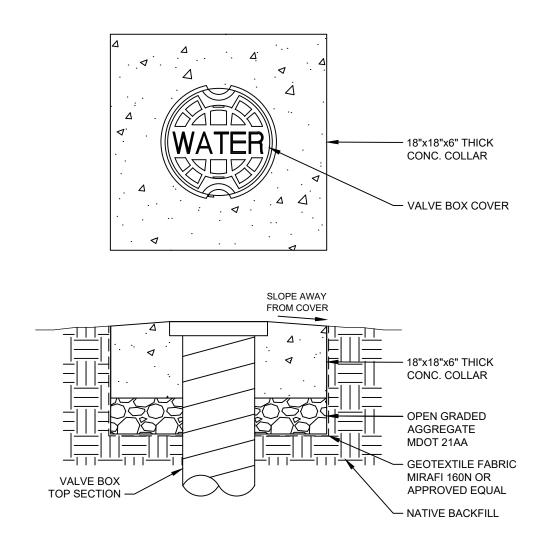

1. CLASS B CONCRETE, MINIMUM COMPRESSIVE STRENGTH AT 28 DAYS =

CONCRETE VALVE BOX COLLAR DETAIL NO. 331419-09 NOT TO SCALE

GAP SHALL BE WITHIN POLYWRAP ALL PIPE AND FITTINGS MANUFACTURER'S TOLERANCES BEFORE BACKFILLING. CONNECTION WITH EXISTING WATERMAIN DETAIL NO. 331413-08

NOT TO SCALE

-RESTRAINED MECHANICAL

JOINT WITH STIFFENER BY

RESTRAINED MECHANICAL

ROMAC INDUSTRIES OR

APPROVED EQUAL

NEW D.I. / EXIST. PIPE -

REINFORCED CONCRETE

BY CONTRACTOR WITH

BLOCKS BY HDPE

SHOP DRAWINGS-

ANCHOR BLOCK TO BE SIZED

DIRECTION FROM HDPE PIPE

HDPE WALL ANCHOR-

EXISTING PIPE MATERIAL OR NEW D.I. PIPE.

MANUFACTURER(ANCHOR

MANUFACTURER- SUBMIT

FIRE HYDRANT INSTALLATION (HDPE PIPE) **DETAIL NO. 331419-06**

REINFORCED CONCRETE ANCHOR BLOCK TO BE SIZED

DIRECTION FROM HDPE PIPE

HDPE

EXISTING PIPE MATERIAL OR NEW D.I. PIPE.

HDPE WALL ANCHOR -

MANUFACTURER(ANCHOR

MANUFACTURER- SUBMIT

BY CONTRACTOR WITH

BLOCKS BY HDPE

SHOP DRAWINGS -

NOT TO SCALE

GROUT HOLE IN MANHOLE WALL AFTER INSTALLATION. INSTALL OPPOSITE OF MANHOLE STEPS LOOP WIRE, 6 FEET OF SLACK -- CONTINUOUS 10 GA. SOLID CORE COPPER WIRE. THHN VALVE STEM INSULATION (TYP.) OFFSET 4 INCHES 1" CORPORATION STOPS-KOR-N-SEAL BOOT (WITH RESTRAINED MECHANICAL STAINLESS STEEL KORBAND) JOINT WITH STIFFENER BY FLEXIBLE RUBBER JOINTS ROMAC INDUSTRIES OR (OR APPROVED EQUAL) (TYP.) APPROVED EQUAL -NEW D.I. / EXIST. PIPE RESTRAINED MECHANICAL JOINT WITH STIFFENER BY ROMAC INDUSTRIES OR

NOTES: 1. USE RESTRAINED MECHANICAL JOINTS WITH STIFFENERS THAT ARE SUITABLE FOR THE

2. USE PIPE WRAPPING, PIPE COUPLINGS/ SLEEVES AS NECESSARY TO FACILITATE INSTALLATION AS REQUIRED.

HDPE

HDPE TO EXISTING / NEW D.I. PIPE TRANSITION (NO REDUCER) DETAIL NO. 331413-11

NOT TO SCALE

1. USE RESTRAINED MECHANICAL JOINTS WITH STIFFENERS THAT ARE SUITABLE FOR THE EXISTING PIPE MATERIAL


APPROVED EQUAL

HDPE PIPE MANUFACTURER. 3. MANHOLE STEPS SHALL BE INSTALLED IN WELL WALL WHERE HEIGHT FROM TOP OF PIPE TO TOP OF WELL EXCEEDS 5'- 0".TOP STEP SHALL NOT BE MORE THAN 16" BELOW MH COVER OR AS

2. REINFORCED CONCRETE ANCHOR BLOCK TO BE SIZED BY CONTRACTOR WITH DIRECTION FROM

DIRECTED. BOTTOM STEP SHALL NOT BE MORE THAN 18" ABOVE THE BENCH OR FLOOR LEVEL. VALVE WELL (HDPE PIPE OPEN CUT) **DETAIL NO. 331419-08** NOT TO SCALE

C/L WELL —

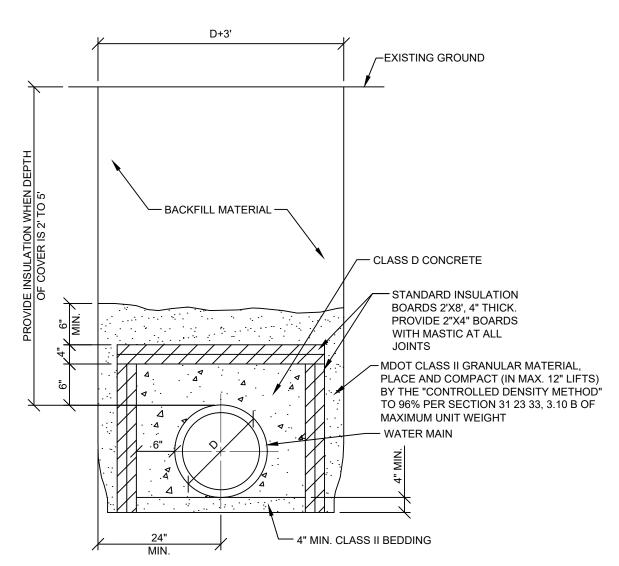

INSULATION BOARD TO BE CLOSED CELL, EXTRUDED POLYSTYRENE FOAM MEETING ASTM 578, TYP VI, 40 PSI COMPERESSING STRENGTH (ASTM D1621) 0.1% MAX. WATER ABSORPTION (ASTM C272).

2. OVERLAP ALL INSULATION BOARD JOINTS. 6" WIDE AND 2" THICK.

CLASS B CONCRETE, MINIMUM COMPRESSIVE STRENGTH AT 28 DAYS = 4,000

4. TRENCHING SHALL BE PER OSHA 29 CRF, SUBPART P.

5. ENCASEMENT IS REQUIRED FOR PIPING WITH LESS THAN 5 FT. OF COVER (LENGTH WILL VARY).

WATER MAIN TRENCH INSULATION DETAIL **DETAIL NO. 330700-01** NOT TO SCALE

F					DESIGNED BY:	SEAL / STAMP
E						
D					DRAWN BY:	
С					CHECKED BY:	
В					CHECKED BY.	
Α	ISSUED FOR PROCUREMENT			4/27/20	MANAGER:	
	DESCRIPTIONS / REVISIONS	CHK'D	APPR.	DATE		

1. USE RESTRAINED MECHANICAL JOINTS WITH STIFFENERS THAT ARE SUITABLE FOR THE

2. USE PIPE WRAPPING, PIPE COUPLINGS/ SLEEVES AS NECESSARY TO FACILITATE INSTALLATION

HDPE TO EXISTING / NEW D.I. PIPE TRANSITION (REDUCER)

DETAIL NO. 331413-12


NOT TO SCALE

CAPITAL IMPROVEMENT PROGRAM

STANDARD DETAILS WATERMAIN




DETROIT WATER AND SEWERAGE DEPARTMENT

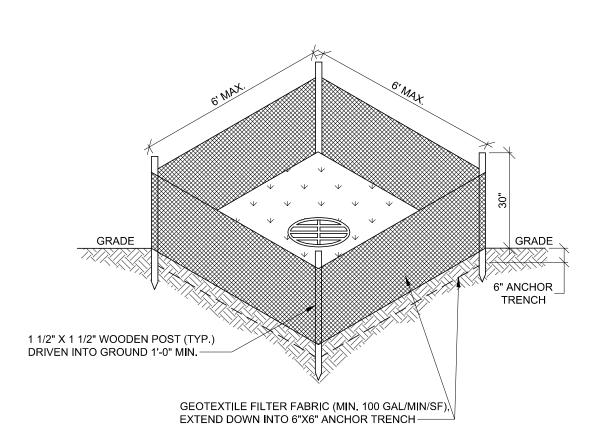

GENERAL NOTES:

- 1. REFER TO SILT FENCE DETAIL 015713-02 FOR INSTALLATION PROCEDURES.
- 2. WEEKLY INSPECTION AND MAINTENANCE MUST BE PROVIDED TO INSURE THAT THE DRAIN GUARD OPERATES EFFICIENTLY.
- 3. SOD INTERIOR OF DRAIN GUARD UNLESS INDICATED OTHERWISE.
- 4. REMOVE AND DISPOSE OF ACCUMULATED SEDIMENT AS NECESSARY, PER SPECIFICATION SECTION 015713.

DRAIN GUARD **DETAIL NO. 015713-01** NOT TO SCALE

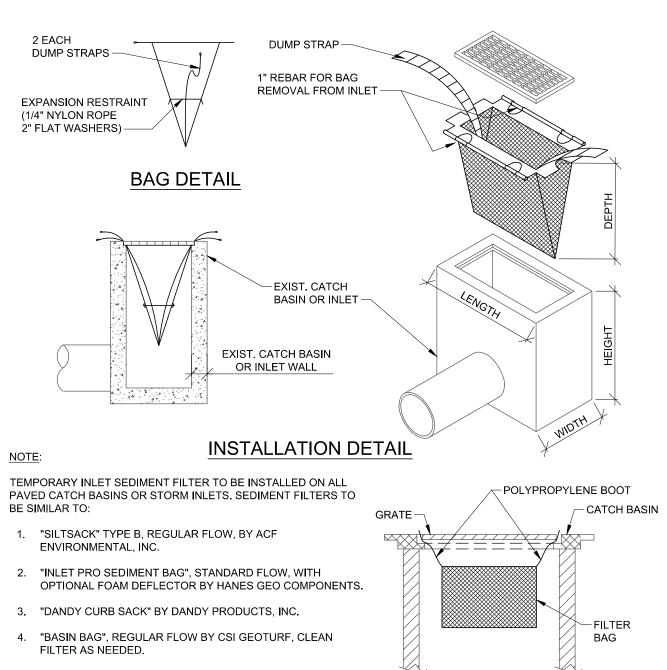


GENERAL NOTES


- 1. CONTRACTOR SHALL OBTAIN PERMISSION OF THE ENFORCING ROAD AGENCY BEFORE THIS TYPE OF CONTROL IS CONSTRUCTED IN THE ROAD RIGHT-OF-WAY.
- 2. CONTRACTOR SHALL KEEP CURBS & GUTTER INLET FILTERS (AFTER PAVING) IN PLACE UNTIL ALL AREAS CONTRIBUTING TO THEM ARE STABILIZED WITH VEGETATION.
- 3. CONTRACTOR SHALL PERFORM WEEKLY INSPECTION AND MAINTENANCE TO ENSURE THAT THE CURB &


INLET PROTECTION FABRIC DROP

NOT TO SCALE

GUTTER INLET FILTER (AFTER PAVING) OPERATES EFFICIENTLY. **DETAIL NO. 015713-05**

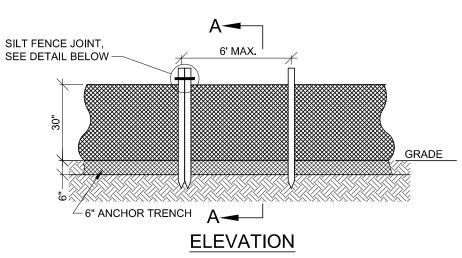


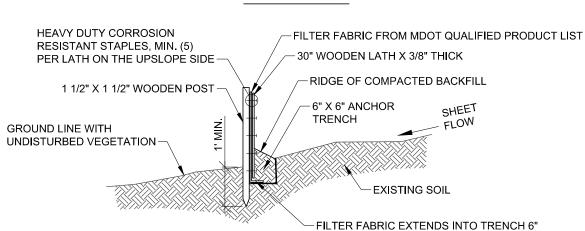

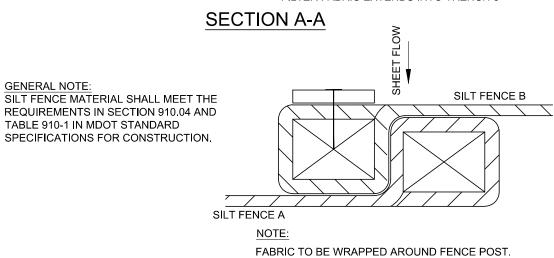

SILT FENCE JOINT - TOP VIEW


EROSION CONTROL, SILT FENCE DETAIL NO. 015713-02

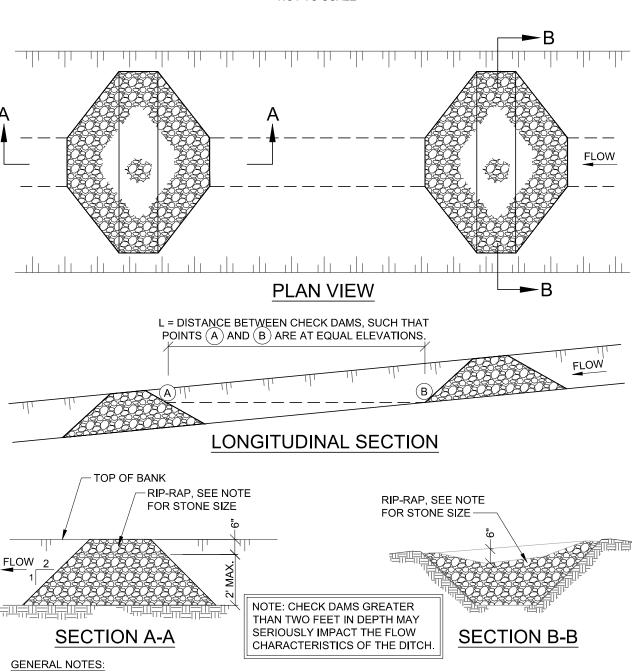

GENERAL NOTES:

- DEPENDING ON THE VELOCITY, SLOPE AND SOILS, USE THE PROPER SIZE RIP-RAP TO HANDLE THE SHEAR STRESS OF THE SLOPE/CHANNEL.
- 2. FOR SLOPE AND/OR CHANNEL PROTECTION, SEE THE MDOT CONSTRUCTION SITE SOIL EROSION PREVENTION
- 3. RIP-RAP SIZE SHOULD BE 2-4 INCHES FOR DITCH GRADES LESS THAN 2% AND 3-12 INCHES FOR DITCH GRADES GREATER THAN 2%.
- 4. BASE TO BE AT LEAST 2 X HEIGHT.

CHECK DAMS DETAIL NO. 015713-06 NOT TO SCALE

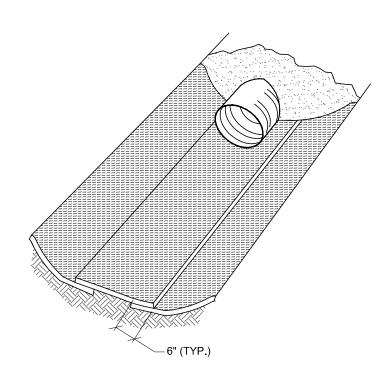



TYPICAL DITCH LINING

GENERAL NOTES: (FROM MDOT DRAINAGE MANUAL)

- 1. EROSION CONTROL BLANKETS PROTECT DENUDED SURFACES AGAINST WIND AND WATER EROSION, AND STABILIZE SOIL SURFACES WHILE VEGETATION IS BEING ESTABLISHED.
- 2. BLANKETS ARE PLACED IN DITCHES AND ON STEEP SLOPES USUALLY WITH RIP-RAP WHERE INDICATED ON THE DRAWINGS OR AS DIRECTED BY THE ENGINEER.
- 3. EXTEND BLANKETS UNDER PIPE THREE (3) INCHES. ANCHOR BLANKETS IN ACCORDANCE WITH MDOT STANDARD SPECIFICATIONS FOR CONSTRUCTION, SECTION 816 TURF ESTABLISHMENT.
- 4. PROVIDE MULCH BLANKETS/HIGH VELOCITY BLANKETS SELECTED FROM THE MDOT QUALIFIED PRODUCTS LIST.
- 5. USE MULCH BLANKETS WITH NETTING ON TOP SIDE ON SLOPES FLATTER THAN 1:2.
- 6. USE HIGH VELOCITY BLANKETS WITH NETTING ON TOP AND FIBERS IN CONTACT WITH SOIL ON SLOPES 1:2 OR
- 7. USE MULCH BLANKET AS PERMANENT STABILIZATION TREATMENT FOR DITCHES WITH SLOPES BETWEEN 0.5%
- 8. USE HIGH VELOCITY MULCH BLANKET AS PERMANENT STABILIZATION TREATMENT FOR DITCHES WITH SLOPES
- 9. USE ANCHOR TRENCH AT TOP OF SLOPE (SEE DETAIL 01014.02, SECTION A, FOR DETAILS ON TRENCH).


MULCH BLANKETS / HIGH VELOCITY BLANKETS **DETAIL NO. 015713-03** NOT TO SCALE

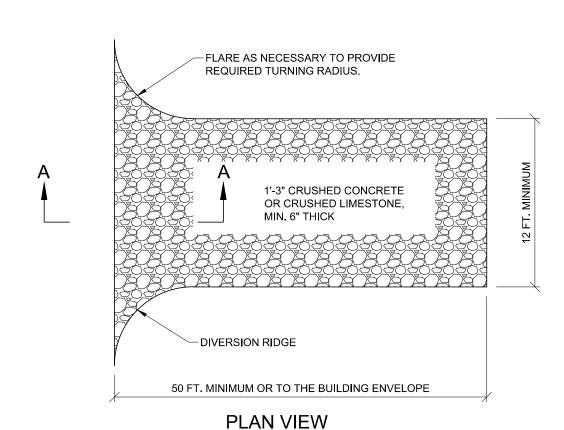


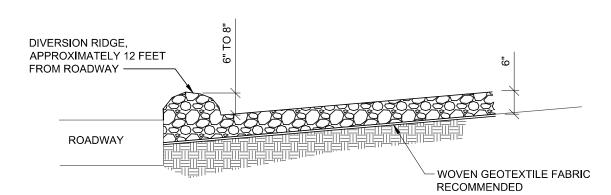

CROSS-SECTION A-A

GRAVEL ACCESS APPROACH DETAIL NO. 015713-07 NOT TO SCALE

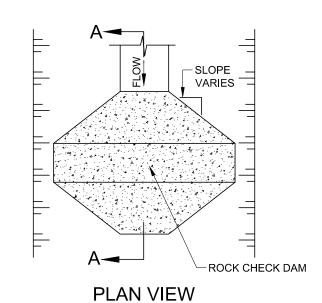


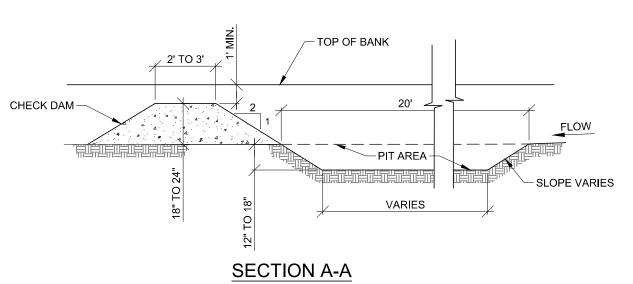

GENERAL NOTES:

- 1. THE DITCH CROSS-SECTION SHOULD ONLY BE PARTIALLY BLOCKED, IN ORDER TO MINIMIZE THE LOSS IN DITCH
- 2. CHECK DAM SHOULD BE REMOVED AND THE SEDIMENT PIT FILLED AS SOON AS THE UPSTREAM AREAS CONTRIBUTING TO IT ARE STABILIZED. THIS WILL ALLOW THE DITCH TO FUNCTION AS DESIGNED.
- 3. WEEKLY INSPECTION AND MAINTENANCE MUST BE PROVIDED TO INSURE THAT THE DITCH SEDIMENT TRAP OPERATES EFFICIENTLY.
- 4. THE PERMISSION OF THE GOVERNMENTAL AGENCY, RESPONSIBLE FOR THE MAINTENANCE OF THE DITCH, MUST BE RECEIVED BEFORE A DITCH SEDIMENT TRAP IS INSTALLED.
- 5. SEE STANDARD DETAIL 015713-06 OR DWSD FOR CHECK DAM SPECIFICATIONS FOR CONSTRUCTION.

DITCH SEDIMENT TRAP NOT TO SCALE

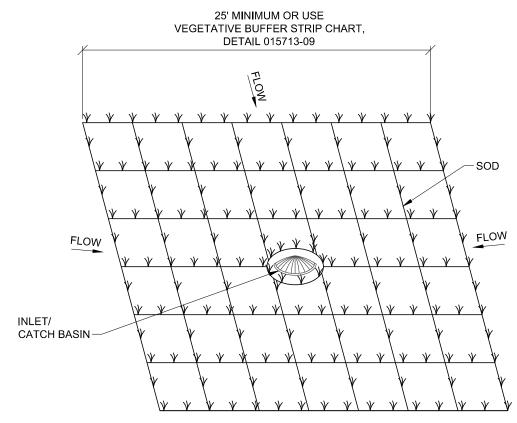

ISOMETRIC VIEW

NOTES:

- 1. SOD INLET FILTERS ARE PADS OF SOD PLACED AROUND A STORM DRAIN INLET OR CATCH BASIN.
- 2. SOD INLET FILTERS ARE INSTALLED TO SLOW THE FLOW OF WATER INTO AN INLET OR CATCH BASIN AND FILTER OUT SEDIMENT IN THE PROCESS.
- 3. SOD INLET FILTERS SHOULD ONLY BE USED TO HANDLE LIGHT CONCENTRATIONS OF SEDIMENT. THEY ARE BEST USED AFTER FINAL GRADING IS COMPLETE AND DURING THE ESTABLISHMENT OF A VEGETATIVE COVER.

SOD FILTER **DETAIL NO. 015713-08** NOT TO SCALE

F					DESIGNED BY:	SEAL / STAMP
E					ВМ	
D					DRAWN BY:	
С					WW OUTDOXED BY	
В					CHECKED BY:	
Α	ISSUED FOR 60% DESIGN			5/8/20	MANAGER:	
	DESCRIPTIONS / REVISIONS	CHK'D	APPR.	DATE	RG	

DETROIT WATER AND SEWERAGE DEPARTMENT CAPITAL IMPROVEMENT PROGRAM

STANDARD DETAILS SOIL EROSION AND SEDIMENTATION CONTROL



SECTION MAP

CITY OF DETROIT

WATER AND SEWERAGE DEPARTMENT ENGINEERING DIVISION

SECTION

MDEQ SRF Project No. CS-XXXX DWSD CONTRACT No WS-720 FILE No. DRAWING No. PORTION CODE SD-4

INDICATES APPLICABILITY OF A SPECIFIC CONTROL MEASURE TO ONE OR MORE OF THE SEVEN PROBLEM AREAS. DETAILS CHARACTERISTICS A || B || C || D || E || F || G TOPSOIL MAY BE STOCKPILED ABOVE BORROW AREAS TO ACT AS A DIVERSION STOCKPILE SHOULD BE TEMPORARILY SEEDED. AVOID EXTENSIVE AND UNNECESSARY CLEARING OF TOPSOIL. RETAINS EXISTING ROOT MAT SYSTEMS. REDUCES WINDFALL AT NEW FOREST EDGE DISCOURAGES EQUIPMENT ENTRANCE STABILIZES SOIL THUS MINIMIZING EROSION ERMITS RUNOFF TO INFILTRATE SOIL, REDUCING RUNOFF. VOLUME SHOULD INCLUDE PREPARED TOPSOIL BED. FERTILIZING MULCHING AND WATERING REQUIRED. MULCH BLANKETS PROVIDE AN IMMEDIATE AND EFFECTIVE COVER OVER RAW ERODIBLE SLOPES AFFORDING EXCELLENT PROTECTION AGAINST RAIN AND HIGH VELOCITY MULCH BLANKETS WORK WELL FOR STABILIZING THE BOTTOM OF DITCHES IN WATERWAYS EFFECTIVE ON LARGE AREAS MULCH TACKING AGENT USED TO PROVIDE IMMEDIATE PROTECTION UNTIL RASS IS ROOTED. OULD INCLUDE PREPARED TOPSOIL BED. FERTILIZING, MULCHING AND WATERING ARE REQUIRED CAN BE USED ON STEEP SLOPES WHERE SEED MAY BE DIFFICULT TO ESTABLISH MAY BE REPAIRED IF DAMAGED. SHOULD INCLUDE PREPARED TOPSOIL BED. SLOWS RUNOFF VELOCITY. FILTERS SEDIMENT FROM RUNOFF REDUCES VOLUME OF RUNOFF ON SLOPES. SSISTS IN ESTABLISHING PERMANENT VEGETATIVE COVER. PROTECTS SOIL FROM IMPACT OF FALLING RAIN. PRESERVES SOIL MOISTURE AND PROTECTS GERMINATING SEED FROM TEMPERATURE EXTREMES. SHOULD BE INSPECTED AFTER EVERY RAINSTORM AND REPAIRED AS NECESSARY UNTIL VEGETATION IS WELL ESTABLISHED. CAN BE ACCOMPLISHED BY HARROWING WITH A DISK, BACK BLADING, OR ACKING WITH A DOZER PERPENDICULAR TO THE SLOPE. REDUCES VELOCITY AND INCREASES INFILTRATION RATES. HOLDS WATER, SEED, AND MULCH BETTER THAN SMOOTH SURFACES JSED WHERE VEGETATION IS NOT EASILY ESTABLISHED. ECTIVE FOR HIGH VELOCITIES OR HIGH CONCENTRATIONS. ERMITS RUNOFF TO INFILTRATE SOIL. DISSIPATES ENERGY FLOW AT SYSTEM OUTLETS ULD BE PLACED ON A GEOTEXTILE LINER. STABILIZES SOIL SURFACE, THUS MINIMIZING FROSION PERMITS CONSTRUCTION TRAFFIC IN ADVERSE WEATHER. MAY BE USED AS PART OF PERMANENT BASE CONSTRUCTION OF PAVED AREAS CES POTENTIAL SOIL EROSION AND FUGITIVE DUST BY STABILIZING RAW AREAS. REDUCES RUNOFF VELOCITY BY REDUCING EFFECTIVE SLOPE LENGTH. DIVERTS WATER FROM VULNERABLE AREAS. COLLECTS AND DIRECTS WATER TO PREPARED DRAINAGEWAYS. MAY BE PLACED AS PART OF NORMAL CONSTRUCTION OPERATION. COLLECTS AND DIVERTS WATER TO A STABLE OUTLET OR SEDIMENT CONTROL TENTIALLY BE INCORPORATED IN PERMANENT PROJECT DRAINAGE SYSTEM DIVERTS WATER TO A PREPARED DRAINAGEWAY. MAY BE USED AT INTERVALS ACROSS SLOPE FACE TO REDUCE EFFECTIVE DUST CONTROL CAN BE ACCOMPLISHED BY WATERING, AND/OR APPLYING THE DISTURBED AREAS SHOULD BE KEPT TO A MINIMUM.

*	INDICATES APPLICABILITY TO ONE OR MORE OF THE	OF A SPECIFIC CONTROL MEASURE SEVEN PROBLEM AREAS.	SLOPES	STREAMS AND WATERWAYS	SURFACE DRAINAGEWAYS	ENCLOSED DRAINAGE (INLET & OUTFALL CONTROL)	LARGE FLAT SURFACE AREAS	BORROW AND STOCKPILE AREAS	ADJACENT PROPERTIES
KEY	DETAILS	CHARACTERISTICS	A	В	С	D	Е	F	G
17	GRAVEL FILTER BERM	FILTER FLOW PRIOR TO ENTRY INTO A LAKE, STREAM OR WETLAND. NOT TO BE USED AS A CHECK DAM.	*		*			*	*
18	BRUSH FILTER	USES SLASH AND LOGS FROM CLEARING OPERATIONS. CAN BE COVERED AND SEEDED RATHER THAN REMOVED. ELIMINATES NEED FOR BURNING OR REMOVAL OF MATERIAL FROM SITE.							*
19	BARE CHANNEL	LEAST EXPENSIVE FORM OF DRAINAGEWAY. MAY BE USED ONLY WHERE GRADIENT IS VERY LOW AND WITH SOILS OF MINIMUM EROSION POTENTIAL.			*				
20	GRASSED WATERWAY	GRASS TENDS TO SLOW RUNOFF AND FILTER OUT SEDIMENT. USED WHERE BARE CHANNEL WOULD BE ERODED.			*				
21	SLOPE DRAIN (SUBSURFACE PIPE)	PREVENTS EROSION ON SLOPES WHEN RUNOFF CANNOT BE DIVERTED TO EDGE OF SLOPE AREA. USUALLY PERMANENT. CAN BE CONSTRUCTED OR EXTENDED AS GRADING PROGRESSES.	*		*				
22	PIPE DROP	REDUCES RUNOFF VELOCITY. REMOVES SEDIMENT AND TURBIDITY. CAN BE DESIGNED TO HANDLE LARGE VOLUMES OF FLOW. ALLOWS WATER TO DROP RAPIDLY IN ELEVATION WITHOUT CAUSING EXCESSIVE EROSION.	*		*				
23	SOD FILTER	INEXPENSIVE TO CONSTRUCT. PROVIDES IMMEDIATE PROTECTION. PROTECTS AREAS AROUND INLETS FROM EROSION.				*			
24	STRAW BALE FILTER	INEXPENSIVE AND EASY TO CONSTRUCT. CAN BE LOCATED AS NECESSARY TO COLLECT SEDIMENT. MAY BE USED IN CONJUNCTION WITH SNOW FENCE FOR ADDED STABILITY.				*			*
25	CHECK DAM INLET PROTECTION	CAN BE CONSTRUCTED ACROSS DITCHED OR ANY AREA OF CONCENTRATED FLOW. PROTECTS VEGETATION IN EARLY STAGES OF GROWTH. A CHECK DAM IS INTENDED TO REDUCE WATER VELOCITIES AND CAPTURE SEDIMENT. A CHECK DAM IS NOT A FILTERING DEVICE PROVIDES SETTLING AND FILTERING OF SILT LADEN WATER PRIOR TO ITS ENTRY INTO THE DRAINAGE SYSTEM.	*		*			*	
26	FABRIC DROP	CAN BE USED IN MEDIAN AND SIDE DITCHES WHERE VEGETATION WILL BE DISTURBED. ALLOWS FOR EARLY USE OF DRAINAGE SYSTEMS PRIOR TO PROJECT COMPLETION.			*		*		
27	ROCK FILTER	CAN UTILIZE MATERIAL FOUND ON SITE. EASY TO CONSTRUCT. FILTERS SEDIMENT FROM RUNOFF.				*			*
28	INLET SEDIMENT TRAP	EASY TO SHAPE. COLLECTS SEDIMENT. MAY BE CLEANED AND EXPANDED AS NEEDED. CAN BE USED WHERE MEDIUM FLOWS ARE ANTICIPATED.				*			
29	STONE AND ROCK CROSSING	MAY BE ROCK OR CLEAN RUBBLE MINIMIZES STREAM TURBIDITY. INEXPENSIVE. MAY ALSO SERVE AS DITCH CHECK OR SEDIMENT TRAP.		*					
30	SILT FENCE	A PERMEABLE BARRIER ERECTED BELOW DISTURBED AREAS TO CAPTURE SEDIMENTS FROM SHEET FLOW. CAN BE USED TO DIVERT SMALL VOLUMES OF WATER TO STABLE OUTLETS. INEFFECTIVE AS A FILTER AND SHOULD NEVER BE PLACED ACROSS STREAMS OR DITCHES WHERE FLOW IS CONCENTRATED.	*					*	*
31	DRAIN GUARD	PERMEABLE BARRIER ERECTED AROUND AN INLET TO CAPTURE SEDIMENTS.				*			
32	WIND BREAK	MINIMIZES WIND EROSION. MAY BE SNOW FENCE.					*		
33	GRAVEL ACCESS , APPROACH	PROVIDES A STABLE ACCESS TO ROADWAYS MINIMIZING FUGITIVE DUST AND TRACKING OF MATERIALS ONTO PUBLIC STREETS AND HIGHWAYS.					*	*	

SOIL EROSION AND SEDIMENTATION CONTROL, MEASURES 1-33
DETAIL NO. 015713-13 THROUGH 015713-19

NOT TO SCALE

SOIL EROSION AND SEDIMENTATION CONTROL

TEMPORARY FACILITIES

THE CONTRACTOR SHALL CONSTRUCT THIS PROJECT IN COMPLIANCE WITH PART 91 OF ACT NO. 451 OF 1994, NATURAL RESOURCES AND ENVIRONMENTAL PROTECTION ACT, OF THE MICHIGAN COMPILED LAWS ENTITLED "SOIL EROSION AND SEDIMENTATION CONTROL" UNDER THE CONTROL OF THE LOCAL PERMIT AGENCY CHARGED WITH ADMINISTERING THE PROVISIONS OF THIS ACT. THE CONTRACTOR SHALL FOLLOW THE PROCEDURES DELINEATED BELOW AND CONSTRUCT AND MAINTAIN THE FACILITIES SHOWN ON THE DRAWINGS TO CONTROL WATER AND WIND EROSION DURING CONSTRUCTION OF THIS PROJECT.

ALL DISTURBED SURFACE AREA (INCLUDING UTILITY TRENCHES) SHALL BE TEMPORARILY GRADED AND/OR DITCHED TO DIRECT ALL WATER RUNOFF FROM SUCH AREAS TO SEDIMENTATION CONTROL DEVICES WHICH WILL PREVENT WATER CARRYING ERODED SOIL FROM ENTERING A WATERCOURSE, SEWER, OR ADJACENT LANDS. SUCH SEDIMENTATION CONTROL DEVICES SHALL INCLUDE BUT NOT BE LIMITED TO PROTECTIVE DITCHES, SEDIMENT TRAPS, SEDIMENT FILTERS, DITCH TRAPS, PIPE BARRIERS, AND FILTERS AS DETAILED AND REQUIRED AND WHERE INDICATED ON THE DRAWINGS. AFTER THE PROJECT WORK HAS BEEN COMPLETED, INSPECTED, AND APPROVED, THE CONTRACTOR SHALL REMOVE ALL SEDIMENTATION CONTROL DEVICES, MATERIAL, AND THEIR COLLECTED SILT AND DEBRIS AND RESTORE THE AREA IN ACCORDANCE WITH THE DRAWINGS.

IN ROADWAY AREAS TEMPORARY AGGREGATE SURFACING SHALL BE PLACED IMMEDIATELY AFTER THE BACKFILLING OPERATION HAS BEEN COMPLETED. POSITIVE DUST CONTROL MEASURES SHALL BE TAKEN AT ALL TIMES.

PERMANENT STABILIZATION SHALL BE COMPLETED WITHIN 5 DAYS OF FINAL EARTH CHANGE. FINAL CLEANUP AND RESTORATION WILL CONSIST OF FINAL GRADING, TOPSOILING, SEEDING AND MULCHING AND/OR SODDING OF ALL DISTURBED AREAS OF THE PROJECT.

IF SEASONAL CONDITIONS PREVENT FINAL CLEANING AND RESTORATION, THE CONTRACTOR SHALL PROCEED WITH TEMPORARY STABILIZATION OF THE DISTURBED AREA. TEMPORARY STABILIZATION SHALL CONSIST OF ROUGH GRADING THE DISTURBED AREA IN ACCORDANCE WITH THESE SPECIFICATIONS. TEMPORARY STABILIZATION MATERIALS SHALL BE REMOVED AND DISPOSED OF AND FINAL CLEANUP AND RESTORATION SHALL BE COMPLETED NOT LATER THAN 5 DAYS AFTER SEASONAL CONDITIONS ALLOW PERFORMANCE OF THE REQUIRED WORK.

SOIL EROSION AND SEDIMENTATION CONTROL, TEMPORARY FACILITIES

DETAIL NO. 015713-10

NOT TO SCALE

SOIL EROSION AND SEDIMENTATION CONTROL MAINTENANCE NOTES

THE CONTRACTOR SHALL INSPECT SOIL EROSION AND SEDIMENTATION CONTROL DEVICES WEEKLY AND WITHIN 24 HOURS OF A SIGNIFICANT RAIN EVENT. THE CONTRACTOR SHALL BE RESPONSIBLE FOR MAINTAINING THE SOIL EROSION AND SEDIMENTATION CONTROL

MAINTENANCE INCLUDES ALL WORK NECESSARY FOR PROPER OPERATION OF THE DEVICES. DEVICES WHICH CAN NOT BE REPAIRED MAY NEED TO BE REPLACED. MAINTENANCE OF THE DEVICES SHALL BE PERFORMED WITHIN 24 HOURS OF INSPECTION.

SEDIMENT SHALL BE REMOVED AS NECESSARY TO MAINTAIN THE EFFECTIVENESS OF SOIL EROSION AND SEDIMENTATION CONTROL DEVICES.

SEDIMENT DEPOSITED ALONG SILT FENCE SHALL BE REMOVED WHEN IT REACHES 1/3 TO 1/2 THE HEIGHT OF THE FENCE.

TURF ESTABLISHMENT MEASURES SHALL BE MAINTAINED AS WOULD ANY OTHER DEVICES PRIOR TO ESTABLISHMENT OF PERMANENT TURF.


ALL MUD, DIRT AND DEBRIS TRACKED ONTO EXISTING ROADS FROM THIS SITE SHALL BE PROMPTLY REMOVED BY THE CONTRACTOR.

CONTRACTOR SHALL ENSURE THAT SOIL EROSION AND SEDIMENTATION CONTROL MEASURES PROTECT AGAINST LOSS OF SOIL BY THE ACTION OF WATER, ICE, GRAVITY OR

SOIL EROSION AND SEDIMENTATION CONTROL, MAINTENANCE NOTES

DETAIL NO. 015713-11

NOT TO SCALE

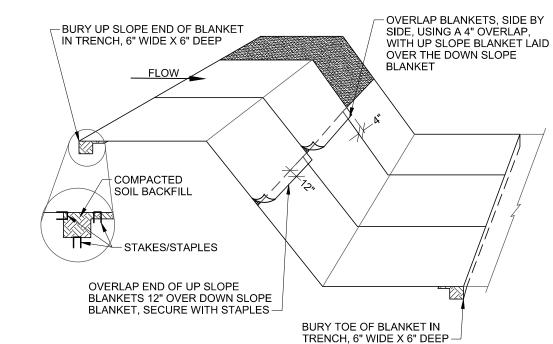


NOTES:

- 1. PLACE MULCH BLANKET PARALLEL TO FLOW AND ANCHOR SECURELY.
- WHEN BLANKETS ARE USED IN FLOWING DITCH, BLANKETS SHOULD NOT OVERLAP IN DITCH CENTER, PARALLEL TO FLOW.
- STAPLES INSTALLED/SECURED ACCORDING TO MANUFACTURER'S SPECIFICATIONS.
 WHERE POSSIBLE, CONSTRUCT WITH BIODEGRADABLE MATERIAL.

MULCH BLANKETS DETAIL NO. 015713-20


NOT TO SCALE

EXAMPLE: LENGTH OF BUFFER ZONE = 80' % OF SLOPE OF BUFFER ZONE = 5%

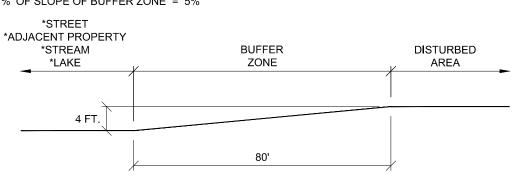

THE GRAPH SHOWN BELOW IS USED TO DETERMINE THE ADEQUACY OF AN EXISTING VEGETATIVE BUFFER ZONE FOR USE AS A SEDIMENT FILTER. THIS GRAPH IS ONLY APPLICABLE IF THE VEGETATION IS 90% DENSE AND AT LEAST 1" IN LENGTH OVER EVERY SQUARE FOOT OF DISTURBED SOIL. AN AREA COVERED WITH WEEDS OR BUSHES AND TREES, WITHOUT A GOOD GROUND COVER, IS NOT ACCEPTABLE.

ELEVATION VIEW

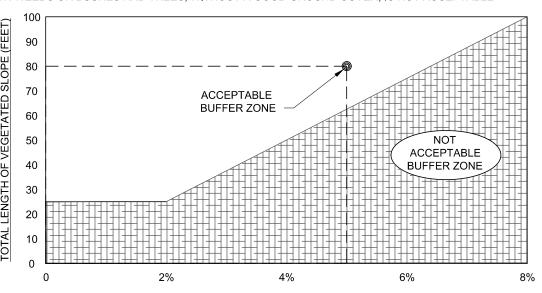

SLOPE OF VEGETATED SLOPE (PERCENT)
VEGETATIVE BUFFER STRIP CHART

VEGETATIVE BUFFER STRIP

DETAIL NO. 015713-09

SUMMARY OF BASIC PRINCIPLES:

- KEEP DISTURBED AREA AS SMALL AS POSSIBLE.
- 2. STABILIZE AND/OR PROTECT DISTURBED AREAS AS SOON AS POSSIBLE.
- 3. KEEP STORM WATER RUNOFF VELOCITIES LOW.
- 4. RETAIN SEDIMENT WITHIN IMMEDIATE CONSTRUCTION AREA.

THE PURPOSE OF THIS PLAN IS TO SPECIFY METHODS FOR TEMPORARY EROSION CONTROL DURING CONSTRUCTION. IT IS INTENDED THAT MEASURES CALLED FOR IN THE SPECIFICATIONS AND SHOWN ON THESE STANDARD DETAILS PLANS BE STRICTLY ADHERED TO. IT SHALL BE THE RESPONSIBILITY OF THE CONTRACTOR TO ASSURE THAT CONSTRUCTION PROCEDURES UNDERTAKEN BE IN CONFORMANCE WITH THE STATE OF MICHIGAN ACT 451 OF 1994 PART 91, SOIL EROSION AND SEDIMENTATION CONTROL.

ALL SOIL EROSION AND SEDIMENTATION CONTROL DEVICES SHALL BE REGULARLY MAINTAINED BY THE CONTRACTOR THROUGHOUT THE DURATION OF THE PROJECT. COLLECTED SILT AND SEDIMENTATION SHALL BE REMOVED PERIODICALLY TO MAINTAIN THE EFFECTIVENESS OF THE SILT TRAPS OR SEDIMENTATION CONTROL DEVICES. WHERE REQUIRED, THE CONTRACTOR SHALL REPLACE FILTER MATERIALS WHICH HAVE BECOME INEFFECTIVE DUE TO CONTAMINATION OR PHYSICAL DETERIORATION.

IF POSSIBLE, NO GRUBBING SHOULD BE DONE WITHIN 30' OF AN ACTIVE WATERCOURSE.


AGGREGATES PLACED IN STREAMS SHOULD CONTAIN A MINIMUM OF FINES. AS A GENERAL RULE FOR DAMS IN SMALL STREAMS, AT LEAST 50 STONE SHOULD BE 6" DIAMETER OR LARGER. 3" OR LARGER STONE SHALL BE USED FOR LINING STREAM BOTTOMS WHERE LINING IS REQUIRED.


ALL TEMPORARY EROSION CONTROL FACILITIES SHOULD BE REMOVED BY THE CONTRACTOR AT THE COMPLETION OF CONSTRUCTION UNLESS ORDERED BY THE ENGINEER TO BE LEFT IN PLACE. CARE SHALL BE TAKEN DURING REMOVAL TO MINIMIZE SILTATION IN NEARBY DRAINAGE COURSES.


SURFACE DISRUPTION IN ADVANCE OF CONSTRUCTION INCLUDING CLEARING, GRADING OR SIGNIFICANT SOD REMOVAL SHALL BE LIMITED AS FOLLOWS, UNLESS PERMISSION IS OTHERWISE OBTAINED FROM THE GOVERNING AGENCY:


- A. WET WEATHER SEASON (MARCH, APRIL, MAY) 5 DAYS PRIOR TO BEGINNING ANY EARTH CHANGE ACTIVITY.
- B. DRY WEATHER SEASON (JUNE, JULY, AUGUST, SEPTEMBER, OCTOBER, NOVEMBER) 10 DAYS PRIOR TO BEGINNING ANY EARTH CHANGE ACTIVITY.
- C. COLD WEATHER SEASON (DECEMBER, JANUARY, FEBRUARY) 15 DAYS PRIOR TO BEGINNING ANY EARTH CHANGE ACTIVITY.


SOIL EROSION AND SEDIMENTATION CONTROL, GENERAL NOTES DETAIL NO. 015713-12

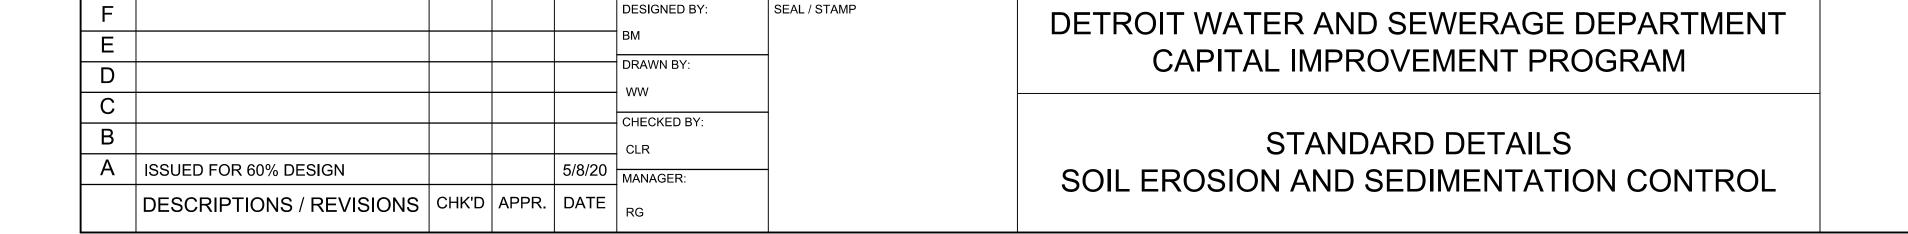


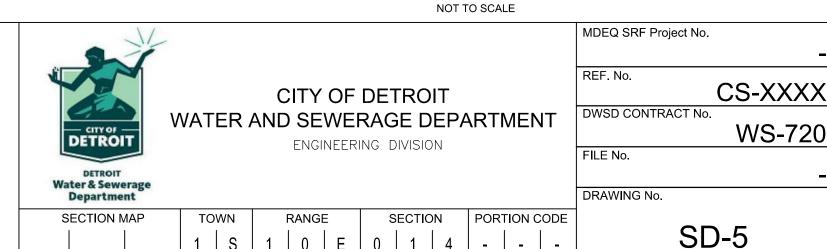


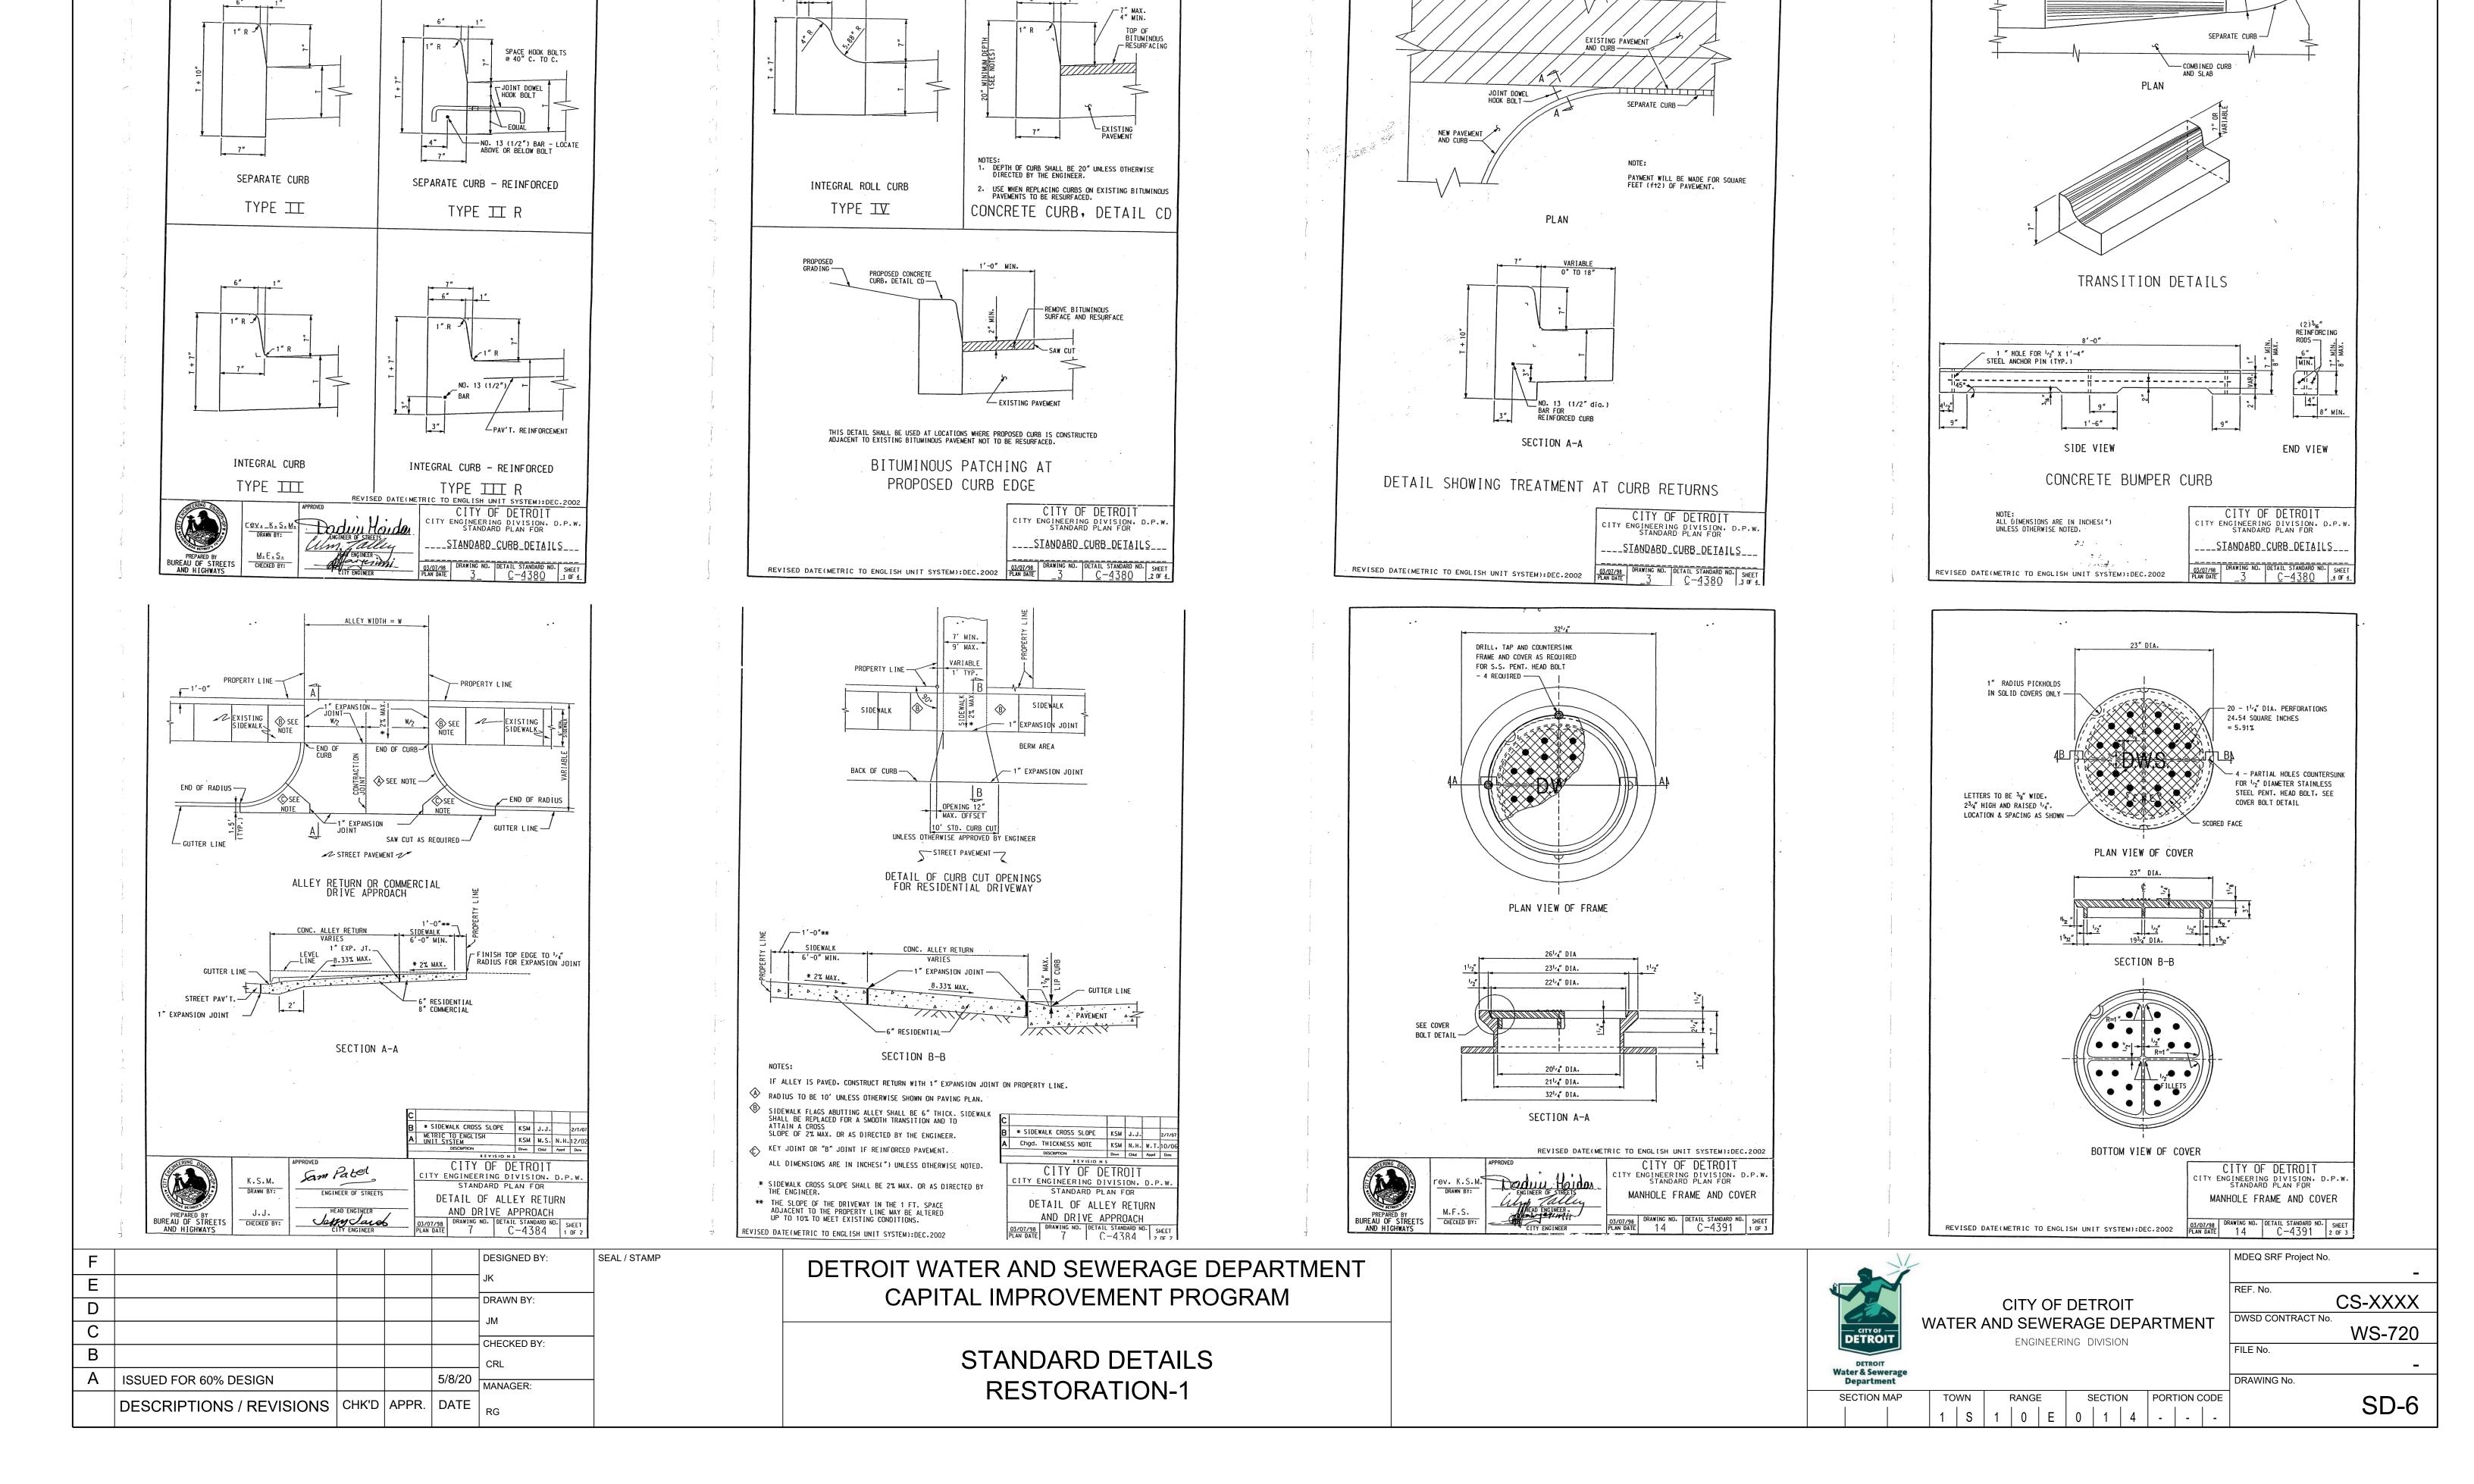


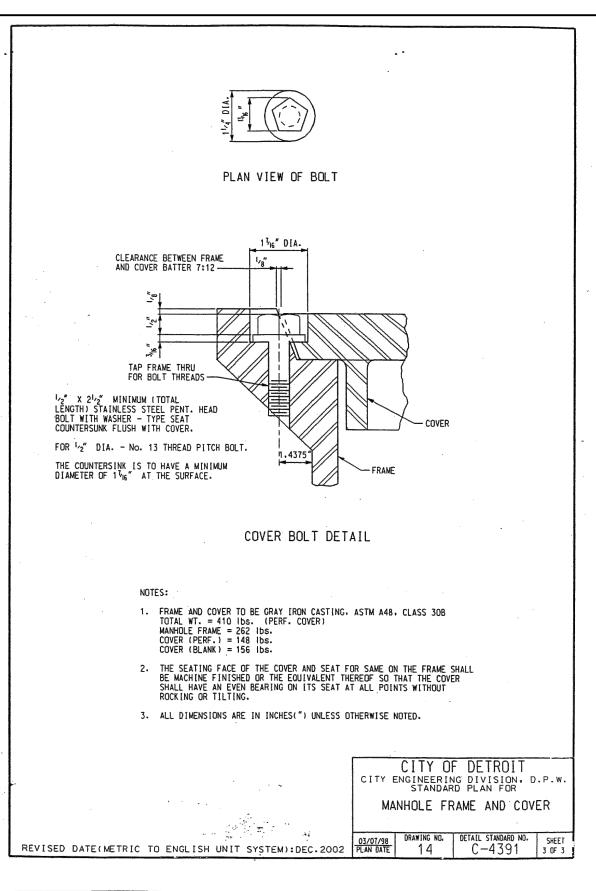


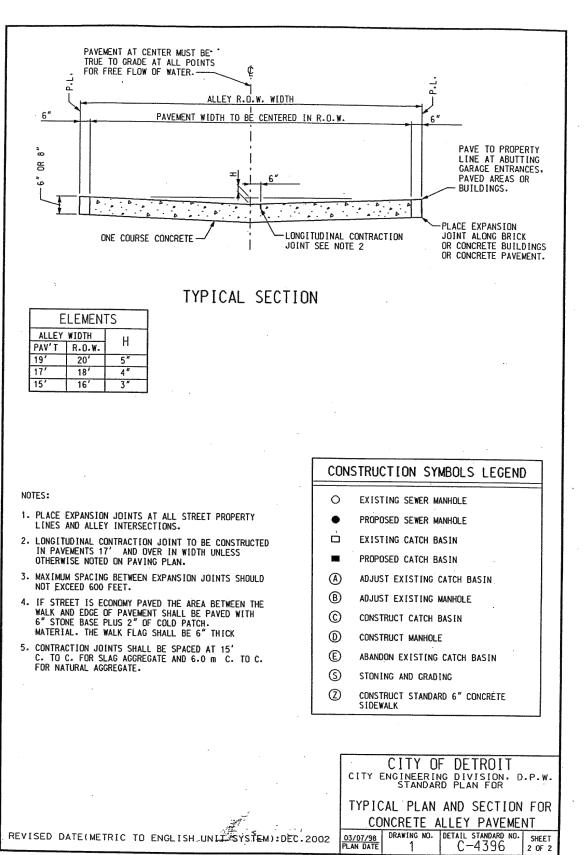


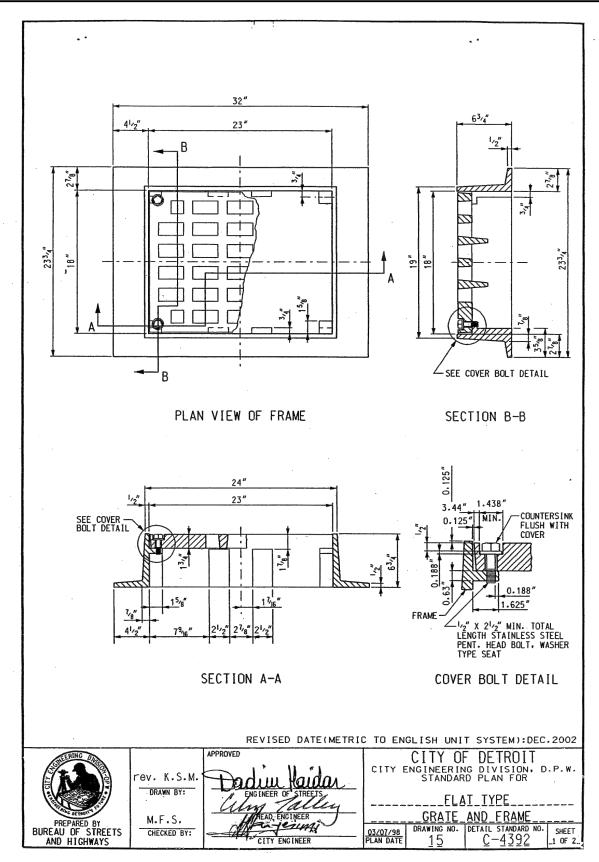


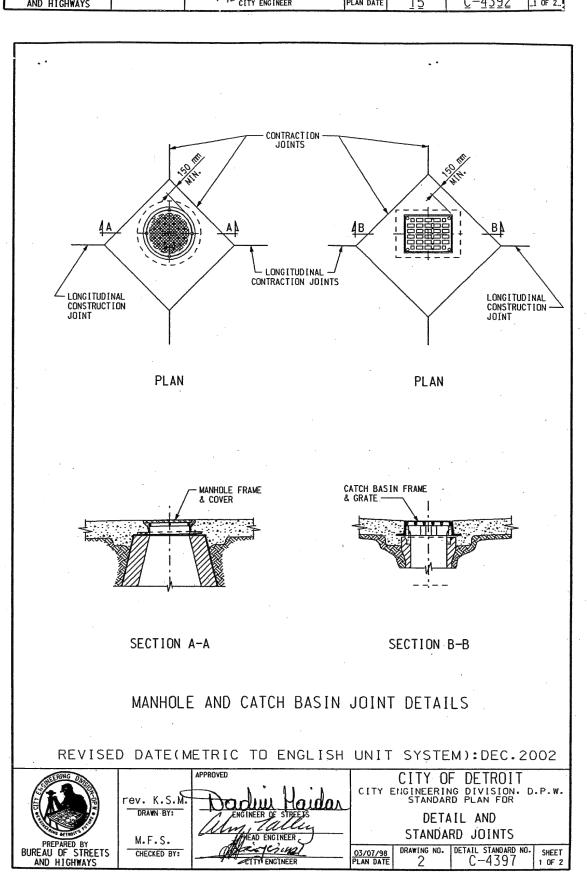


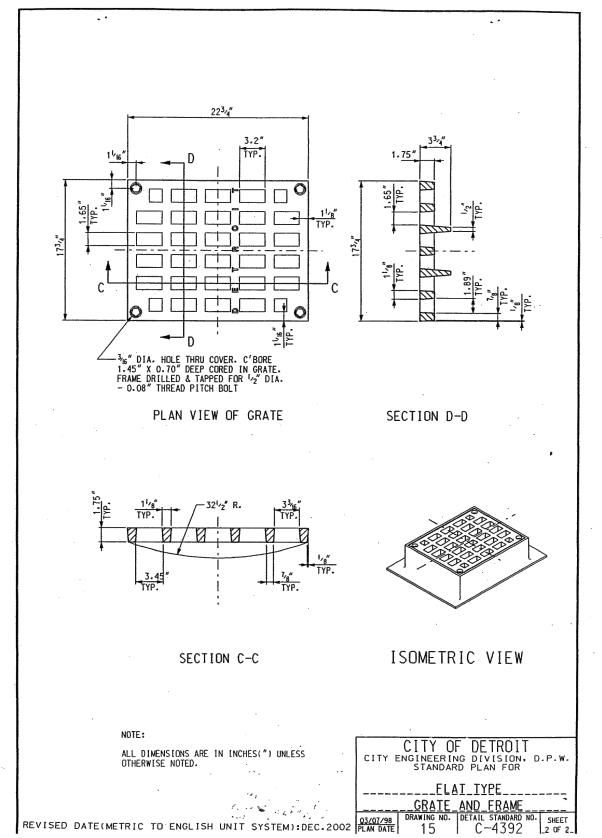

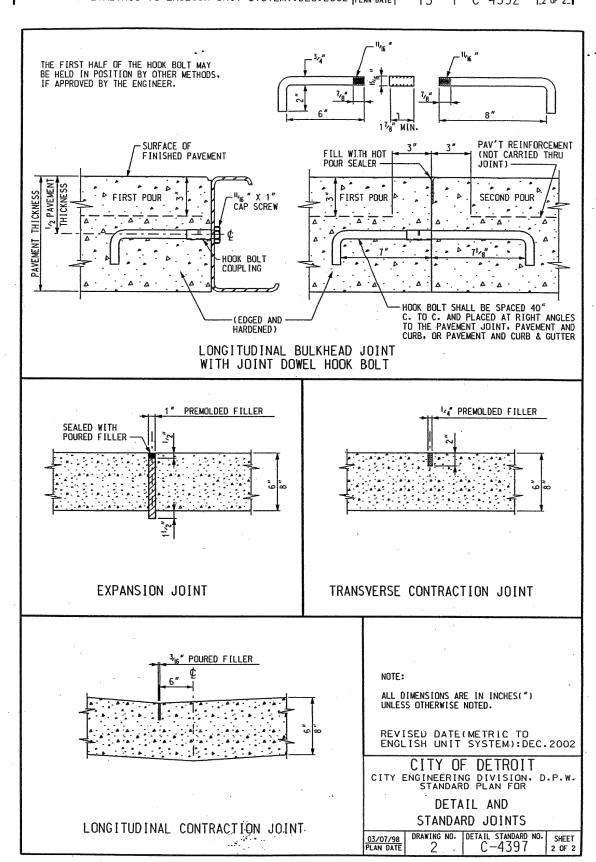

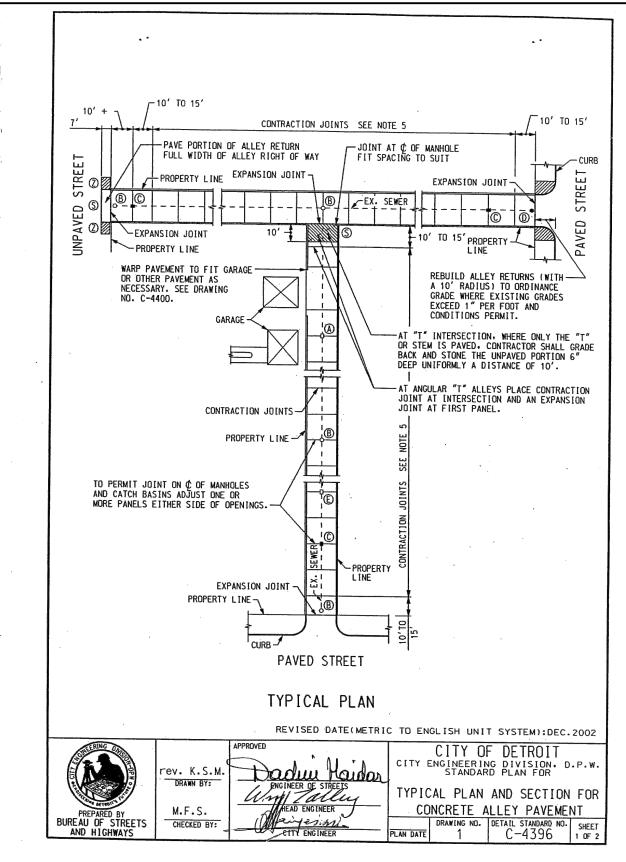

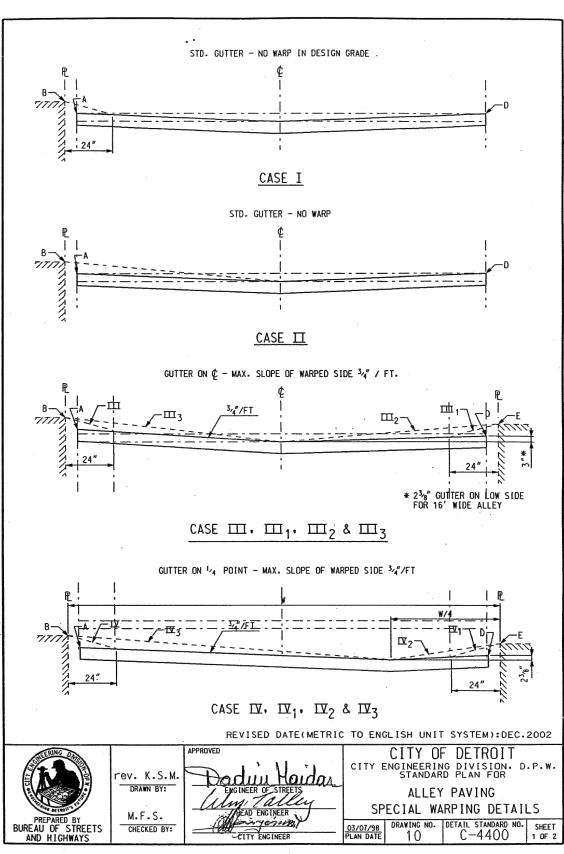


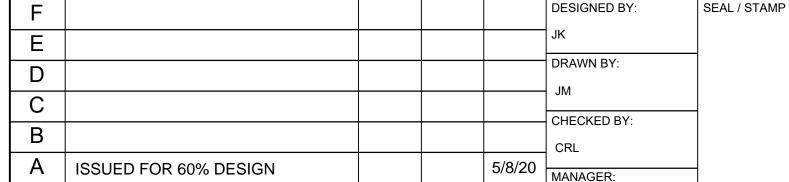


DESCRIPTIONS / REVISIONS | CHK'D | APPR. | DATE


DETROIT WATER AND SEWERAGE DEPARTMENT CAPITAL IMPROVEMENT PROGRAM

STANDARD DETAILS RESTORATION-2

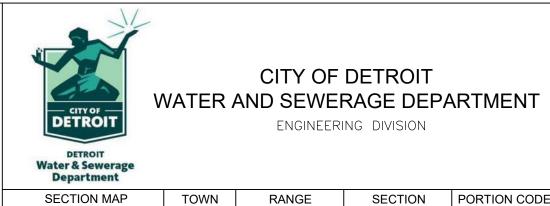

MDEQ SRF Project No.	
	-
REF. No.	CS-XXXX
DWSD CONTRACT No	
	WS-720
FILE No.	-
DRAWING No.	
	SD-7

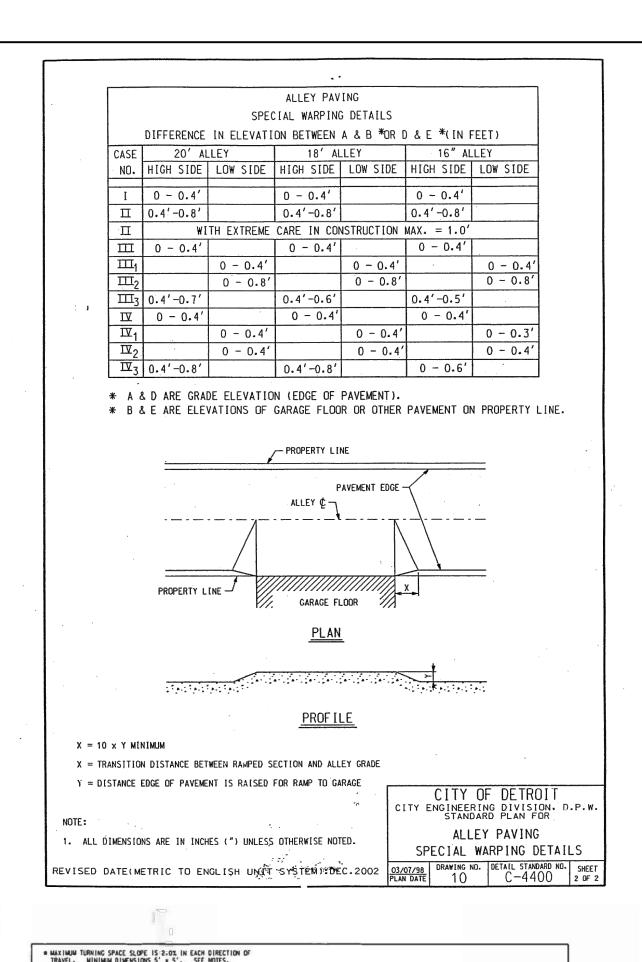

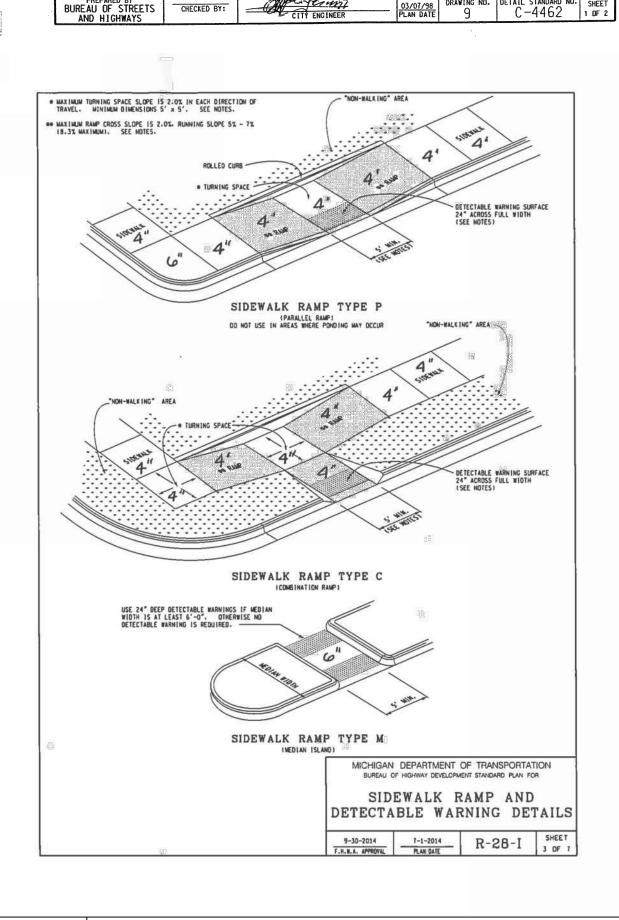



REVISED DATE (METRIC TO ENGLISH UNIT SYSTEM): DEC. 2002


CITY OF DETROIT


SIDEWALK JOINTING


STANDARD

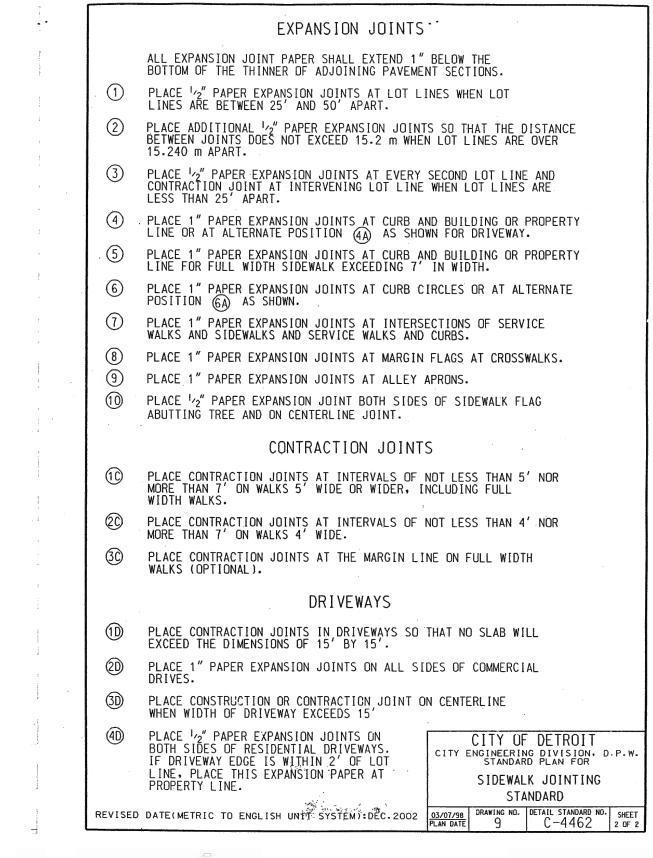


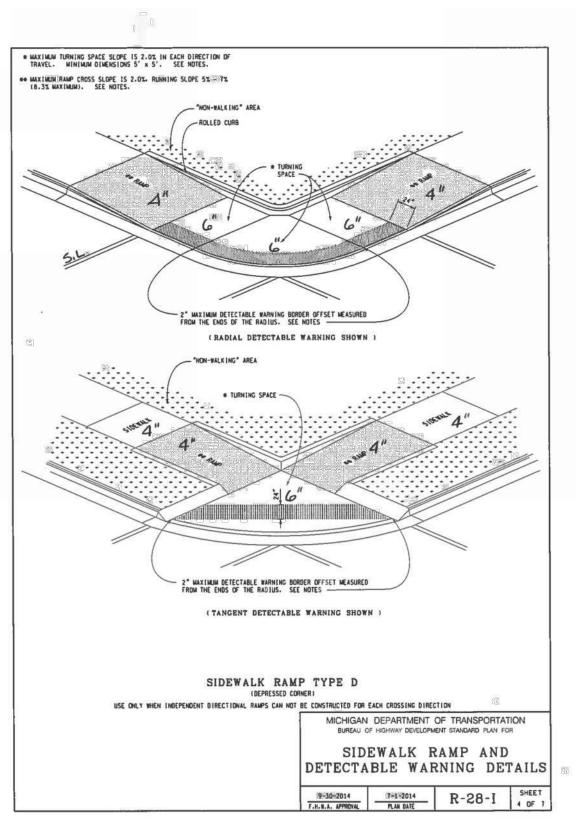

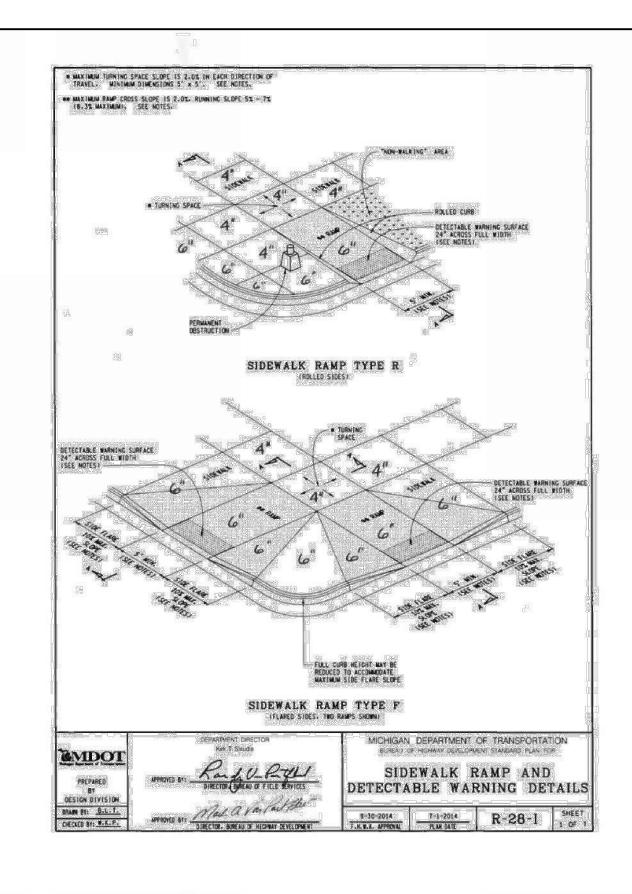

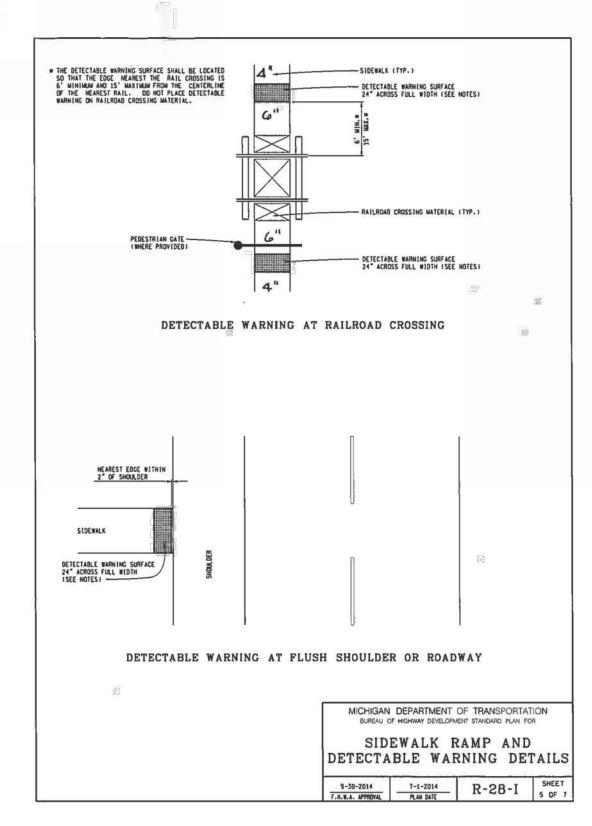


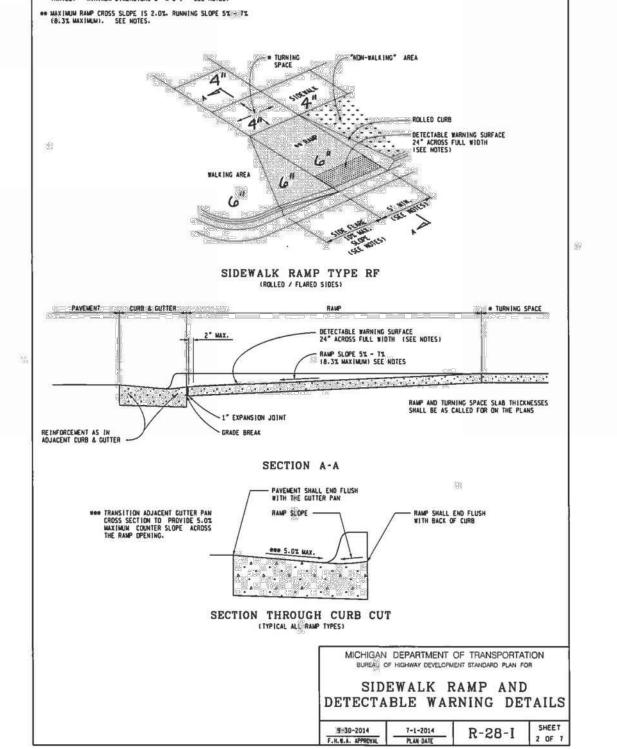

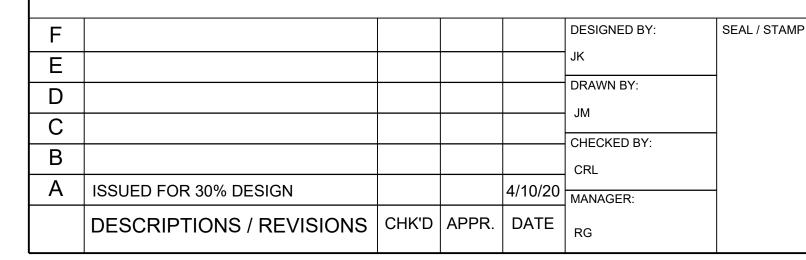

DETROIT WATER AND SEWERAGE DEPARTMENT CAPITAL IMPROVEMENT PROGRAM

STANDARD DETAILS RESTORATION-3

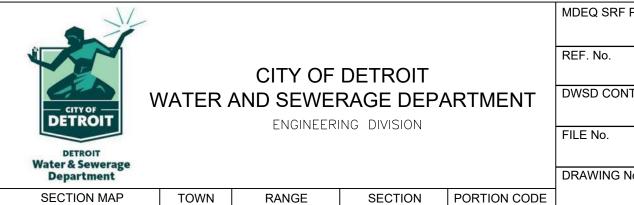

MDEQ SRF Project No.

REF. No.

CS-XXXX


DWSD CONTRACT No.


WS-720


FILE No.


DRAWING No.


SD-8

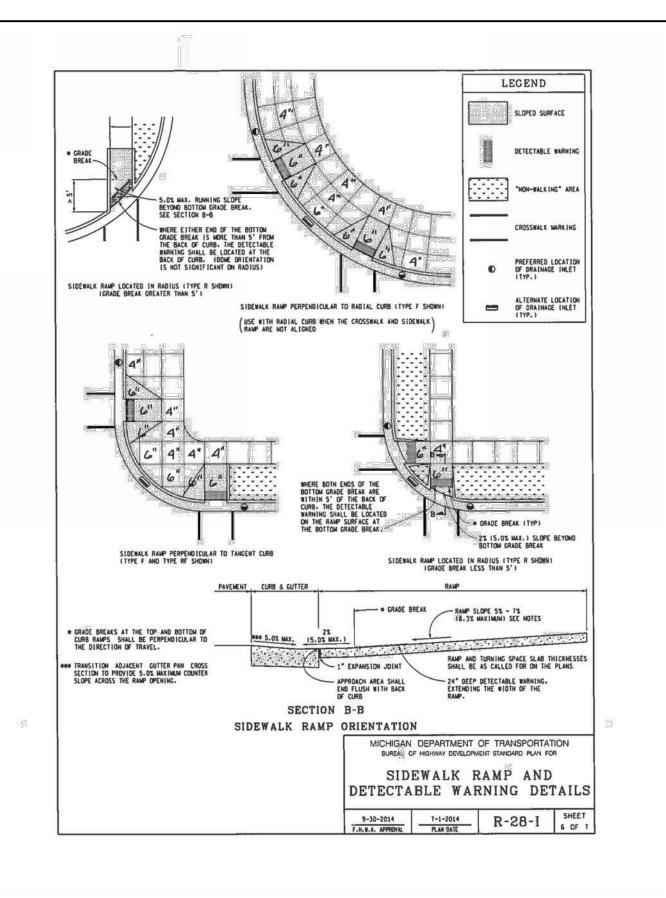


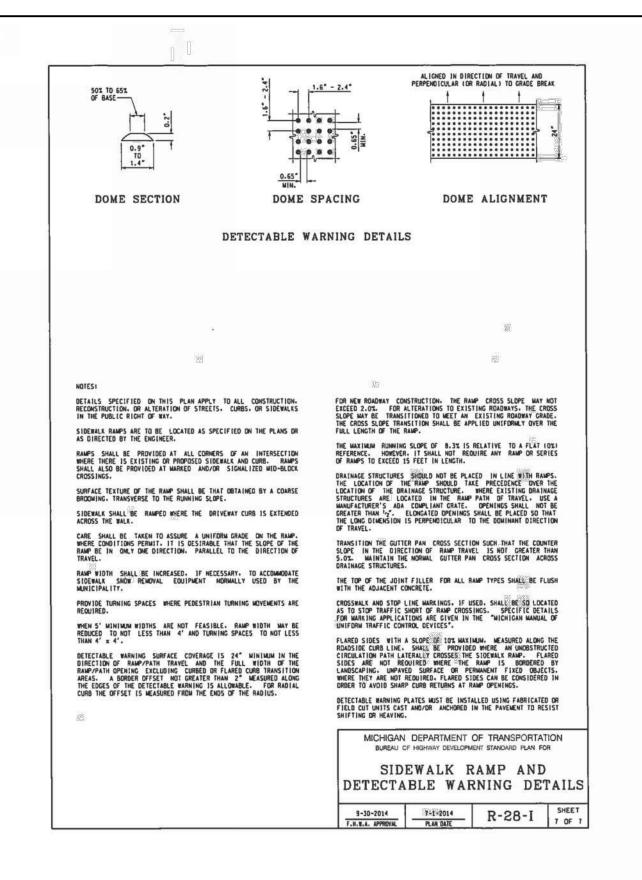

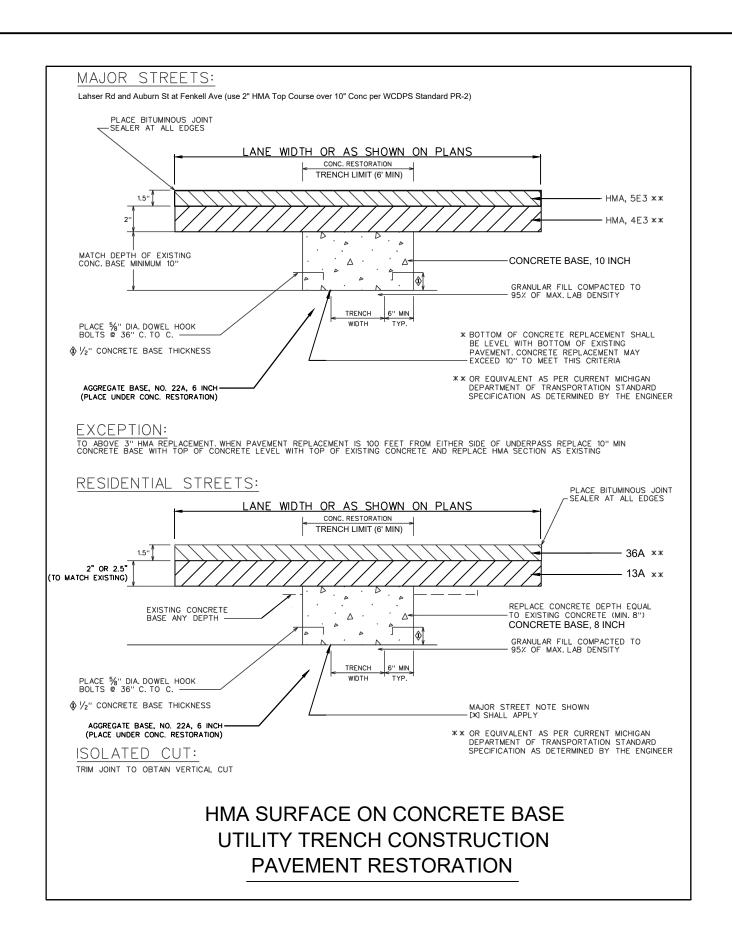

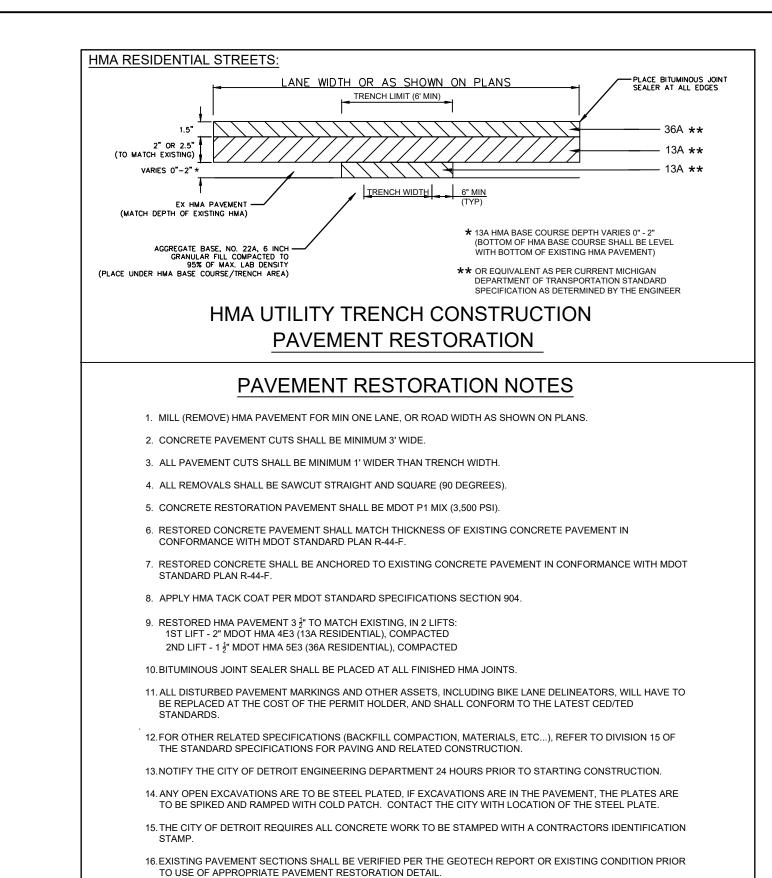

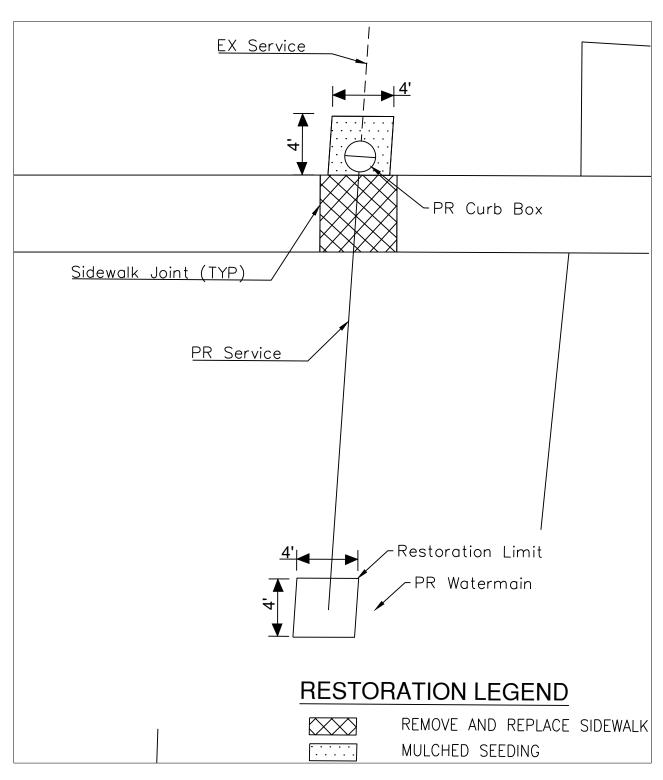

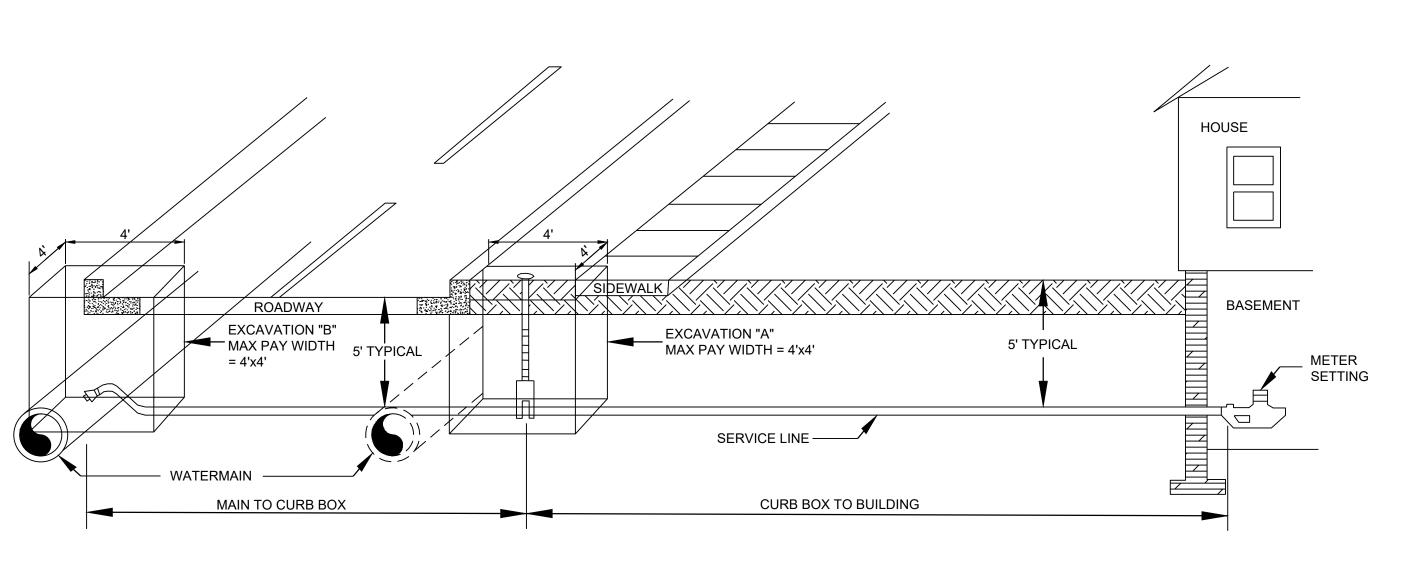

NEW WATER SERVICE LINE TO BE INSTALLED BY MEANS OF HORIZONTAL DIRECTIONAL DRILLING. CONTRACTOR TO VERIFY EXISTING UTILITIES PRIOR TO HORIZONTAL DIRECTIONAL DRILLING, AS REQUIRED.

TYPICAL RESTORATION AT CURB BOX

TYPICAL SERVICE RESTORATION PITS

		1			T		
F					DESIGNED BY:	SEAL / STAMP	DETROIT WATER AND SEWERAGE DEPARTMENT
E					JK		
D					DRAWN BY:		CAPITAL IMPROVEMENT PROGRAM
C					- JM		
<u> </u>					CHECKED BY:		
В					CRL		STANDARD DETAILS
A	ISSUED FOR 60% DESIGN			5/8/20	MANAGER:		RESTORATION-4
	DESCRIPTIONS / REVISIONS	CHK'D	APPR.	DATE	RG		RESTORATION-4

	-				MDEQ
					REF. N
		CITY OF	DETROIT		
(4)	WATER A	AND SEWER	RAGE DEPA	ARTMENT	DWSD
DETROIT		FNGINFFRI	NG DIVISION		
		2	.,,,,,,,,,,,,,,,,,,,,,,,,,,,,,,,,,,,,,,		FILE N
Water & Sewerage					
Department					DRAW
SECTION MAP	TOWN	RANGE	SECTION	PORTION CODE	

1 0 E 0 1 4 - - -

MDEQ SRF Project No.

REF. No.

CS-XXXX

DWSD CONTRACT No.

WS-720

FILE No.


DRAWING No.

SD-9

LANDSCAPING NOTES


- 1. PLANTING TIMES AND PROCEDURES. SEE SEEDING AND PLANTS SPECIFICATIONS FOR PLANTING PROCEDURES AND ACCEPTABLE PLANTING TIMES.
- 2. SITE RESTORATION. RESTORE ALL DISTURBED AREAS WITH LAWN SEED PER SEEDING SPECIFICATION.
- 3. TREE PLANTING. REFER TO DETAIL G/70 AND PLANTS SPECIFICATION FOR TREE PLANTING REQUIREMENTS.
- 4. REPLACEMENT TREES. ALL TREES THAT WERE REMOVED FOR WATER AND SEWER WORK SHALL BE REPLACED ON A 1:1 BASIS. PLANT NEW TREES AS CLOSE TO ORIGINAL LOCATION AS POSSIBLE TREE SPECIES SHALL BE SUPPLIED IN THE QUANTITIES AND SIZES SPECIFIED IN THE PLANTING SCHEDULE BELOW. CONTRACTOR SHALL CHOOSE WHICH TREE SPECIES TO PLANT IN EACH REPLACEMENT TREE LOCATION, MAKING SURE THAT PLANTING CONDITIONS COMPLY WITH THE NOTES STATED IN THE PLANTING SCHEDULE BELOW.

	PLANTING SCHEDULE										
KEY	QTY	SCIENTIFIC NAME	COMMON NAME	SIZE	CONTAINER	NOTES					
PA	_	PLANTANUS X ACERIFOLIA 'BLOODGOOD'	LONDON BLOODGOOD PLANETREE	2" CAL.	B&B	SPECIES TO BE USED ONLY IN PLANTING STRIPS GREATER THAN OR EQUAL TO 8 FEET WIDE					
UA	_	ULMUS AMERICANA 'PRINCETON'	PRINCETON ELM	2" CAL.	B&B	SPECIES TO BE USED ONLY IN PLANTING STRIPS GREATER THAN OR EQUAL TO 8 FEET WIDE					
QB	_	QUERCUS BICOLOR	SWAMP WHITE OAK	2" CAL	B&B	SPECIES TO BE USED ONLY IN PLANTING STRIPS GREATER THAN OR EQUAL TO 8 FEET WIDE					
QS	_	QUERCUS SCHUMARDII	SHUMARD OAK	2" CAL	B&B	SPECIES TO BE USED ONLY IN PLANTING STRIPS GREATER THAN OR EQUAL TO 8 FEET WIDE					
AR	_	ACER RUBRUM 'RED SUNSET'	RED SUNSET MAPLE	2" CAL	B&B	SPECIES TO BE USED ONLY IN PLANTING STRIPS GREATER THAN OR EQUAL TO 8 FEET WIDE					
TA	_	TILIA AMERICANA	BASSWOOD	2" CAL	B&B	SPECIES TO BE USED ONLY IN PLANTING STRIPS GREATER THAN OR EQUAL TO 8 FEET WIDE					
ZS	_	ZELKOVA SERRATA 'GREEN VASE'	GREEN VASE ZELKOVA	2" CAL	B&B	SPECIES TO BE USED ONLY IN PLANTING STRIPS LESS THAN 8 FEET WIDE					
GTI	_	GLEDITSIA TRIACANTHOS INERMIS	THORNLESS HONEYLOCUST	2" CAL	B&B	SPECIES TO BE USED ONLY IN PLANTING STRIPS LESS THAN 8 FEET WIDE					
МС	_	MALUS X CENTZAN	CENTURION CRABAPPLE	2" CAL	B&B	SPECIES TO BE USED AT LOCATIONS WITHIN 10 FEET OF OVERHEAD POWER LINES					
AG	_	AMENANCHIER X GRANDFLORA 'AUTUMN BRILLIANCE'	AUTUMN BRILLIANCE SERVICEBERRY	2" CAL	B&B	SPECIES TO BE USED AT LOCATIONS WITHIN 10 FEET OF OVERHEAD POWER LINES					

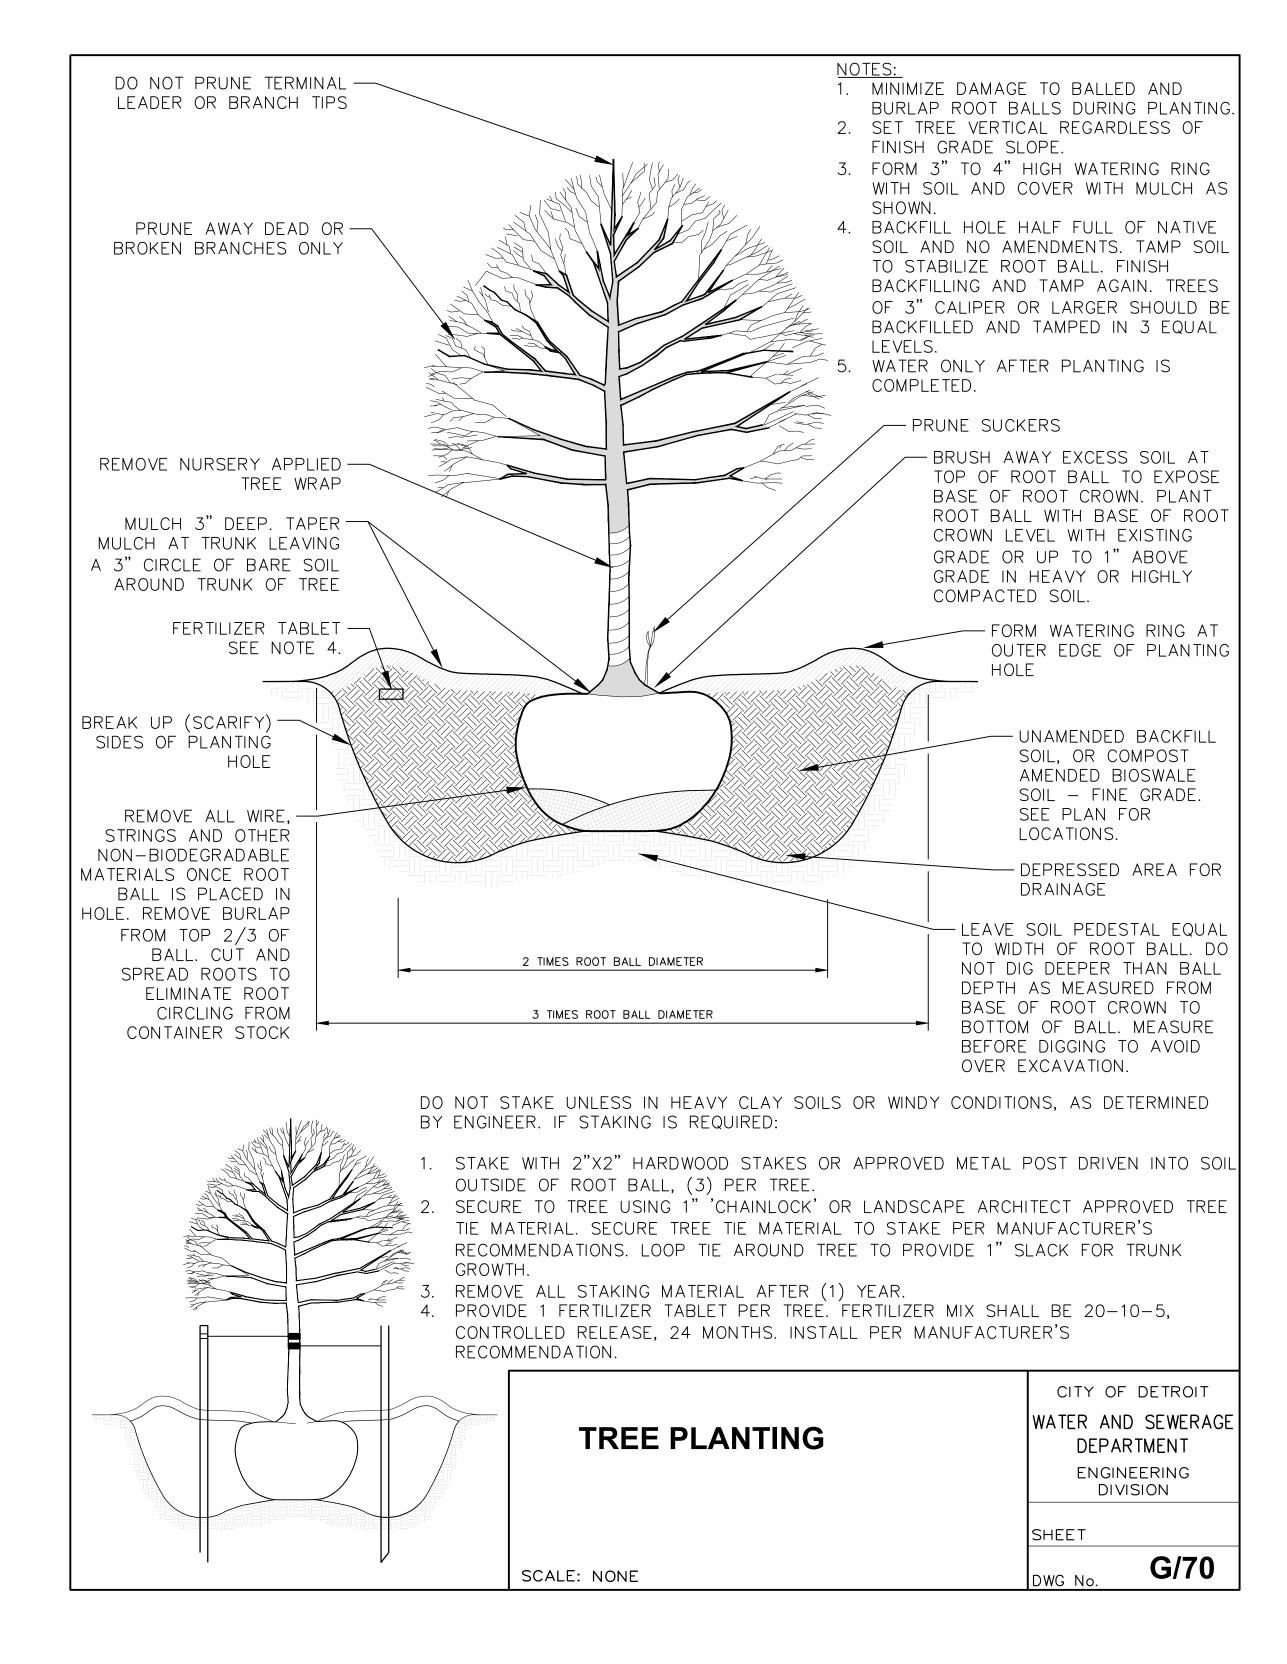




F	DESIGNED BY: SEAL / STAMP	DETROIT WATER AND SEWERAGE DEPARTMENT	MI	IDEQ SRF Project No.
E	JK		RE	EF. No.
D	DRAWN BY:	CAPITAL IMPROVEMENT PROGRAM	CITY OF DETROIT	CS-XXXX
C				WSD CONTRACT No. WS-720
D	CHECKED BY:		ENGINEERING DIVISION FI	VV 3-7 20 ILE No.
<u> </u>	TW	RESTORATION TREE PLANTING SCHEDULE	DETROIT Water & Sewerage Department DF	-
A ISSUED FOR 60% DESIGN	MANAGER:	AND DETAIL		RAWING No.
DESCRIPTIONS / REVISIONS CHK'D AF	APPR. DATE RG	AND DETAIL	SECTION MAP TOWN RANGE SECTION PORTION CODE	SD-10

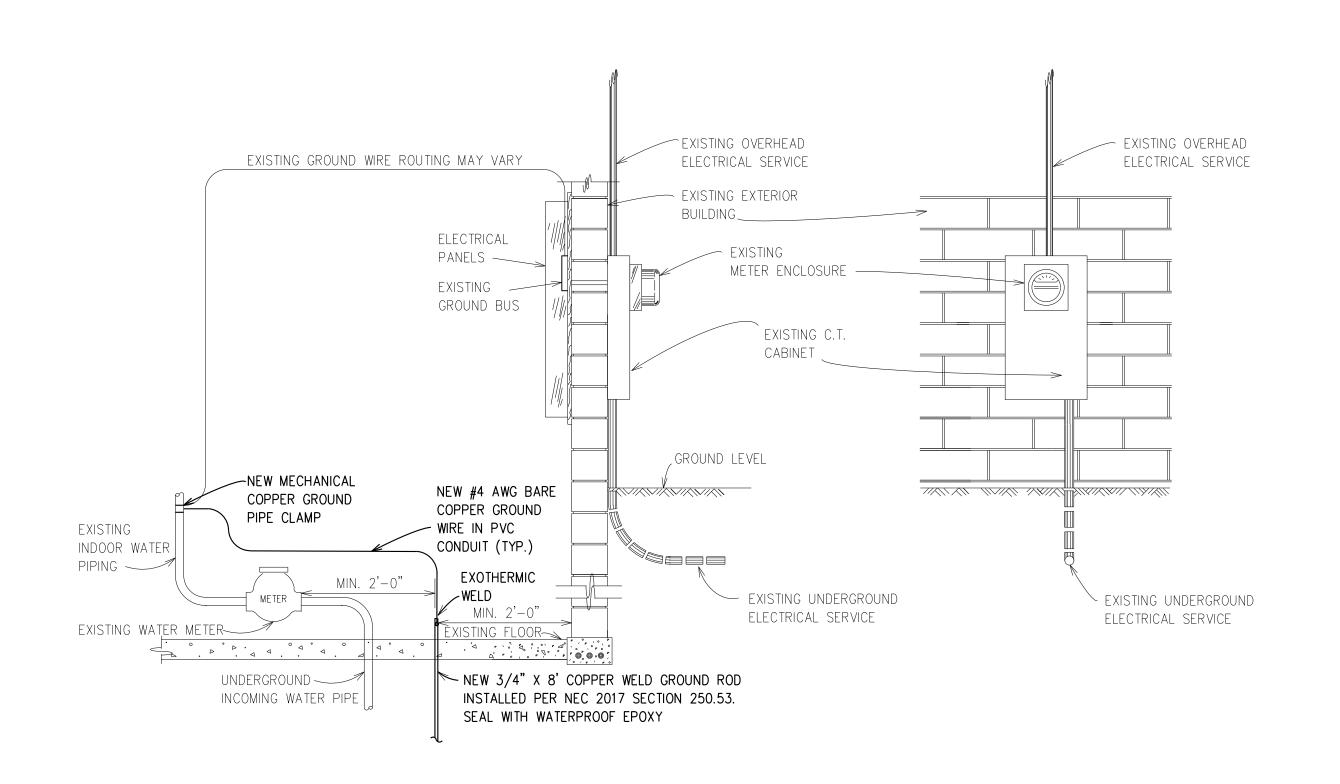

INDOOR INSTALLATION

OUTDOOR INSTALLATION

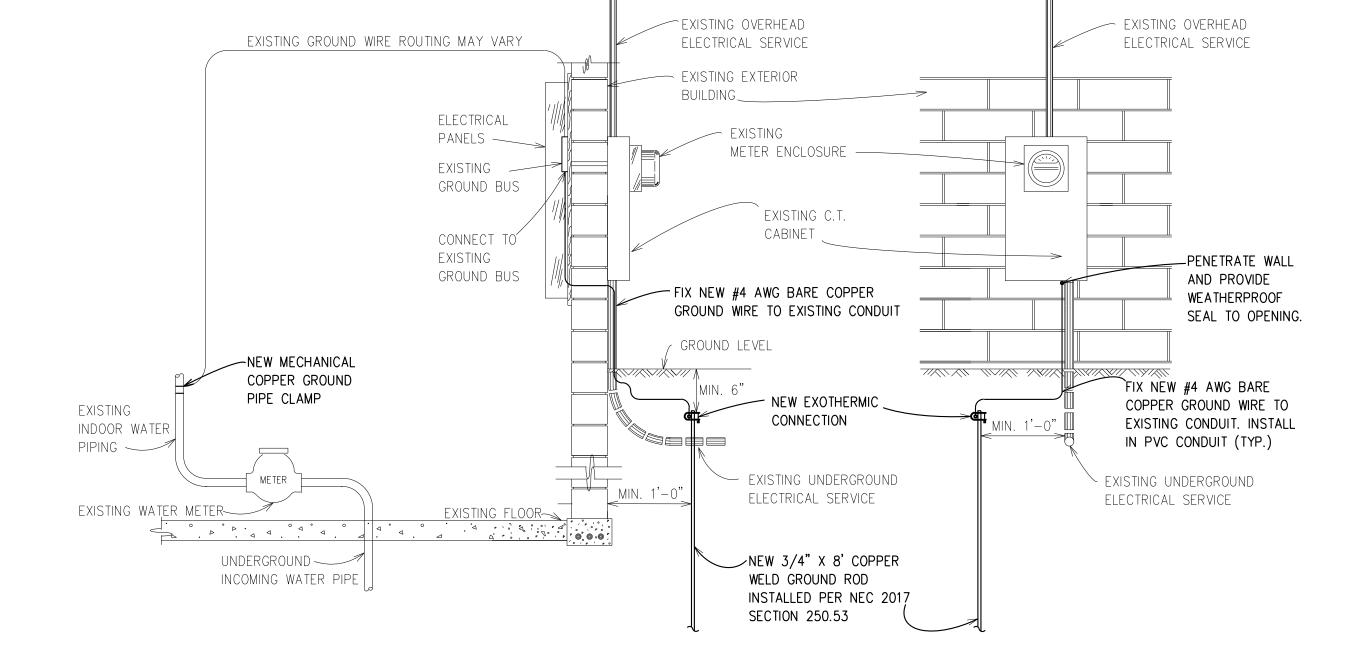

						1
F					DESIGNED BY:	SEAL / STAMP
Е					CRL	
D					DRAWN BY:	
С					DZ	
В					CHECKED BY:	
					RB	
A	ISSUED FOR 60% DESIGN			5/8/20	MANAGER:	
	DESCRIPTIONS / REVISIONS	CHK'D	APPR.	DATE	RG	

DETROIT WATER AND SEWERAGE DEPARTMENT CAPITAL IMPROVEMENT PROGRAM

ELECTRICAL SERVICE ENTRANCE DETAILS

DETROIT Water & Sewerage Department	WATER A	AND SEWEI	DETROIT RAGE DEPA	ARTMENT	MDEQ SRF Project No. REF. No. CS-XXXX DWSD CONTRACT No. WS-720 FILE No. DRAWING No.
SECTION MAP	TOWN 1 S	RANGE	SECTION 0 1 4	PORTION CODE	SD-11

MIKE DUGGAN, MAYOR CITY OF DETROIT WATER AND SEWERAGE DEPARTMENT ENGINEERING DIVISION

CONTRACT NO. DWS-916 SEWER IMPROVEMENTS AT PIETY HILL, VIRGINIA PARK, NEW CENTER COMMONS, BREWSTER HOMES, AND BREWSTER DOUGLASS HIGH PRIORITY NEIGHBORHOODS

CONTRACT DRAWINGS

APRIL 1, 2020



DETROIT
Water & Sewerage
Department

DETROIT CITY COUNCIL

BRENDA JONES, PRESIDENT
MARY SHEFFIELD, PRESIDENT PRO TEM
JANEÉ AYERS, AT LARGE
ANDRÉ L. SPIVEY
JAMES TATE
SCOTT BENSON
RAQUEL CASTAÑEDA-LÓPEZ
GABE LELAND
ROY McCALISTER JR.

BOARD OF WATER COMMISSIONERS

MICHAEL EINHEUSER, CHAIRMAN
MARY E. BLACKMON, VICE CHAIRPERSON
LANE COLEMAN
JOHN HENRY DAVIS
LINDA D. FORTE
JANE C. GARCIA
JONATHAN C. KINLOCH



EXECUTIVE/ADMINISTRATIVE STAFF

GARY BROWN DIRECTOR

PALENCIA MOBLEY, P.E.
DEPUTY DIRECTOR/CHIEF ENGINEER

MOHAMAD FARHAT, P.E. DIRECTOR OF ENGINEERING AND CONSTRUCTION

TIMOTHY CAVITT CHIEF OPERATING OFFICER THOMAS NAUGHTON

CHIEF FINANCIAL OFFICER

ENGINEER


PR2020-019

DPW PERMIT No.:

EGLE PERMIT No.: P41002552 v. 1

HDC PERMIT No.: 19-6708

SHEET NO.	DESCRIPTION COVER
G-1	INDEX SHEET
G-2	SCHEDULE OF QUANTITIES - SEWER AND RESTORATION
G-3	HIGH PRIORITY NEIGHBORHOODS - LOCATION MAP
G-4	BREWSTER HOMES AND BREWSTER DOUGLAS - SEWER INTERVENTIONS MAP SHEET 1 OF 2
G-5	PIETY HILL, VIRGINIA PARK, AND NEW CENTER - SEWER INTERVENTIONS MAP SHEET 2 OF 2
G-6	ABBREVIATION AND GENERAL NOTES
G-7	SOIL EROSION AND SEDIMENTATION CONTROL NOTES AND C.E.D. NOTES
	PIPE AND MANHOLE REHABILITATION REPAIRS
NDEX - P&MH	PIPE AND MANHOLE REHABILITATION REPAIRS
A - P&MH (1 OF 2)	PIPE AND MANHOLE REHABILITATION REPAIRS
A - P&MH (2 OF 2)	PIPE AND MANHOLE REHABILITATION REPAIRS
B - P&MH (1 OF 2)	PIPE AND MANHOLE REHABILITATION REPAIRS
B - P&MH (2 OF 2)	PIPE AND MANHOLE REHABILITATION REPAIRS PIPE AND MANHOLE REHABILITATION REPAIRS
C - P&MH (1 OF 2)	PIPE AND MANHOLE REHABILITATION REPAIRS
C - P&MH (2 OF 2)	PIPE AND MANHOLE REHABILITATION REPAIRS
D - P&MH (1 OF 2)	PIPE AND MANHOLE REHABILITATION REPAIRS
D - P&MH (2 OF 2)	PIPE AND MANHOLE REHABILITATION REPAIRS
	PIPE AND MANHOLE REHABILITATION REPAIRS
E - P&MH (2 OF 2)	PIPE AND MANHOLE REHABILITATION REPAIRS
F - P&MH (1 OF 2)	PIPE AND MANHOLE REHABILITATION REPAIRS
	PIPE AND MANHOLE REHABILITATION CE AIRS
G - P&MH (1 OF 2)	PIPE AND MANHOLE REHABILITATION REPAIRS
G - P&MH (2 OF 2)	PIPE AND MANHOLE REHABILITATION REPAIRS
H - P&MH (1 OF 2)	PIPE AND MANHOLE REMABILITATION REPAIRS
	PIPE AND MANHOLE REHABILITATION REPAIRS
I - P&MH (1 OF 2)	PIPE AND MANHOLE REHABILITATION REPAIRS
I - P&MH (2 OF 2)	PIPE AND MANHOLE REHABILITATION REPAIRS
J - P&MH (1 OF 2)	PIPE AND MANHOLE REHABILITATION REPAIRS
	PIPE AND MANHOLE REHABILITATION REPAIRS
	OPERATION AND MAINTENANCE PIPE AND MANHOLE REHABILITATION REPAIRS
INDEX - O&M	
A - O&M (1 OF 2)	O&M PIPE AND MANHOLE REHABILITATION REPAIRS
A - O&M (2 OF 2)	O&M PIPE AND MANHOLE REHABILITATION REPAIRS
B - O&M (1 OF 2)	O&M PIPE AND MANHOLE REHABILITATION REPAIRS
B - O&M (2 OF 2)	O&M PIPE AND MANHOLE REHABILITATION REPAIRS
C - O&M (1 OF 2)	O&M PIPE AND MANHOLE REHABILITATION REPAIRS
C - O&M (2 OF 2)	O&M PIPE AND MANHOLE REHABILITATION REPAIRS
D - O&M (1 OF 2)	O&M PIPE AND MANHOLE REHABILITATION REPAIRS
D - O&M (2 OF 2)	O&M PIPE AND MANHOLE REHABILITATION REPAIRS
E - O&M (1 OF 2)	O&M PIPE AND MANHOLE REHABILITATION REPAIRS
E - O&M (2 OF 2)	O&M PIPE AND MANHOLE REHABILITATION REPAIRS
F - O&M (1 OF 2)	O&M PIPE AND MANHOLE REHABILITATION REPAIRS
F - O&M (2 OF 2)	O&M PIPE AND MANHOLE REHABILITATION AS AND MANHOLE REHABILITATION
G - O&M (1 OF 2)	O&M PIPE AND MANHOLE REHABILITATION REPAIRS
G - O&M (2 OF 2)	O&M PIPE AND MANHOLE REHABI TIATION REPAIRS
H - O&M (2 OF 2)	O&M PIPE AND MANUELE REHABILITATION REPAIRS
I - O&M (1 OF 2)	O&M PIPE AND MANHOLE REHABILITATION REPAIRS
I - O&M (2 OF 2)	O&M PIPE AND MANHOLE REHABILITATION REPAIRS
J - O&M (1 OF 2)	O&M PIPE AND MANHOLE REHABILITATION REPAIRS
J - O&M (2 OF 2)	O&M PIPE AND MANHOLE REHABILITATION REPAIRS
C 1	SEWER PLANS, PROFILES AND RESTORATION EXTERNAL POINT REPAIR AND RESTORATION. ALLEVANEST OF AND AVE. RETAILED TAYLOR ST. AND HAZELMOOD ST.
S-1	EXTERNAL POINT REPAIR AND RESTORATION - ALLEY WEST OF 3RD AVE. BETWEEN TAYLOR ST. AND HAZELWOOD ST.
S-2	EXTERNAL POINT REPAIR AND RESTORATION - N. JOHN C. LODGE SERVICE DR. BETWEEN PHILADELPHIA ST. AND EUCLID ST.
S-3	EXTERNAL POINT REPAIR AND RESTORATION - ALLEY SOUTH OF SEWARD AVE. BETWEEN 2ND AVE. AND WOODWARD AVE.
S-4	EXTERNAL POINT REPAIR AND RESTORATION - ALLEY NORTHEAST OF W. PHILADELPHIA ST. AND JOHN C. LODGE SERVICE DRIVE
S-5 S-6	EXTERNAL POINT REPAIR AND RESTORATION - ALLEY EAST OF 3RD AVE. BETWEEN TAYLOR ST. AND HAZELWOOD ST.
	EXTERNAL POINT REPAIR AND RESTORATION - ALLEY SOUTH OF VIRGINIA PARK ST. BETWEEN 3RD AVE. AND JOHN C. LODGE SERVICE DR. EXTERNAL POINT REPAIR AND RESTORATION - ALLEY WEST OF 3RD AVE. BETWEEN PALLISTER AVE. AND W. BETHUNE AVE.
S-7 S-8	EXTERNAL POINT REPAIR AND RESTORATION - ALLEY WEST OF 3RD AVE. BETWEEN PALLISTER AVE. AND W. BETHUNE AVE. EXTERNAL POINT REPAIR AND RESTORATION - SEWARD ST. AND NORTHBOUND JOHN C. LODGE SERVICE DRIVE.
S-8 S-9	EXTERNAL POINT REPAIR AND RESTORATION - SEWARD ST. AND NORTHBOUND JOHN C. LODGE SERVICE DRIVE. EXTERNAL POINT REPAIR AND RESTORATION - ALLEY WEST OF WOODWARD AVE. BETWEEN DELAWARE ST. AND PALLISTER ST.
S-9 S-10	EXTERNAL POINT REPAIR AND RESTORATION - ALLEY WEST OF WOODWARD AVE. BETWEEN DELAWARE ST. AND PALLISTER ST.
S-10 S-11	EXTERNAL POINT REPAIR AND RESTORATION - ALLEY WEST OF 3RD AVE BETWEEN DELAWARE ST. AND SEWARD AVE. EXTERNAL POINT REPAIR AND RESTORATION - SOUTHBOUND I-75 SERVICE DR. BETWEEN MACK AVE. AND WILKINS ST.
S-11 S-12	EXTERNAL POINT REPAIR AND RESTORATION - SOUTHBOUND 1-75 SERVICE DR. BETWEEN MACK AVE. AND WILKINS ST.
S-12 S-13	EXTERNAL POINT REPAIR AND RESTORATION - BEAUBIEN ST. BETWEEN MACK AVE. AND ELIOT ST. EXTERNAL POINT REPAIR AND RESTORATION - ALLEY WEST OF 3RD AVE. BETWEEN LOTHROP ST. AND W. GRAND BLVD.
S-14	EXTERNAL POINT REPAIR AND RESTORATION - ALLEY WEST OF SRD AVE. BETWEEN LOTHROP ST. AND W. GRAND BLVD. EXTERNAL POINT REPAIR AND RESTORATION - ALLEY EAST OF JOHN C. LODGE SERVICE DR. BETWEEN BLAINE ST. AND PINGREE ST.
→	DETAILS
TP-1	TRAFFIC PLAN - TYPICAL TRAFFIC CONTROL DETAILS
TP-2	TRAFFIC PLAN - TYPICAL TRAFFIC CONTROL DETAILS
TP-3	TRAFFIC PLAN - MAINTENANCE OF TRAFFIC INFORMATION
SD-1	STANDARD DETAILS SEWER
SD-1 SD-2	STANDARD DETAILS SEWER STANDARD DETAILS SEWER
SD-2 SD-3	STANDARD DETAILS SEWER STANDARD DETAILS SEWER
SD-4	STANDARD DETAILS SOIL EROSION AND SEDIMENTATION CONTROL
SD-5	STANDARD DETAILS SOIL EROSION AND SEDIMENTATION CONTROL STANDARD DETAILS SOIL EROSION AND SEDIMENTATION CONTROL
SD-6	STANDARD DETAILS SOIL EROSION AND SEDIMENTATION CONTROL STANDARD DETAILS RESTORATION
SD-6 SD-7	STANDARD DETAILS RESTORATION STANDARD DETAILS RESTORATION
SD-7 SD-8	STANDARD DETAILS RESTORATION STANDARD DETAILS RESTORATION
SD-8 SD-9	STANDARD DETAILS RESTORATION STANDARD DETAILS RESTORATION
- <i>-</i> -	
SD-10	RESTORATION TREE PLANTING SCHEDULE AND DETAILS

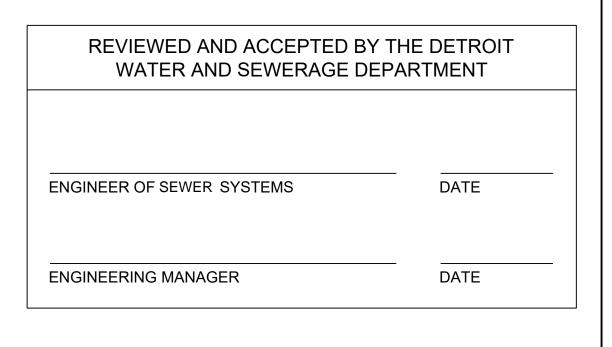





F E D	DESIGNED BY: DRAWN BY:	SEAL / STAMP	DETROIT WATER AND SEWERAGE DEPARTMENT CAPITAL IMPROVEMENT PROGRAM	CITY OF	CITY O WATER AND SEW	F DETROIT ERAGE DE		MDEQ SRF Project No. REF. No. DWSD CONTRACT No.	CS-1812
B A ISSUED FOR PROCUREMENT	- 4/1/2020 MANAGER:		INDEX	DETROIT Water & Sewerage Department		RING DIVISION		FILE No. DRAWING No.	DWS-916 -
DESCRIPTIONS / REVISIONS				SECTION MAP S	TOWN RANGE	SECTION	PORTION CODE		G-1

	Item	Unit	Total
1	Mobilization/Demobilization	LS	1
2	Material Testing	LS	1
3	Traffic Control	LS	1
5	Pre-Construction Site Documentation Project Sign	LS EA	1 4
6	Closeout	LS	1
7	Sidewalk, Rem	SYD	29
8	Sidewalk, Conc, 6 inch	SYD	144
9	Curb and Gutter, Rem	LFT	42
10	Curb and Gutter, Conc	LFT	142
11	Aggregate Base, No. 22A, 6 inch	SYD	547
12	Concrete Base, 8 inch	SYD SYD	431 914
13	HMA Pavement, Rem, Milling, Greater than 2 inch Depth up to 4 inch Depth HMA Pavement, 36A, 1.5 inch	SYD	1,349
15	HMA Pavement, 13A, 2 inch	SYD	1,349
16	Concrete Paving, 9 inch	SYD	319
17	Structure, Adjust Existing Casting to Grade	EA	12
18	Mulched Seeding	SYD	158
19	Guardrail, Remove and Replace	LFT	50
20	Sewer Video Inspection, Less than 18 inch Height	LFT	9,953
21	Sewer Video Inspection, 18 inch to 34 inch Height Sewer Video Inspection, 36 inch to 57 inch Height	LFT LFT	4,515 1,449
23	Taps, Cutting and Grinding	EA	20
24	Flowable Fill	CYD	10
25	Sewer, Clean, Less than 18 inch Height	LFT	8,522
26	Sewer, Clean, 18 inch to 34 inch Height	LFT	2,295
27	Sewer, Clean, 36 inch to 57 inch Height	LFT	6,566
28	Sewer, Clean, 60 inch to 90 inch Height	LFT · ==	1,153
29	Sewer, Trenchless Point Repair, 10 inch	LFT	9
30 31	Sewer, Trenchless Point Repair, 12 inch Sewer, Trenchless Point Repair, 15 inch	LFT LFT	26 13
32	Sewer, Trenchless Point Repair, 18 inch	LFT	11
33	Sewer, Trenchless Point Repair, 21 inch	LFT	3
34	Sewer, Trenchless Point Repair, 42 inch	LFT	5
35	Sewer, Trenchless Point Repair, 48 inch	LFT	16
36	Sewer, Trenchless Point Repair, 51 inch	LFT	8
37	Sewer, Trenchless Point Repair, 60 inch	LFT	5
38 39	Sewer, Trenchless Point Repair, 66 inch Sewer, Trenchless Point Repair, 75 inch	LFT LFT	3
40	Sewer, Trenchless Point Repair, 75 mch	LFT	5
41	Sewer, Trenchless Point Repair, Egg Shaped, 28 inch x 42 inch	LFT	5
42	Sewer, Trenchless Point Repair, Egg Shaped, 36 inch x 42 inch	LFT	3
43	Sewer, Trenchless Point Repair, Lateral Tee Liner, 10 inch Mainline	EA	1
44	Sewer, Trenchless Point Repair, Lateral Tee Liner, 15 inch Mainline	EA	4
45	Sewer, Trenchless Point Repair, Lateral Tee Liner, 18 inch Mainline	EA	1
46 47	Sewer, Trenchless Point Repair, Pointing Sewer, Lining, CIPP, 10 inch	LFT LFT	33 1,626
48	Sewer, Lining, CIPP, 12 inch	LFT	6,375
49	Sewer, Lining, CIPP, 15 inch	LFT	10,123
50	Sewer, Lining, CIPP, 18 inch	LFT	8,812
51	Sewer, Lining, CIPP, 21 inch	LFT	1,484
52	Sewer, Lining, CIPP, 24 inch	LFT	244
53	Sewer, Lining, CIPP, 36 inch	LFT	30
54 55	Sewer, Lining, CIPP, Egg Shaped, 12 inch x 20 inch Sewer, Lining, CIPP, Egg Shaped, 12 inch x 24 inch	LFT LFT	134 95
56	Sewer, Lining, CIPP, Egg Shaped, 15 inch x 20 inch	LFT	1,504
57	Sewer, Lining, CIPP, Egg Shaped, 36 inch x 48 inch	LFT	122
58	Sewer, Lining, Reinstatement of Active Taps	EA	945
59	Sewer, Lining, Cutting of CIPP Lined Tee	EA	7
60	Sewer, External Point Repair, 12 inch	LFT	58
61 62	Sewer, External Point Repair, 15 inch Sewer, External Point Repair, 18 inch	LFT LFT	50 5
63	Sewer, External Point Repair, 48 inch	LFT	5
64	Sewer, Lateral Reconnection	EA	7
65	Manhole, New, 4 foot, 0' to 10' Depth	EA	15
66	Manhole, New, 4 foot, Greater than 10' to 20' Depth	EA	8
67	Manhole, New, Over Existing Sewer, 10 foot, Greater than 20' to 25' Depth	EA	1
68	Manhole, Clean	EA	30
69 70	Manhole, Bench and Channel Reconstruction Manhole, Cover	EA EA	<u>3</u> 5
70	Manhole, Cover Manhole, Frame	EA EA	5
72	Manhole, Spot Repairs	EA	36
73	Manhole, Replace Chimney	EA	4
74	Manhole, Lining	EA	3
75	Catch Basin, Clean	EA	10
76	Catch Basin, New	EA	8
77 78	Contaminated Material Allowance Provisional Allowance	ALLOW ALLOW	1 1
/6	i romotonal Allowanice	ALLOW	1



F DESIGNED BY: SEAL / STAMP E DRAWN BY:	DETROIT WATER AND SEWERAGE DEPARTMENT CAPITAL IMPROVEMENT PROGRAM	CITY OF DETROIT WATER AND SEWERAGE DEPARTMENT MDEQ SRF REF. No. DWSD CON DWSD CON	CS-1812
C CHECKED BY: A ISSUED FOR 100% DESIGN - - 10/31/19	SCHEDULE OF QUANTITIES	ENGINEERING DIVISION FILE No. DETROIT Water & Sewerage Department DRAWING N	DVVS-916 -
DESCRIPTIONS / REVISIONS CHK'D APPR. DATE	SEWER AND RESTORATION	SECTION MAP TOWN RANGE SECTION PORTION CODE	G-2

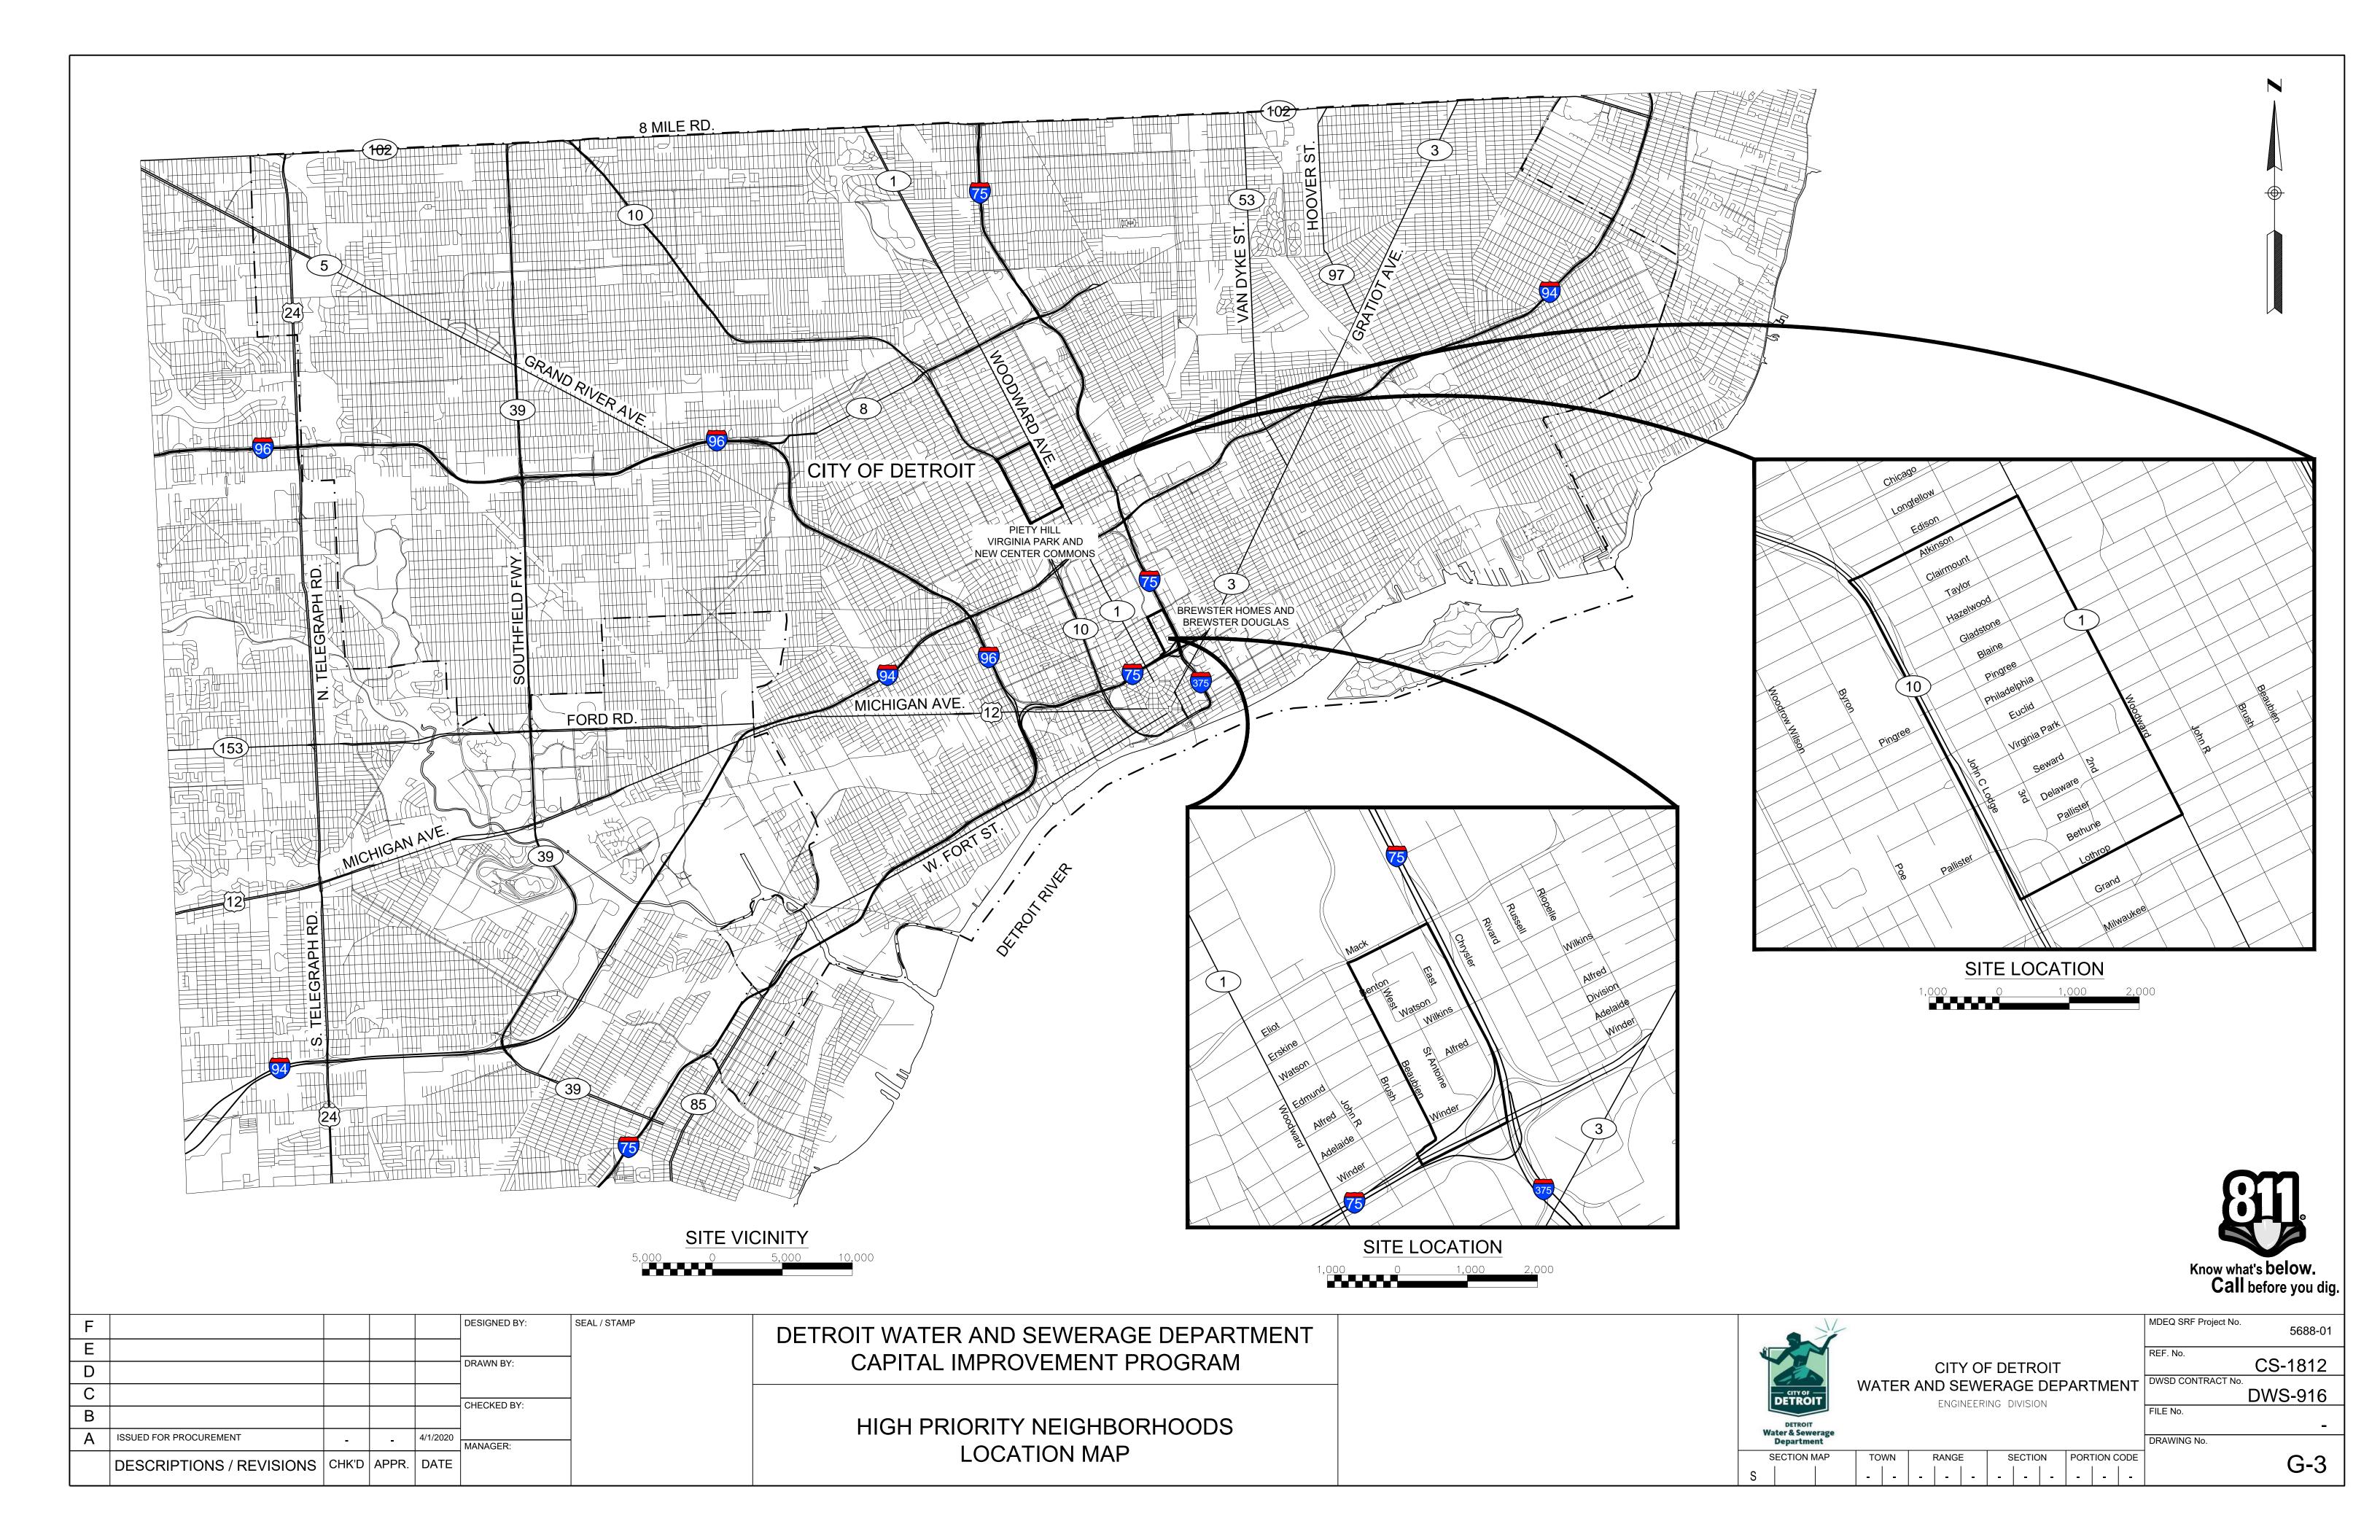

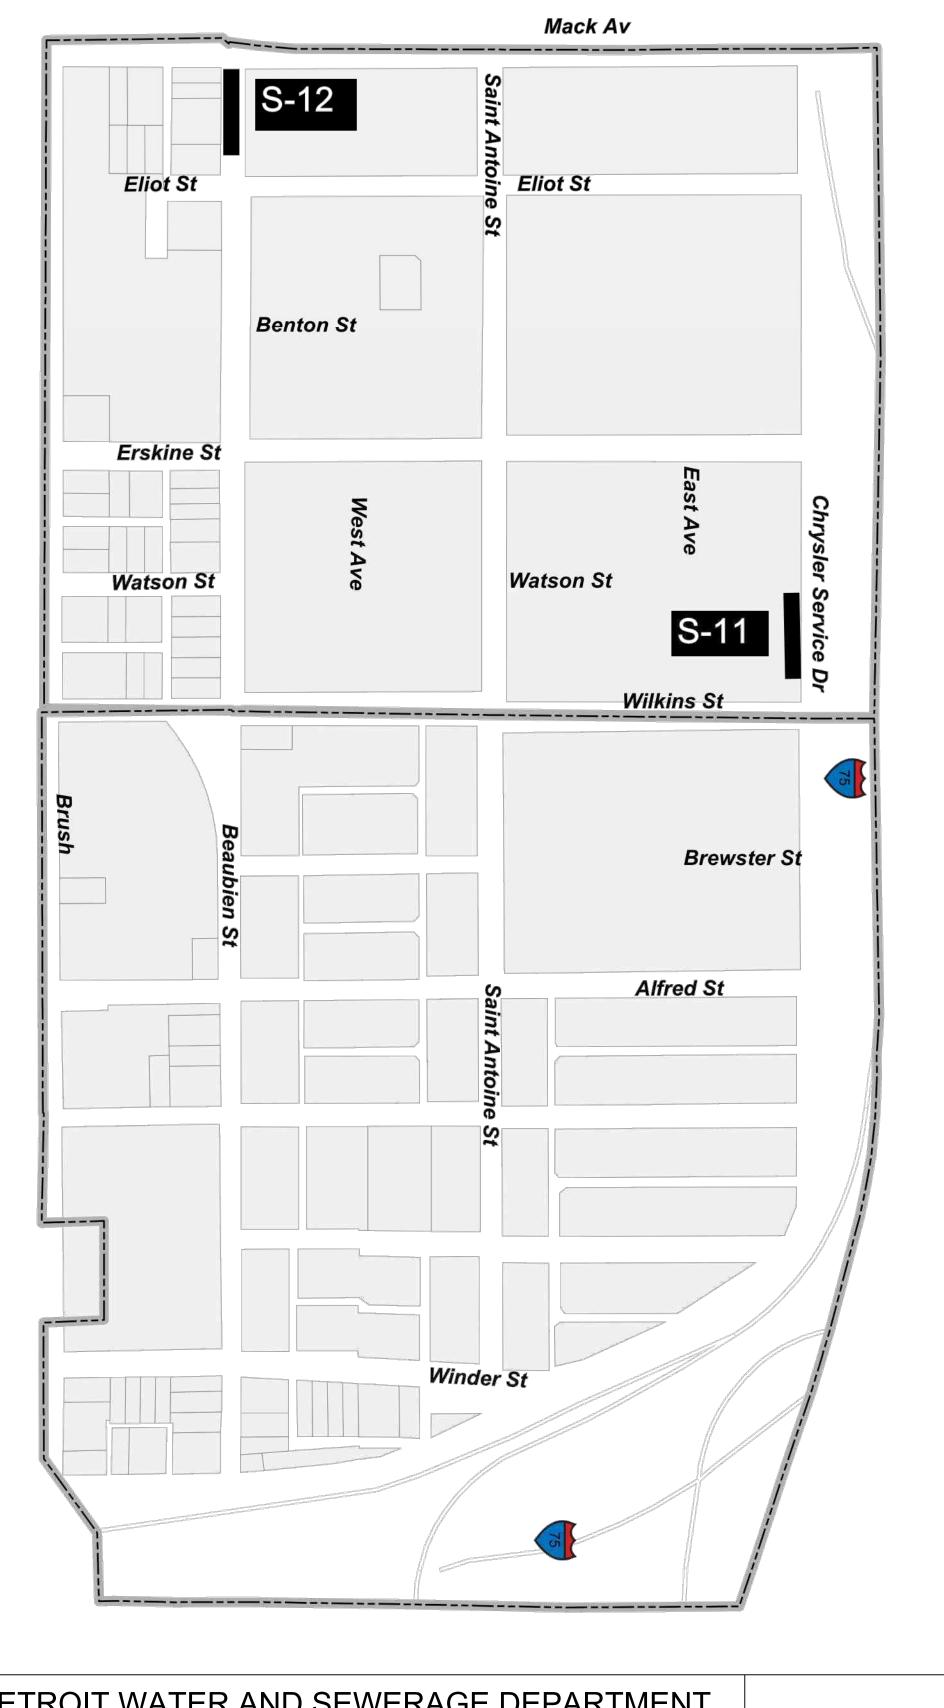

Brewster Homes

Brewster Douglass

F					DESIGNED BY:	SEAL / STAMP
E						
D					DRAWN BY:	
С					CHECKED BY:	
В					CHECKED BY:	
Α	ISSUED FOR PROCUREMENT	-	-	4/1/2020	MANAGER:	
	DESCRIPTIONS / REVISIONS	CHK'D	APPR.	DATE		

DETROIT WATER AND SEWERAGE DEPARTMENT CAPITAL IMPROVEMENT PROGRAM


BREWSTER HOMES AND BREWSTER DOUGLASS
SEWER INTERVENTIONS MAP
SHEET 1 OF 2

CITY OF DETROIT Water & Sewerage	WATER	R AND SEWE	F DETROIT ERAGE DEF ING DIVISION	PARTMENT	MDEQ SRF Project No. REF. No. DWSD CONTRACT No. FILE No.
Department					DRAWING No.
SECTION MAP	TOWN	RANGE	SECTION	PORTION CODE	
S					

CS-1812

DWS-916


G-4

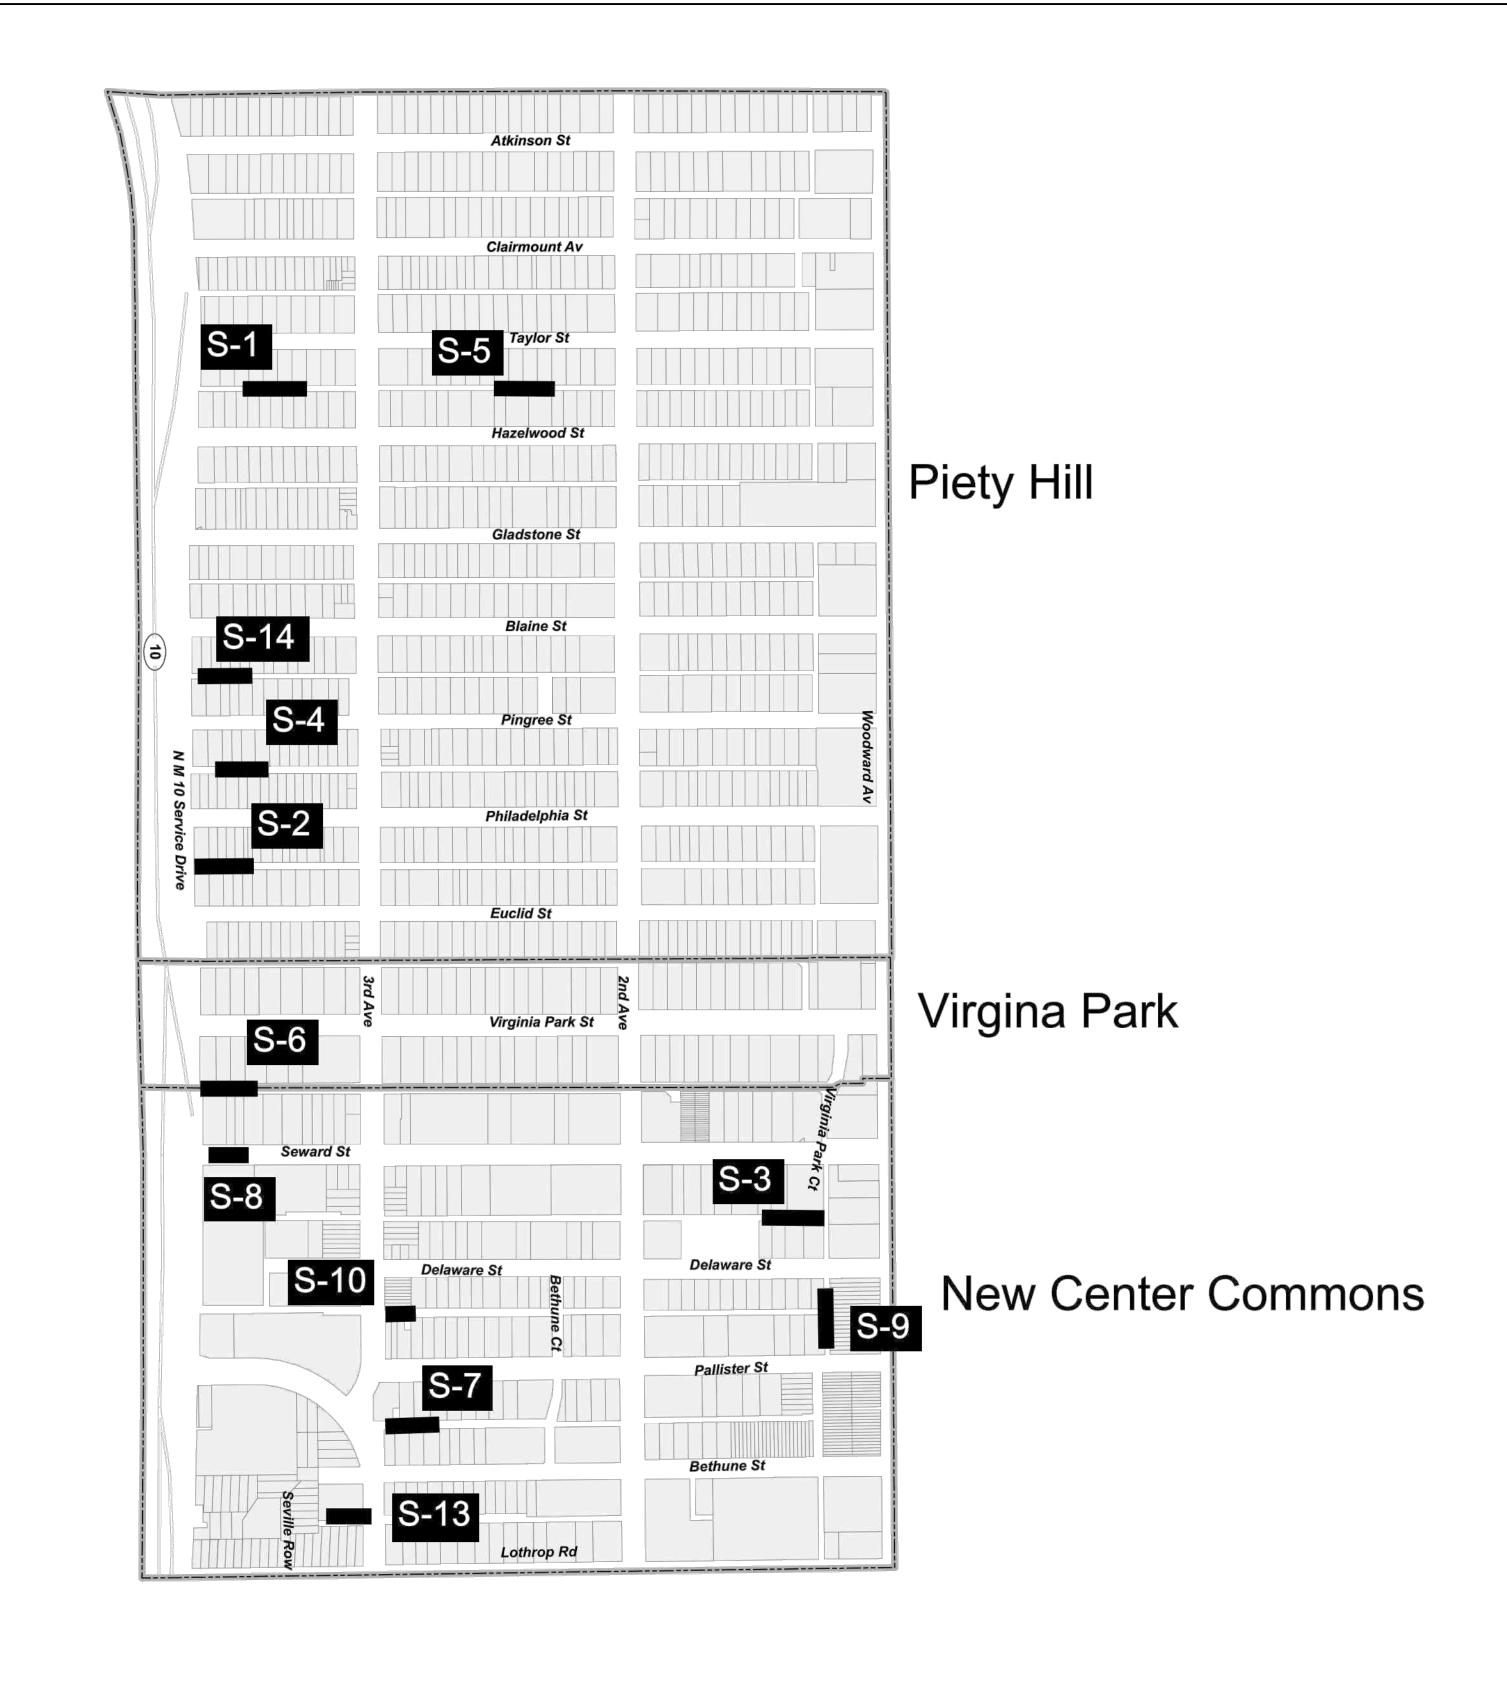

F	F					DESIGNED BY:	SEAL / STAMP
E							
)					DRAWN BY:	
	<u> </u>					CHECKED BY:	
E	3					CHECKED BY.	
	4	ISSUED FOR PROCUREMENT	_	-	4/1/2020	MANAGER:	
		DESCRIPTIONS / REVISIONS	CHK'D	APPR.	DATE		

DETROIT WATER AND SEWERAGE DEPARTMENT CAPITAL IMPROVEMENT PROGRAM

PIETY HILL, VIRGINIA PARK, AND NEW CENTER SEWER INTERVENTIONS MAP SHEET 2 OF 2

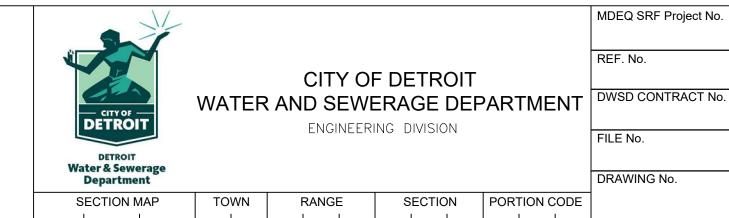

CS-1812

DWS-916

G-5

GENERAL NOTES

- 1. UNDERGROUND STRUCTURES AND UTILITIES SHOWN ARE TAKEN FROM SURVEY AND INFORMATION GATHERED FROM THE MAJOR SERVICE COMPANIES. NO GUARANTEE IS MADE AS TO ACCURACY OR COMPLETENESS.
- 2. BIDDER SHALL VERIFY TYPES AND LOCATIONS OF PAVEMENTS AND CURBS OF THEIR INTERFERENCE WITH THE SEWER REPLACEMENT AND/OR INSTALLATION AND SHALL INCLUDE COST OF CROSSING AND RESTORATION USING THE RELEVANT UNIT PRICE ITEMS.
- 3. ALL SIDEWALKS, DRIVEWAYS, SERVICE WALKS, CURBS, UTILITY POLES, TRAFFIC SIGNAL POLES, LIGHT POLES, TREES, LAWNS ETC., MAY NOT BE SHOWN ON THESE DRAWINGS. THE BIDDER SHALL VISIT THE PROJECT SITE AND MAKE THEIR OWN DETERMINATION OF THE SITUATION AND INCLUDE ALL WORK AND RESTORATION INVOLVING THESE IMPROVEMENTS USING THE RELEVANT UNIT PRICE ITEMS.
- 4. LOCATIONS OF THE D.W.S.D. SEWERS AS SHOWN ON THE DRAWINGS ARE APPROXIMATE ONLY. EXACT LOCATION AND DEPTH SHALL BE VERIFIED IN THE FIELD BY THE CONTRACTOR.
- 5. SEWER CONSTRUCTION OR REPLACEMENT IN CLOSE PROXIMITY TO UTILITY POLES, CATCH BASINS, TREES, ETC., MAY REQUIRE TUNNELING AND/OR THE USE OF CARRIER PIPES. THE SUPPORT OF THESE STRUCTURES SHALL BE CONSIDERED INCIDENTAL TO THE CONTRACT WORK AND THEREFORE INCLUDED IN THE UNIT PRICE OF THE PIPE INSTALLATION.
- 6. DAMAGE TO EXISTING MANHOLES OCCURRING DURING SEWER INSTALLATION SHALL BE REPAIRED BY THE CONTRACTOR, AS DIRECTED BY THE ENGINEER, AT NO ADDITIONAL COST TO D.W.S.D. REPAIRING OF THE MANHOLE SHALL INCLUDE. BUT NOT BE LIMITED TO, BRICK REPLACEMENT, REMORTARING JOINTS AND ADJUSTING THE FRAMES AND COVERS TO GRADE. WORN FRAMES AND COVERS LOCATED IN THE PAVEMENT SHALL BE EXCHANGED FOR NEW FRAMES AND COVERS PER THE STANDARD DETAILS. REMOVAL AND REPLACEMENT OF FRAMES AND COVERS WILL BE REQUIRED AS DIRECTED BY THE ENGINEER. FRAMES AND COVERS SHALL BE SALVAGED AND RETURNED TO D.W.S.D. AT NO COST TO THE CONTRACTOR.
- 7. IN COMPLIANCE WITH MICHIGAN PUBLIC ACT 53 OF THE ACTS OF 1974, THE CONTRACTOR SHALL NOTIFY, 3 WORKING DAYS (72 HOURS) IN ADVANCE OF CONSTRUCTION, ALL PUBLIC AND PRIVATE OWNERS HAVING EXISTING FACILITIES IN OR NEAR THE IMMEDIATE WORKING AREA. THE CONTRACTOR SHALL BE RESPONSIBLE FOR VERIFYING UTILITY LOCATIONS AND NOTIFYING MISS DIG (PHONE 1-800-482-7171).
- 8. ALL SIDEWALK AND SIDEWALK RAMP REPLACEMENT, IN THE CITY OF DETROIT RIGHT-OF-WAY, SHALL BE ADA COMPLIANT. IN ADDITION, THE SIDEWALK CROSS SLOPE SHALL NOT BE GREATER THAN 2% AND SHALL BE SLOPED TO ASSURE DRAINAGE TO THE STREET (TRY TO MAINTAIN A MINIMUM 1% SLOPE IN THE DIRECTION OF FLOW).
- 9. THE BIDDER'S ATTENTION IS DIRECTED TO THE SPECIFICATIONS AND STANDARD DETAILS FOR THE REQUIREMENTS OF THE CITY ENGINEERING DIVISION OF THE DEPARTMENT OF PUBLIC WORKS (D.P.W.), CITY OF DETROIT.
- 10. IF PARKING RESTRICTIONS ADJACENT TO THE CONTRACTOR'S WORK ZONE DO NOT ALLOW OVERNIGHT PARKING OR RESTRICT DAYTIME PARKING, THE CONTRACTOR SHALL PROVIDE ACCESS TO PRIVATE PROPERTIES DURING CONSTRUCTION. THIS INCLUDES, BUT IS NOT LIMITED TO, PROVIDING A TEMPORARY RAMP TO CROSS ANY TEMPORARY WATER PIPES OR EXCAVATIONS THAT MAY LIMIT ACCESS TO DRIVEWAYS.
- 11. THE CONTRACTOR IS REFERRED TO THE DETAILED SPECIFICATIONS REGARDING "SHEETING AND BRACING" REQUIREMENTS. THE CONTRACTOR SHALL PROVIDE SHEETING AND BRACING TO PROTECT ADJACENT PAVEMENT, CURBS SIDEWALKS, PIPELINES, CONDUITS, THE WORK AND PERSONNEL. THE CONTRACTOR SHALL BE TOTALLY RESPONSIBLE FOR ANY AND ALL DAMAGES AND INJURIES RESULTING FROM A FAILURE TO PROVIDE ADEQUATE SHEETING AND BRACING, AT NO ADDITIONAL COST TO D.W.S.D.
- 12. IF A CRANE, BACKHOE OR A BOOM WILL BE USED IN THE VICINITY OF DETROIT EDISON OVERHEAD LINES, THE DETROIT EDISON COMPANY MUST BE NOTIFIED THREE WORKING DAYS PRIOR TO SUCH USE.
- 13. THE CONTRACTOR SHALL NOTIFY D.W.S.D.'S REPRESENTATIVE A MINIMUM OF TWO DAYS (48 HOURS) IN ADVANCE OF THE NEED TO OPEN OR CLOSE ANY VALVES.
- 14. THE CONTRACTOR IS RESPONSIBLE FOR PROTECTING ALL EXISTING SEWERS, DRAINS AND DRAINAGE DITCHES INCLUDING ANY PUBLIC OR PRIVATE UTILITY.

- OVERHEAD OR UNDERGROUND. IF ANY UTILITIES ARE DAMAGED DURING CONSTRUCTION THEY SHALL BE RESTORED BY THE CONTRACTOR AT NO ADDITIONAL COST TO THE CITY, TO THE SATISFACTION OF THE ENGINEER, THE UTILITY OWNER AND THE AUTHORITIES HAVING JURISDICTION.
- STREETS AND ALLEYS (ESPECIALLY AT INTERSECTIONS) WITH RESPECT TO 15. ALL PREVIOUSLY ABANDONED OR LIVE UTILITIES, WATER MAINS, STORM SEWERS, AND COMBINED SEWERS MAY NOT BE SHOWN ON THE DRAWINGS. NO GUARANTEE IS MADE AS TO THEIR ACCURACY OR COMPLETENESS. SHOULD THE CONTRACTOR NEED MORE INFORMATION, A TIMELY REQUEST TO INDIVIDUAL UTILITY COMPANIES FOR THEIR FACILITY INFORMATION AND D.W.S.D. FOR WATER AND SEWER INFORMATION SHOULD BE MADE
 - 16. ALL SEWER CONSTRUCTION SHALL BE PERFORMED WITH MATERIALS AND WORKMANSHIP OF THE HIGHEST QUALITY FOR THE PARTICULAR PURPOSE AND SHALL STRICTLY CONFORM TO THE CURRENT STANDARDS AND SPECIFICATIONS OF THE DETROIT WATER AND SEWERAGE DEPARTMENT
 - 17. THE HORIZONTAL AND VERTICAL LOCATIONS OF EXISTING SEWERS ARE NOT KNOWN. APPROXIMATE ELEVATIONS SHOWN ON THE PROFILES ARE BASED ON AVAILABLE RECORD DRAWINGS FROM THE DETROIT WATER AND SEWERAGE DEPARTMENT AND SURVEY CONDUCTED. ELEVATIONS OF THE PROPOSED SEWERS ARE SUBJECT TO CHANGE TO SUIT ACTUAL ELEVATIONS OF EXISTING SEWERS, WHERE APPLICABLE. CONTRACTOR SHALL VERIFY LOCATIONS AND ELEVATIONS OF EXISTING SEWERS. CONTRACTOR SHALL SUBMIT SHOP DRAWINGS SHOWING PROPOSED SEWERS CONNECTION LOCATIONS AND ELEVATIONS (IF ANY) FOR ENGINEERS REVIEW AND APPROVAL PRIOR TO START OF WORK.
 - 18. A MINIMUM CLEARANCE OF 18 INCHES VERTICALLY AND 3 FEET HORIZONTALLY SHALL BE MAINTAINED BETWEEN THE OUTSIDE SURFACE OF SEWERS AND OTHER UTILITIES, UNLESS OTHERWISE APPROVED BY THE ENGINEER AND D.W.S.D. IF A CONFLICT EXISTS BETWEEN THE SEWERS AND ANY OTHER UTILITY, THAT UTILITY AND ENGINEER SHOULD BE CONSULTED IMMEDIATELY THE MINIMUM HORIZONTAL DISTANCE BETWEEN WATER MAIN AND SEWER SHALL BE 10 FEET UNLESS OTHERWISE APPROVED BY THE ENGINEER.
 - 19. ELEVATION DATUM IS CITY OF DETROIT DATUM. COORDINATE SYSTEM, IF SHOWN, IS CITY OF DETROIT HORIZONTAL SYSTEM.
 - 20. THE CONTRACTOR SHALL BE RESPONSIBLE FOR AVOIDANCE AND CLEANUP OF STREET SPILLAGE OF EXCAVATED OR BACKFILL MATERIALS ENTERING OR LEAVING THE SITE. CLEANUP OF MAJOR SPILLS SHALL BE COMPLETED IMMEDIATELY. OTHER SPILLS SHALL BE CLEANED, CONTINUALLY. ALL CLEANUP SHALL BE COMPLETED TO THE FULL SATISFACTION OF THE CITY OF DETROIT AUTHORITIES.
 - 21. THE CONTRACTOR SHALL BE RESPONSIBLE FOR AVOIDANCE AND CLEANUP OF MUD TRACKED ONTO ADJACENT CITY, COUNTY AND STATE STREETS FROM VEHICLES LEAVING THE JOB SITE. CLEANUP SHALL BE COMPLETED DAILY AND TO THE FULL SATISFACTION OF THE CITY OF DETROIT, COUNTY AND STATE AUTHORITIES.
 - 22. THE CONTRACTOR SHALL USE ALL MEANS NECESSARY TO PROPERLY MOISTEN AND CREATING A NUISANCE TO NEIGHBORING FACILITIES, THE PUBLIC, AND ANY CONCURRENT WORK ACTIVITIES. THE FINAL DETERMINATION OF THE SUCCESS OF THESE DUST CONTROL MEASURES SHALL BE BY THE CITY OF DETROIT AUTHORITIES.
 - 23. ANY SITE DEWATERING NECESSARY TO MAINTAIN A SAFE AND EFFICIENT ENVIRONMENT SHALL BE THE RESPONSIBILITY OF THE CONTRACTOR.
 - 24. ALL EXCAVATED MATERIALS SHALL BE REMOVED FROM THE SITE AND PROPERLY AND LEGALLY DISPOSED OF AT AN OFF SITE LOCATION. NO EXCAVATED MATERIALS SHALL BE UTILIZED FOR ANY ON-SITE FILL REQUIREMENTS.
 - 25. THE CONTRACTOR SHALL TELEVISE ALL EXISTING SEWER MANHOLES, CATCHBASINS AND CATCHBASIN LEADS IN THE WORK AREA TO DETERMINE AND RECORD ALL CONNECTIONS TO THESE SEWERS.
 - 26. THE CONTRACTOR SHALL NOT ABANDON ANY EXISTING SEWER CONNECTION UNLESS SO DIRECTED BY THE ENGINEER. THE CONTRACTOR SHALL RECONNECT ALL EXISTING SEWERS, EXISTING HOUSE LEADS AND ANY OTHER EXISTING DRAINAGE CONNECTIONS, THAT ARE NOT TO BE ABANDONED, TO THE NEW SEWERS AS DIRECTED BY THE ENGINEER.
 - 27. THE CONTRACTOR SHALL NOTIFY ALL UTILITY OWNERS HAVING EXISTING FACILITIES IN OR NEAR THE IMMEDIATE WORKING AREA. THIS DOES NOT RELIEVE THE CONTRACTOR OF THE RESPONSIBILITY OF VERIFYING THE LOCATIONS AND NOTIFYING ALL UTILITY OWNERS AND MISS DIG.

- 28. THE CONTRACTOR SHALL VIDEOTAPE ALL STREETS PRIOR TO CONSTRUCTION PER THE CONTRACT DOCUMENTS.
- 29. THE CONTRACTOR SHALL BE SOLELY RESPONSIBLE FOR ALL COSTS ASSOCIATED WITH THE PROTECTION OF EXISTING UTILITIES DURING CONSTRUCTION ACTIVITIES.
- 30. TRAFFIC CONTROL MUST CONFORM TO ALL APPLICABLE CITY, COUNTY AND STATE REGULATIONS AND GUIDELINES.
- 31. CURB OR CURB AND GUTTER CALLED OUT TO BE INSTALLED SHALL BE PLACED PER THE CITY OF DETROIT'S STANDARD DETAIL INCLUDED IN THESE PLANS.
- 32. FOR RESTORATION ITEMS, MATERIALS AND WORKMANSHIP SHALL BE IN ACCORDANCE WITH THE CITY OF DETROIT DEPARTMENT OF PUBLIC WORKS ENGINEERING DIVISION STANDARD SPECIFICATIONS FOR PAVING AND RELATED CONSTRUCTION AND THE MICHIGAN DEPARTMENT OF TRANSPORTATION 2012 STANDARD SPECIFICATIONS FOR CONSTRUCTION EXCEPT WHERE OTHERWISE INDICATED ON THESE PLANS AND SPECIFICATIONS.
- 33. THE CONTRACTOR IS TO COMPLETE ALL SURFACE RESTORATION PRIOR TO SUBSTANTIAL COMPLETION. IF TEMPORARY RESTORATION CONDITIONS EXIST THROUGH THE WINTER, OR LONGER THAN 6 WEEKS, COLD PATCH/TEMPORARY PAVEMENTS ARE PERMITTED AS DIRECTED BY THE ENGINEER.

ABBREVIATIONS

ASPHALT PAVEMENT ASBESTOS CEMENT

DETROIT WATER AND SEWERAGE DEPARTMENT

EX. **EXISTING** FINISH GROUND **HORIZONTAL**

HYD. **HYDRANT INVERT ELEVATION**

RIGHT OF WAY STM

UNKNOWN MATERIAL - DEAD UN-DEAD

VERTICAL WATERMAIN WTR. WATER



MDEQ SRF Project No. DESIGNED BY: SEAL / STAMP 5688-01 DETROIT WATER AND SEWERAGE DEPARTMENT CAPITAL IMPROVEMENT PROGRAM CS-1812 DRAWN BY: CITY OF DETROIT D DWSD CONTRACT No WATER AND SEWERAGE DEPARTMENT DETROIT C DWS-916 ENGINEERING DIVISION CHECKED BY: FILE No. В ABBREVIATIONS AND GENERAL NOTES **Water & Sewerage** ISSUED FOR PROCUREMENT DRAWING No. Department PORTION CODE SECTION MAP SECTION G-6 DESCRIPTIONS / REVISIONS | CHK'D | APPR. | DATE

SOIL EROSION AND SEDIMENTATION CONTROL

- 1. THE CONTRACTOR'S ATTENTION IS DIRECTED TO THE EROSION CONTROL SEDIMENTATION AND CONTAINMENT OF CONSTRUCTION DETAILS SPECIFICATION IN THE CONTRACT DOCUMENTS, WHERE REFERENCE IS MADE TO THE CONTRACTOR'S RESPONSIBILITIES CONCERNING THIS MATTER.
- 2. THE CONTRACTOR SHALL ARRANGE HIS CONSTRUCTION OPERATIONS IN SUCH A MANNER THAT THE CONSTRUCTION AREA WILL NOT BE SUSCEPTIBLE TO SOIL EROSION AND THAT THE CONSTRUCTION OPERATIONS WILL NOT CREATE ANY SILTATION PROBLEMS.
- 3. THE CONTRACTOR SHALL EMPLOY NECESSARY MEANS AND METHODS TO PREVENT EXCAVATED AND LOOSE SOIL MATERIAL FROM BEING COLLECTED ON TIRES OF TRUCKS AND OTHER EQUIPMENT AND BEING DEPOSITED ON STREETS AND ROADS TO AND FROM THE CONSTRUCTION SITE.
- 4. THE CONTRACTOR SHALL CONTROL DUST AT THE CONSTRUCTION SITE AND ON THE PUBLIC STREETS USED AS HAUL ROADS. THE CONTRACTOR SHALL BE FAMILIAR WITH AND FOLLOW THE REGULATIONS OUTLINED BY THE CITY OF DETROIT FUGITIVE DUST ORDINANCE NO. 32-17 CHAPTER 22, ARTICLE 5.
- 5. THE DISTANCE BETWEEN THE POINT OF COMPLETE BACK-FILLING AND THE PIPE LAYING SHALL NOT EXCEED 40 FEET.
- 6. THE CONTRACTOR SHALL EMPLOY POSITIVE MEANS TO PREVENT SOIL AND OTHER DEBRIS FROM ENTERING THE EXISTING STREET DRAINAGE SYSTEM. THE EXISTING CATCH BASIN AND DRAIN SYSTEM IS THE CONTRACTOR'S RESPONSIBILITY TO MAINTAIN TO AT LEAST THE CONDITIONS PRIOR TO CONSTRUCTION.
- 7. IN ADDITION TO THE ABOVE REQUIREMENTS, THE CONTRACTOR'S ATTENTION IS DIRECTED SPECIFICALLY TO DIVISION 14E, "EROSION CONTROL PROGRAM" OF THE CITY ENGINEERING DEPARTMENT'S CURRENT "STANDARD SPECIFICATIONS FOR PAVING AND RELATED CONSTRUCTION."
- 8. THE CONTRACTOR SHALL PERFORM ALL ACTIVITIES NECESSARY TO COMPLY WITH THE TEMPORARY EROSION AND SEDIMENT CONTROL SPECIFICATION AND THE CITY ENGINEERING EROSION CONTROL PROGRAM.
- 9. PERMITTEE AND CONTRACTORS ARE SUBJECT TO: PUBLIC ACT 451 OF 1994, AS AMENDED PART 201. IN THE EVENT OF EXCAVATION ENCOUNTERING ENVIRONMENTAL CONTAMINATION OR AN UNDERGROUND TANK IN MDOT AND/OR OTHER PROJECT RIGHT OF WAY, WORK WITHIN THE RIGHT OF WAY SHALL CEASE UNTIL ALL ACTIONS/NOTIFICATIONS SPECIFIED BY PART 201 HAVE BEEN COMPLETED.
- 10. REFER TO SHEETS SD-3 AND SD-4 FOR SOIL EROSION AND SEDIMENTATION CONTROL DETAILS.
- 11. ALL SOIL EROSION AND SEDIMENTATION CONTROL WORK IS CONSIDERED INCIDENTAL TO THE CONTRACT, WITH THE EXCLUSION OF THE GREEN STORMWATER INFRASTRUCTURE WORK.

C.E.D. NOTES

CITY OF DETROIT, DPW, CITY ENGINEERING DIVISION REQUIREMENTS

- 1. THE CONTRACTOR SHALL OBTAIN A CITY OF DETROIT STREET RIGHT-OF-WAY PERMIT FROM THE INSPECTION PERMIT OFFICE OF THE ENGINEERING DIVISION.
- 2. THE CONTRACTOR SHALL COMPLY WITH ALL THE CITY ENGINEERING DIVISION STREET RIGHT-OF-WAY PERMIT REQUIREMENTS.
- 3. NEW GATE VALVE WELLS, FIRE HYDRANTS AND ANY SURFACE ITEMS SHALL NOT BE LOCATED IN SIDEWALK RAMPS, LANDINGS AND/OR CROSSWALKS.
- 4. ALL NEWLY CONSTRUCTED OR RECONSTRUCTED SIDEWALKS IN THE CITY OF DETROIT'S RIGHT-OF-WAY, SHALL HAVE A MAXIMUM 2% CROSS-SLOPE. IN ADDITION THERE SHALL BE A SUFFICIENT SLOPE ON THE SIDEWALK TO ASSURE DRAINAGE TO THE STREET (TRY TO MAINTAIN AT LEAST A 1% SLOPE IN THE DIRECTION OF FLOW).
- 5. THE CONTRACTOR IS REQUIRED TO MEET D.P.W. ROADWAY PATCHING, SIDE WALK PATCHING AND ADA RAMP DETAILS AND REQUIREMENTS SHOWN ON STANDARD DETAILS.
- 6. THE CONSTRUCTION CONTRACTOR NEEDS TO SUBMIT THE CONSTRUCTION PHASING AND DURATION OF EACH PHASE TO THE OWNER IN ORDER TO MINIMIZE THE IMPACT TO VEHICULAR AND PEDESTRIAN TRAFFIC.
- 7. WHENEVER SIDEWALKS ARE CLOSED, PEDESTRIAN DETOUR SIGNS NEED TO BE POSTED.

PRE CONSTRUCTION MEETING
A PRE-CONSTRUCTION MEETING SHALL
BE REQUIRED PRIOR TO COMMENCING
THE ROAD PAVING ACTIVITY.


TO REPORT AN EMERGENCY FIELD CONDITION CALL: DTE ENERGY ELECTRICAL ..(800) 477-4747 INTERNATIONAL TRANSMISSION CO.....(877) 482-4829 DETROIT PUBLIC LIGHTING AUTHORITY.... (313) 267-7340 DETROIT WATER & SEWERAGE DEPT. (313) 267-7401 DTE ENERGY GAS... ..(800) 947-5000 SBC / AT&T. ..(800) 288-2020 COMCAST CABLE ..(800) 934-6489 DPW TRAFFIC SIGNAL CONDUIT ..(313) 628-5641 / (313) 628-5640 CONSUMERS ENERGY GAS... ..(800) 477-5050


SUNOCO PIPE LINE COMPANY..



F DESIGNED BY: E DRAWN BY:	DETROIT WATER AND SEWERAGE DEPARTMENT CAPITAL IMPROVEMENT PROGRAM	CITY OF DETROIT	EQ SRF Project No. 5688-01 CS-1812
C CHECKED BY: B - 4/1/2020 MANAGER: MANAGER:	SOIL EROSION AND SEDIMENTATION CONTROL	WATER AND SEWERAGE DEPARTMENT ENGINEERING DIVISION FILE DETROIT Water & Sewerage Department DRAN	DWS-916
DESCRIPTIONS / REVISIONS CHK'D APPR. DATE	NOTES AND C.E.D. NOTES	SECTION MAP TOWN RANGE SECTION PORTION CODE S - - G-7

...(313) 292-8850

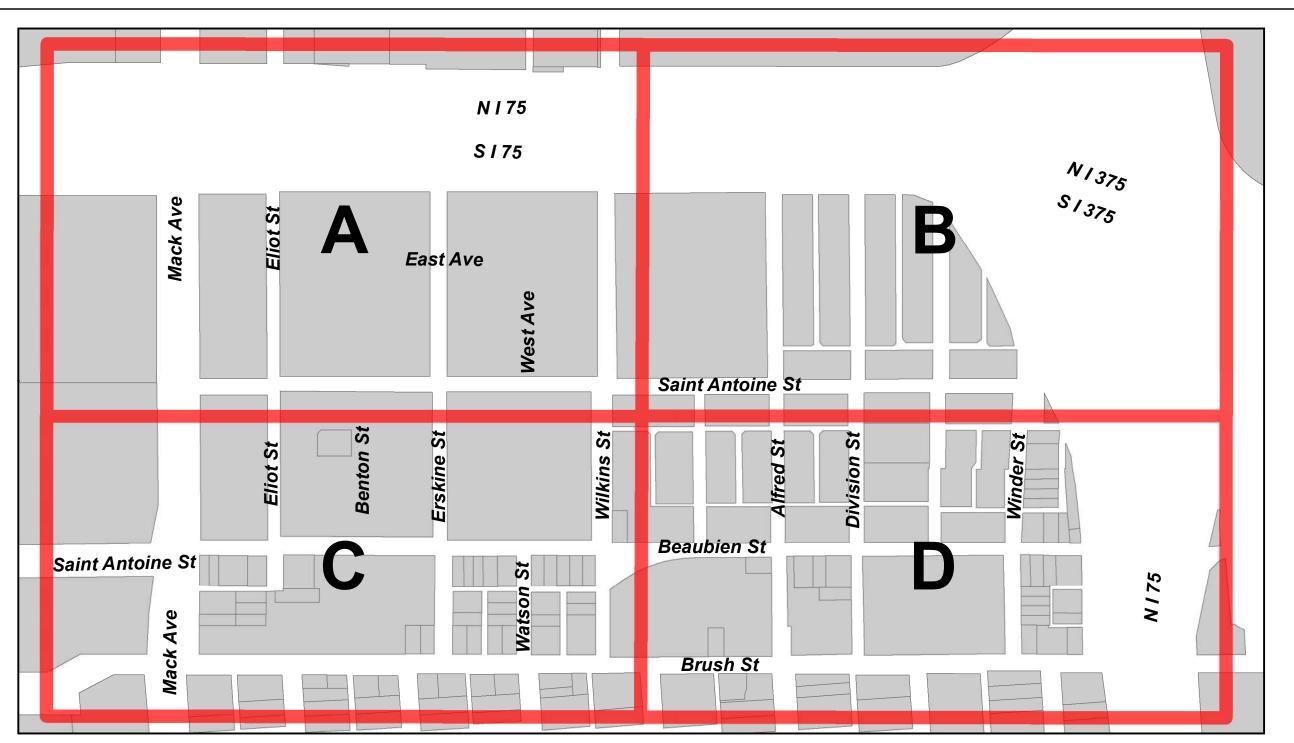

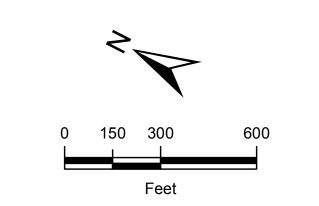




F					DESIGNED BY:	SEAL / STAMP
E						
D					DRAWN BY:	
С					CHECKED BY:	
В					CHECKED BT.	
Α	ISSUED FOR PROCUREMENT	-	-	4/1/2020	MANAGER:	
	DESCRIPTIONS / REVISIONS	CHK'D	APPR.	DATE		
		1	I	I		I .

DETROIT WATER AND SEWERAGE DEPARTMENT CAPITAL IMPROVEMENT PROGRAM

HIGH PRIORITY NEIGHBORHOODS
PIPE AND MANHOLE REHABILITATION REPAIRS

CITYOF DETROIT	WATER A		DETROIT RAGE DEF	PARTMENT	MDEQ SRF Project No. REF. No. DWSD CONTRACT No. FILE No. DRAWING No.	5688-01 CS-1812 DWS-916
SECTION MAP	TOWN	SECTION	RANGE	PORTION CODE	INDEX	C-P&MH

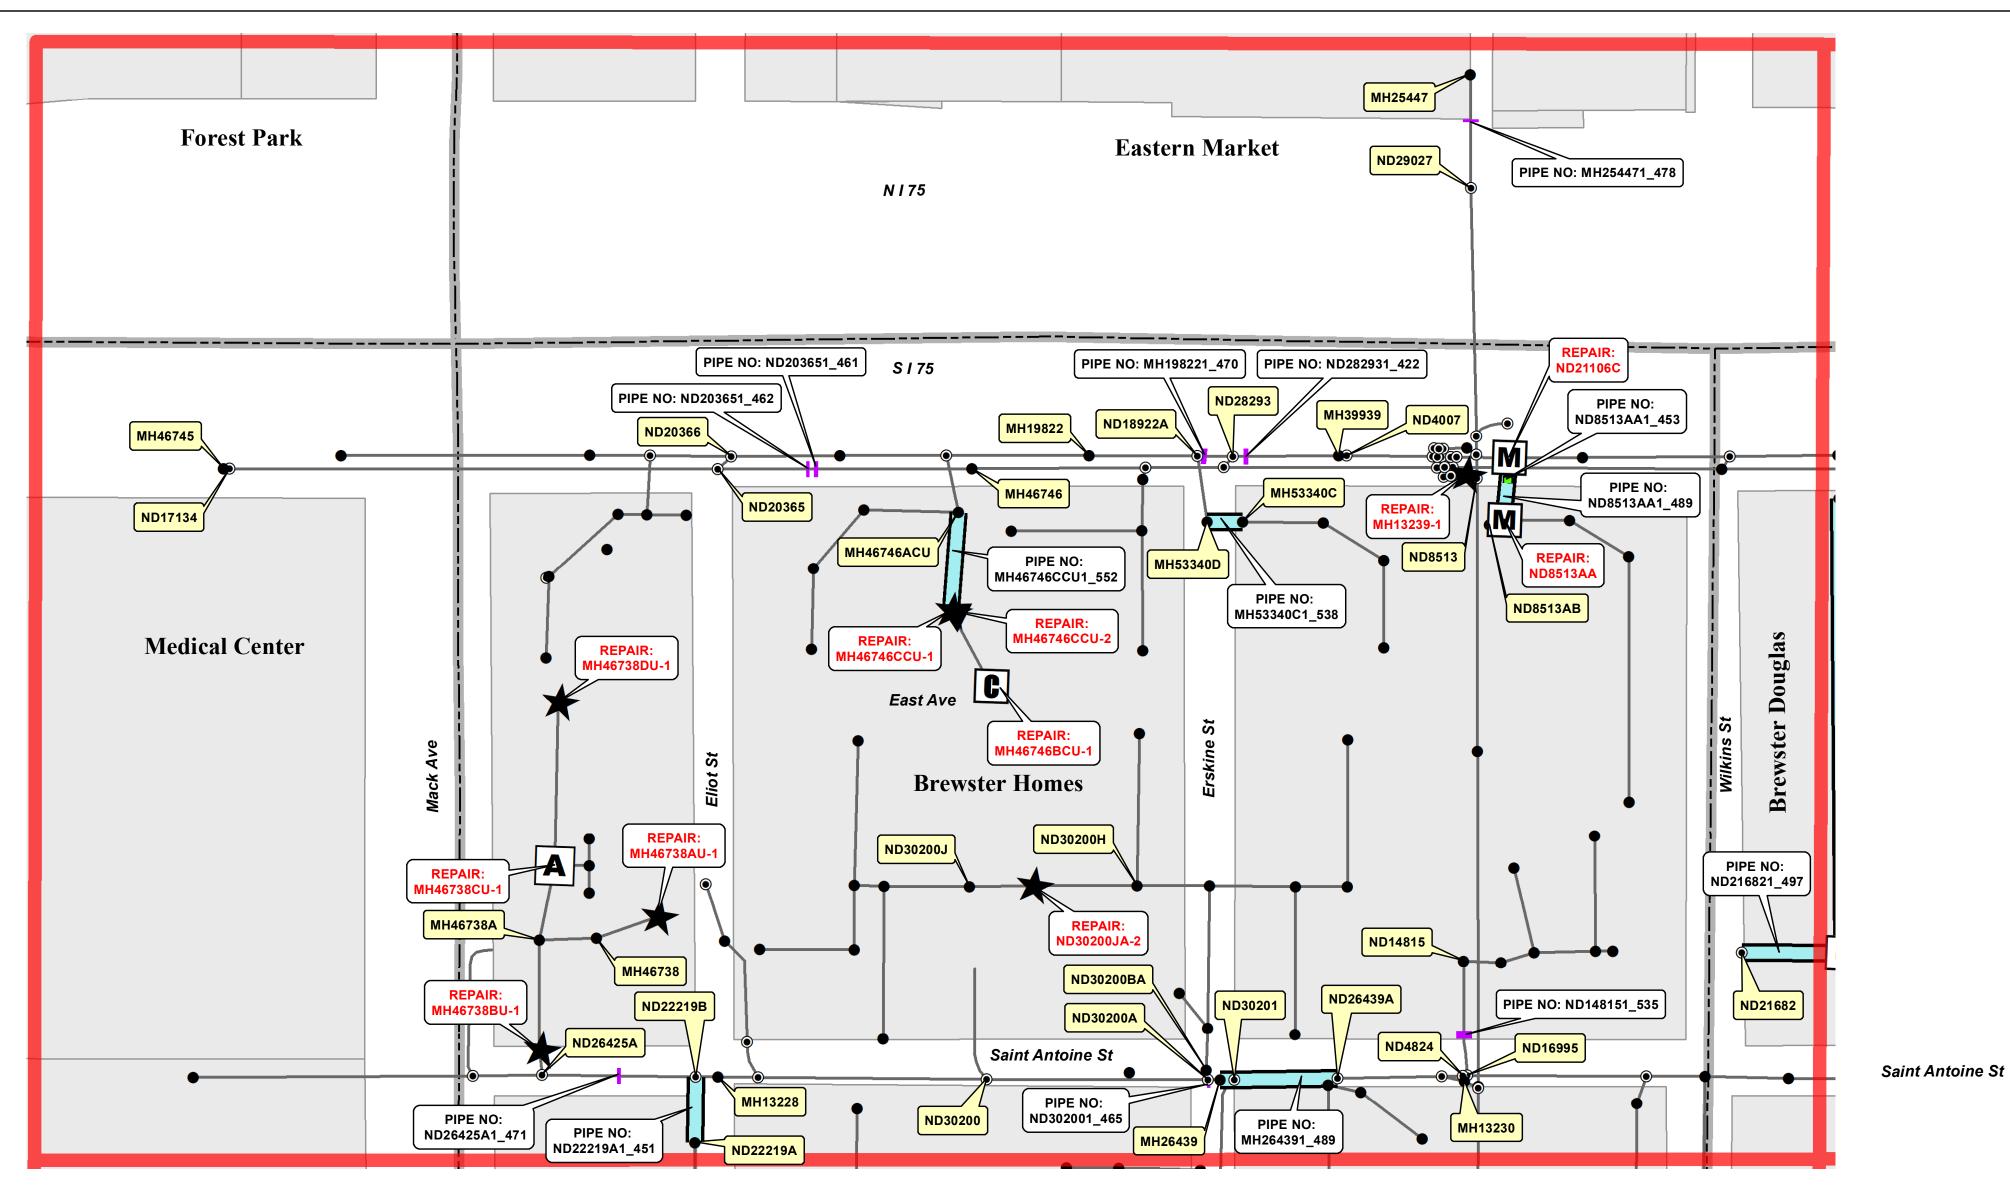

MANHOLE REPAIR TABLE

Manhole ID	Repair Type	Defect Type	Chamber Floor Depth (ft)	MH Diameter (in)	Cone Depth (in)	Chimney Depth (in)	Chimney Repair Depth (in)	Spot Repair Depth (in)
ND8513AA	NEW MANHOLE	BLIND TEE	11.6	48	_	_	_	_
ND21106C	NEW MANHOLE	BLIND TEE	16.47	48	_	_	_	_
ND30200JA-2	MH_GENERAL	WALL	10	24	0	0	4.8	4.8
MH13239-1	MH_GENERAL	CHIMNEY	24	48	59.52	1.06	0	26.4
MH46738AU-1	MH_GENERAL	CHIMNEY	7.4	47	42.96	0.77	0	14.4
MH46738BU-1	MH_GENERAL	CHIMNEY	9.3	51	31.44	1.09	0	14.4
MH46738CU-1	MH_ADJ_REPLACE	ADJUSTERS	8.8	40	40.56	1.09	0	0
MH46738DU-1	MH_GENERAL	CHIMNEY	7.4	47	47.16	1.2	0	14.4
MH46746BCU-1	MH_CHIM_REPLACE	CHIMNEY	8.6	47	59.16	1.55	12	0
MH46746CCU-1	MH_GENERAL	CHIMNEY	8.2	47	28.32	1.1	0	12
MH46746CCU-2	MH_STRUCT	WALL	8.2	47	28.32	1.1	0	33.6

Pipe Rehabilitation Legend

External Point Repair

Lining

Lining with External Point Repair

Trenchless Point Repair

Manhole Rehabilitation Legend

Adjust to Grade

Replace Chimney Only

Frame/Cover Replacement and/or Adjustment

General and/or Spot Repairs

Benching and Channel Re-Construction

M New Manhole

General Legend

Neighborhood Boundary

Parcels


Manhole


Other Structure

Material	Description
BR	Brick
AC	Asbestos Cement
CROCK	Clay Pipe
CP	Concrete Pipe
CT	Clay Tile
NA*	See General Note #3
PCP	Pre-stressed Concrete Cylinder Pipe
PVC	Polyvinyl Chloride
RCP	Reinforced Concrete Pipe
VCP	Vitrified Clay Pipe

General Notes:

- 1. All lengths are shown in feet except as noted.
- 2. NA Data Not Available.
- 3. NA* Upon review of CCTV video, pipe appears to be lined.
- 4. Print Sheet in color.

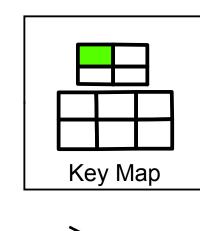

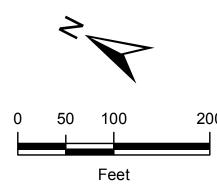

5688-01

F				DESIGNED BY: SEAL / STAMP	DETROIT WATER AND SEWERAGE DEPARTMENT
E					
D				DRAWN BY:	CAPITAL IMPROVEMENT PROGRAM
С				CHECKED BY:	
В				CHECKED BT.	HIGH PRIORITY NEIGHBORHOODS
A ISSUED FOR PROCUREMENT	-	-	4/1/2020	MANAGER:	PIPE AND MANHOLE REHABILITATION REPAIRS
DESCRIPTIONS / REVISIONS	ONS CHK'D	APPR.	DATE		I II LAND WANTOLL KLIIADILITATION KLI AIKO

MDEQ SRF Project No. REF. No. CITY OF DETROIT WATER AND SEWERAGE DEPARTMENT FILE No.

SECTION

RANGE

TOWN

SECTION MAP

CS-1812 DWSD CONTRACT No. DWS-916

DRAWING No. PORTION CODE

A - P&MH (1 of 2)

PIPE REPAIR TABLE

Pipe Repair ID	Up Stream Node ID	Down Stream Node ID	Pipe Segment Ref / Asset ID	Location	Start Length From Upstream Node (ft)	Repair Length (ft)	Total Pipe Length (ft)	Repair Type	Shape	Width (in)	Height (in)	Material	US MH Depth (ft	DS MH) Depth (ft)	No. of Taps	No. of Active Taps	No. of Intruding Taps	No. of Root Defects > 20%	No. of Root Defects < 20%	Continuous Root Length	No. of Obstruction Defects >20%	No. of Obstruction Defects <20%	No. of Grease Defects > 20%	No. of Grease Defects < 20%	No. of Encrustations > 20%	No. of Encrustations < 20%	Continuous Encrustation Length	Deposit Defects	% Length Not Surveyed
ND148151_535	ND14815	ND16995	WWGM0000139541	In Street near Intersection of East Ave, Saint Antoine St and West Ave	73	8.0	119.5	TPR-Liner	С	18	18	RCP	9.7	12.18	0	0	0	0	0	0	0	0	0	0	0	0	0	0	11
ND203651_461	ND20365	MH46746	WWGM0000189185	In Street near Intersection of East Ave and Eliot St	100	1.0	264.7	TPR-Pointing	Е	36	40	BR	9.621	8	8	6	1	0	0	0	0	0	0	0	0	2	257.1	3	0
ND203651_462	ND20365	MH46746	WWGM0000189185	In Street near Intersection of East Ave and Eliot St	92	2.0	264.7	TPR-Pointing	Е	36	40	BR	9.621	8	8	6	1	0	0	0	0	0	0	0	0	2	257.1	3	0
ND216821_497	ND21682	MH32289	WWGM0000148419	In Alley near Intersection of Saint Antoine St and Wilkins St	0	104.9	104.9	LINE (A, C)	Е	20	15	BR	9.229	11.2	1	1	0	0	0	0	0	0	0	0	0	2	20.2	0	77
ND22219A1_451	ND22219A	ND22219B	WWGM0000149301-2	In Street near Intersection of Eliot St and Saint Antoine St	0	68.3	68.3	LINE (B, H) (Blind Tee)	С	10	10	VCP	11.5	12	0	0	0	0	0	0	0	1	0	1	0	10	0	0	25
ND26425A1_471	ND26425A	ND22219B	WWGM0000189165-1	In Street near Intersection of Eliot St and Saint Antoine St	78	1.0	160.0	TPR-Pointing	С	48	48	BR	13.42	13.23	1	1	0	0	0	0	0	0	0	0	0	2	158.9	2	0
ND282931_422	ND28293	MH39939	WWGM0000189153	In Street near Intersection of S I 75 Service Drive and Wilkins St	11	5.0	110.4	TPR-Pointing	Е	36	54	BR	16.13	16.376	2	2	1	0	0	0	0	0	0	0	0	6	0	0	0
ND302001_465	ND30200	ND30200A	WWGM0000189176	In Street near Intersection of East Ave, Saint Antoine St and West Ave	230	2.0	230.7	TPR-Pointing	Е	36	48	BR	12.615	13.029	7	7	2	0	0	0	0	0	0	0	1	1	229.775	0	0
ND8513AA1_453	ND8513AA	ND21106C	WWGM0000118608-3D	In Street near Intersection of S I 75 Service Drive and Wilkins St	_	-	-	External Point Repair (See Sheet S-11)	-	-	-	_	-	-	_	-	-	-	-	1	-	-	-	-	-	_	-	_	0
ND8513AA1_489	ND8513AA	ND21106C	WWGM0000118608-3D	In Street near Intersection of S I 75 Service Drive and Wilkins St	0	64.7	64.7	LINE	С	12	12	VCP	11.6	11.6	0	0	0	0	0	0	0	0	0	0	0	1	0	0	0
MH198221_470	MH18922A	ND28293	WWGM0000160308	In Street near Intersection of S I 75 Service Drive and Wilkins St	0	2.0	36.8	TPR-Pointing	Е	36	54	BR	15.2	16.13	7	5	1	0	0	0	0	0	0	0	0	9	9.4	0	0
MH254471_478	MH25447	ND29027	WWGM0000170604	In Alley near Intersection of N I 75 Service Drive and Wilkins St	47	3.0	118.9	TPR-Liner	С	66	66	RCP	26.993	27.655	0	0	0	0	0	0	0	0	0	0	0	1	117.917	0	0
MH264391_489	MH26439	MH26439A	WWGM0000160278	In Street near Intersection of East Ave, Saint Antoine St and West Ave	0	122.2	122.2	LINE (E) (See Note AA)	Е	36	48	BR	13	13.68	3	3	2	0	0	0	1	0	0	0	0	2	9.7	1	78
MH46746CCU1_552	MH46746CCU	MH46746ACU	WWGM0000110533-5U	In Alley near Intersection of East Ave and Eliot St	0	103.3	103.3	LINE	С	10	10	VCP	8.2	12	3	3	0	0	0	0	0	0	0	0	0	3	95.6	0	3
MH53340C1_538	MH53340C	MH53340D	WWGM0000109243-4	In Alley near Intersection of S I 75 Service Drive and Wilkins St	0	37.2	37.2	LINE	С	10	10	BR	12	12.9	0	0	0	0	0	0	0	0	0	0	0	4	18.7	0	5

Note AA:
Grinding of bricks may be necessary.
Final determination in field after cleaning prior to lining.

Pipe Repair Table Notes:
In locations where CCTV was not complete, Contractor to CCTV entire segment and send televising results to Engineer to confirm repair or recommend another repair(s) prior to making repair(s). Below is reason for incomplete CCTV:

(A) Inaccessible, (B) No Reversal, (C) Manhole Not Found, (D) Abandoned Due To Roots, (E) Abandoned Due To Obstruction, (F) Abandoned Due To High Water, (G) Line Deviation, (H) Encrustation, (I) Debris, (J) Joint Defect.


West Ave

F		DESIG	IGNED BY:	SEAL / STAMP	DETROIT WATER AND SEWERAGE DEPARTMENT
E					
D		DRAW	WN BY:		CAPITAL IMPROVEMENT PROGRAM
С		OUE-0	OVED DV		
В		CHEC	CKED BY:		HIGH PRIORITY NEIGHBORHOODS
Α	ISSUED FOR PROCUREMENT _	- 4/1/2020 MANA	IAGER:		PIPE AND MANHOLE REHABILITATION REPAIRS
	DESCRIPTIONS / REVISIONS CHK'D				FIFE AND MAININGLE INCHADILITATION REPAIRS



5688-01 CS-1812 DWS-916

PORTION CODE A - P&MH (2 of 2)

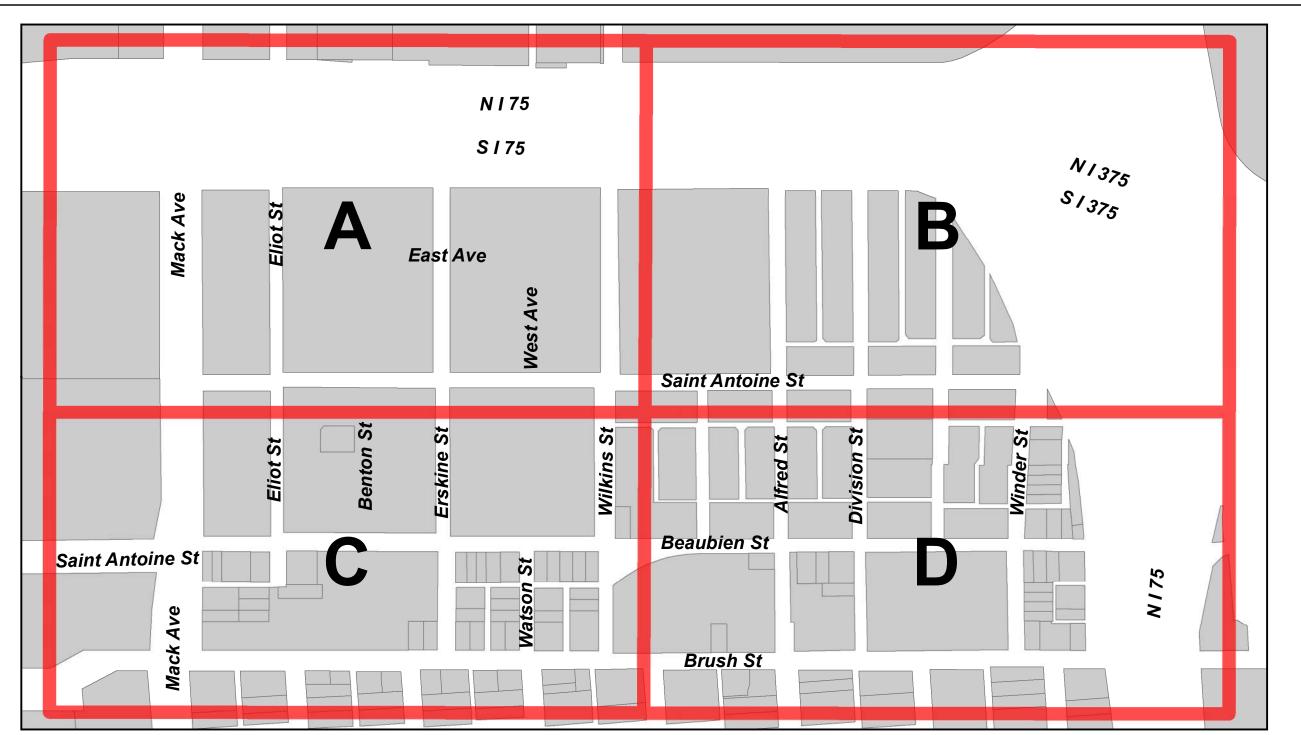

DESIGNED BY:

DRAWN BY:

CHECKED BY:

MANAGER:

- 4/1/2020

ISSUED FOR PROCUREMENT

DESCRIPTIONS / REVISIONS | CHK'D | APPR. | DATE


SEAL / STAMP

DETROIT WATER AND SEWERAGE DEPARTMENT

CAPITAL IMPROVEMENT PROGRAM

HIGH PRIORITY NEIGHBORHOODS

O&M PIPE AND MANHOLE REHABILITATION REPAIRS

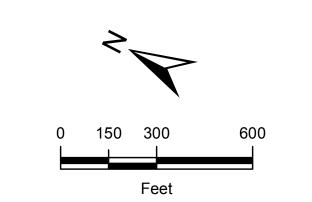

MDEQ SRF Project No.

DWSD CONTRACT No.

FILE No.

PORTION CODE

DRAWING No.

CITY OF DETROIT

SECTION

SECTION MAP

WATER AND SEWERAGE DEPARTMENT

RANGE


5688-01

CS-1812

DWS-916

INDEX - O&M



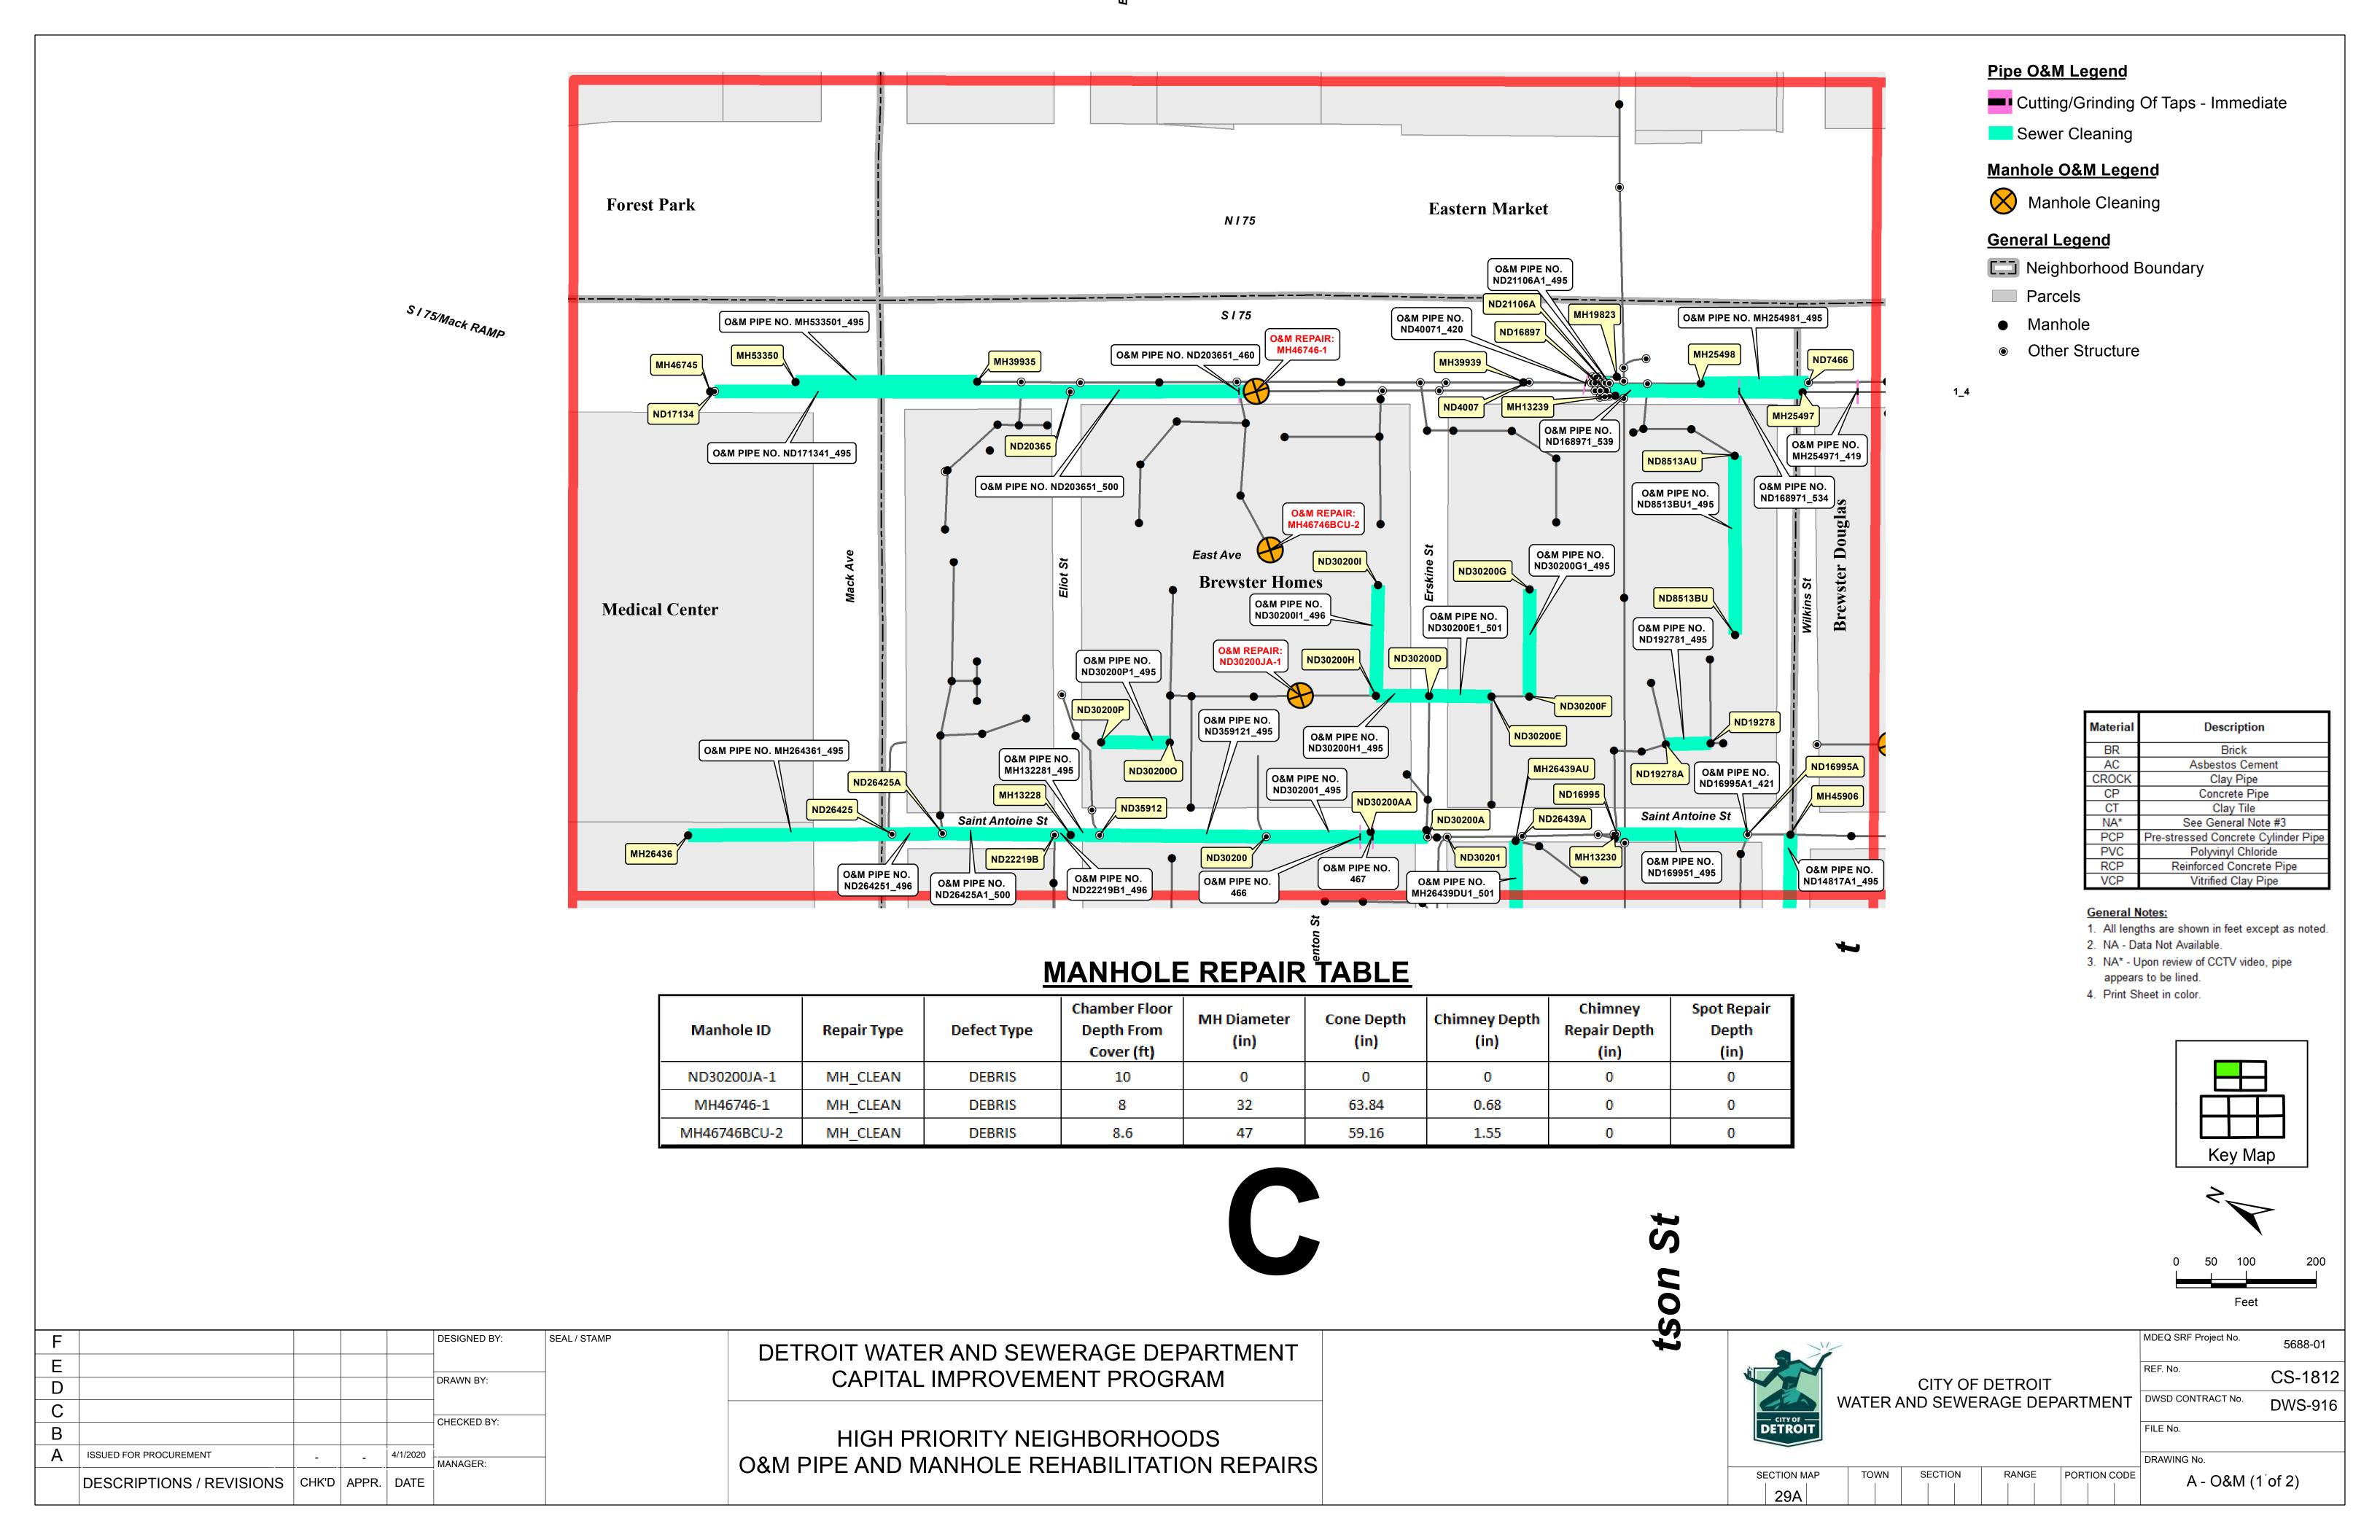

PIPE REPAIR TABLE

Pipe Repair ID	Up Stream Node ID	Down Stream Node ID	Pipe Segment Ref / Asset ID	Location	Start Length From Upstream Node (ft)	Repair Length (ft)	Total Pipe Length (ft) Repair Type	Defect Type	Shape	Width (in)	Height (in)	Material	US MH Depth (ft)		No. of Taps			Io. of Root N Defects > 1 20%	Defects <	Continuous Root Length	No. of Obstruction Defects >20%		Detects	Defects	No. of ncrustations E > 20%	No. of ncrustations < 20%	Continuous Encrustation Length	No. of Other Deposit Defects >20%	Not
466	ND30200	ND30200A	WWGM0000189176	In Street near Intersection of Saint Antoine St and Erskine St	133	2.0	230.7 CUT_GRIND_I	O&M	E	36	48	BR	12.615	13.029	7	7	2	0	0	0	0	0	0	0	1	1	229.775	0	0
467	ND30200	ND30200A	WWGM0000189176	In Street near Intersection of Saint Antoine St and Erskine St	151	2.0	230.7 CUT_GRIND_I	O&M	E	36	48	BR	12.615	13.029	7	7	2	0	0	0	0	0	0	0	1	1	229.775	0	0
ND14817A1_495	ND14817A	MH45906	WWGM0000141445-1	In Street near Intersection of Saint Antoine St and Wilkins St	0	122.3	122.3 CLEAN	O&M	E	15	18	BR	11	11.8	0	0	0	0	0	0	1	0	0	0	0	2	0	0	4
ND168971_534	ND16897	MH25497	WWGM0000189183	In Street near Intersection of S I 75 Service Drive and Wilkins St	189	2.0	280.3 CUT_GRIND_I (C) (See Note AA) O&M	E	30	40	BR	9.204	10	7	7	1	0	0	0	0	0	0	0	1	2	55.3	1	94
ND168971_539	ND16897	MH25497	WWGM0000189183	In Street near Intersection of S I 75 Service Drive and Wilkins St	0	280.3	280.3 CLEAN (C)	O&M	E	30	40	BR	9.204	10	7	7	1	0	0	0	0	0	0	0	1	2	55.3	1	94
ND169951_495	ND16995	ND16995A	WWGM0000189109	In Street near Intersection of East Ave, Saint Antoine St and Wilkins St	0	186.9	186.9 CLEAN (G)	O&M	E	36	48	BR	13.4	12	8	8	0	0	0	0	2	1	0	0	0	1	157.849	0	7
ND16995A1_421	ND16995A	MH45906	WWGM0000189109-1	In Street near Intersection of Saint Antoine St and Wilkins St	0	1.0	61.0 CUT_GRIND_I (G)	O&M	E	36	48	BR	12	12.5	3	3	1	0	0	0	0	0	0	0	0	1	60.951	0	0
ND171341_495	ND17134	ND20365	WWGM0000189115	In Street near Intersection of Mack Ave and S I 75 Service Drive	0	508.4	508.4 CLEAN	O&M	E	36	40	BR	5.48	9.621	21	20	1	0	0	0	0	0	0	0	2	4	499.2	0	0
ND192781_495	ND19278	ND19278A	WWGM0000189133-1	In Alley near Intersection of East Ave, Saint Antoine St and West Ave	0	64.0	64.0 CLEAN	O&M	С	10	10	PVC	9.5	9.8	2	2	0	0	0	0	0	0	0	2	1	1	0	0	0
ND203651_460	ND20365	MH46746	WWGM0000189185	In Street near Intersection of East Ave and Eliot St	240	2.0	264.7 CUT_GRIND_I	O&M	E	36	40	BR	9.621	8	8	6	1	0	0	0	0	0	0	0	0	2	257.1	3	0
ND203651_500	ND20365	MH46746	WWGM0000189185	In Street near Intersection of East Ave and Eliot St	0	264.7	264.7 CLEAN	O&M	E	36	40	BR	9.621	8	8	6	1	0	0	0	0	0	0	0	0	2	257.1	3	0
ND21106A1_495	ND21106A	ND21106B	WWGM0000189114-1	In Street near Intersection of S I 75 Service Drive and Wilkins St	0	6.2	6.2 CLEAN	O&M	E	36	54	BR	16.35	16.45	1	1	0	0	0	0	1	0	0	0	0	0	0	0	0
ND22219B1_496	ND22219B	MH13228	WWGM0000189165-2	In Street near Intersection of Eliot St and Saint Antoine St	0	23.2	23.2 CLEAN	O&M	С	48	48	BR	13.23	13.293	2	2	0	0	0	0	0	0	0	0	0	2	15.8	2	0
ND264251_496	ND26425	ND26425A	WWGM0000189165	In Street near Intersection of Mack Ave and Saint Antoine St	0	71.9	71.9 CLEAN	O&M	С	48	48	BR	13.228	13.42	5	5	1	0	0	0	0	0	0	0	0	2	67.8	2	6
ND26425A1_500	ND26425A	ND22219B	WWGM0000189165-1	In Street near Intersection of Eliot St and Saint Antoine St	0	160.0	160.0 CLEAN	O&M	С	48	48	BR	13.42	13.23	1	1	0	0	0	0	0	0	0	0	0	2	158.9	2	0
ND302001_495	ND30200	ND30200A	WWGM0000189176	In Street near Intersection of Benton St and West Ave	0	230.7	230.7 CLEAN	O&M	E	36	48	BR	12.615	13.029	7	7	2	0	0	0	0	0	0	0	1	1	229.775	0	0
ND30200E1_501	ND30200E	ND30200D	WWGM0000189175-4	In Alley near Intersection of East Ave, Saint Antoine St and West Ave	0	89.1	89.1 CLEAN (G)	O&M	С	10	10	PVC	8.4	8.9	4	4	0	0	0	0	0	0	0	5	0	0	0	0	24
ND30200G1_495	ND30200G	ND30200F	WWGM0000189175-6	In Alley near Intersection of East Ave, Saint Antoine St and West Ave	0	153.1	153.1 CLEAN (E)	O&M	С	10	10	PVC	8	9.1	10	10	0	0	0	0	1	1	0	4	0	0	0	0	24
ND30200H1_495	ND30200H	ND30200D	WWGM0000189175-7	In Alley near Intersection of East Ave, Saint Antoine St and West Ave	0	75.8	75.8 CLEAN	O&M	С	12	12	PVC	9.6	8.9	3	3	0	0	0	0	0	0	1	4	0	0	0	0	0
ND30200I1_496	ND30200I	ND30200H	WWGM0000189175-8	In Alley near Intersection of East Ave, Saint Antoine St and West Ave	0	158.3	158.3 CLEAN	O&M	С	10	10	PVC	6.3	9.4	13	13	0	0	0	0	0	0	0	2	0	0	0	1	0
ND30200P1_495	ND30200P	ND30200O	WWGM0000189175-15	In Alley near Intersection of Eliot St and Saint Antoine St	0	98.3	98.3 CLEAN	O&M	С	10	10	PVC	5	8.2	1	1	0	0	0	0	0	0	0	0	1	0	0	0	0
ND359121_495	ND35912	ND30200	WWGM0000189174	In Street near Intersection of Eliot St and Saint Antoine St	0	238.0	238.0 CLEAN	O&M	С	48	48	BR	13.449	12.615	5	4	0	0	0	0	0	0	0	0	2	2	184.6	0	0
ND40071_420	ND4007	ND2881	WWGM0000189111	In Street near Intersection of S I 75 Service Drive and Wilkins St	80	2.0	89.5 CUT_GRIND_I	O&M	E	36	54	BR	15.895	15.774	4	4	1	0	0	0	0	0	0	0	0	3	95	0	0
ND8513BU1_495	ND8513BU	ND8513AU	WWGM0000118608-2U	In Alley near Intersection of S I 75 Service Drive and Wilkins St	0	256.2	256.2 CLEAN	O&M	С	10	10	PVC	7.4	9.8	10	10	0	0	0	0	0	0	0	0	1	3	0	0	0
MH132281_495	MH13228	ND35912	WWGM0000180119	In Street near Intersection of Eliot St and Saint Antoine St	0	41.6	41.6 CLEAN	O&M	С	48	48	BR	13.293	13.449	5	4	0	0	0	0	2	0	0	0	0	2	38.8	0	0
MH254971_419	MH25497	ND36753	WWGM0000110462	In Street near Intersection of S I 75 Service Drive and Wilkins St	77	3.0	127.6 CUT_GRIND_I	O&M	Е	36	48	BR	10	10.128	5	4	1	0	0	0	0	5	0	0	0	4	126.3	0	0
MH254981_495	MH25498	ND7466	WWGM0000140318	In Street near Intersection of S I 75 Service Drive and Wilkins St	0	153.7	153.7 CLEAN	O&M	Е	36	48	BR	16.2	16.792	3	3	0	0	0	0	1	7	0	0	0	3	39.3	0	0
MH264361_495	MH26436	ND26425	WWGM0000170267	In Street near Intersection of Mack Ave and Saint Antoine St	0	291.7	291.7 CLEAN	O&M	С	48	48	BR	12.778	13.228	11	9	0	0	0	0	2	0	0	0	0	2	238.6	2	0
MH26439DU1_501	MH26439DU	MH26439AU	WWGM0000189151-4U	In Alley near Intersection of East Ave, Saint Antoine St and West Ave	0	200.8	200.8 CLEAN	O&M	С	10	10	PVC	8.2	12.3	11	11	0	0	0	0	0	0	0	1	0	0	0	0	0
MH533501_495	MH53350	MH39935	WWGM0000170052	In Street near Intersection of Mack Ave and S I 75 Service Drive	0	259.3	259.3 CLEAN	O&M	Е	36	54	BR	16	15.464	3	3	0	0	0	0	0	0	0	0	2	4	153.3	0	0

Note AA:
Grinding of bricks may be necessary.
Final determination in field after cleaning prior to lining.

Pipe Repair Table Notes:
In locations where CCTV was not complete, Contractor to CCTV entire segment and send televising results to Engineer to confirm repair or recommend another repair(s) prior to making repair(s). Below is reason for incomplete CCTV:

(A) Inaccessible, (B) No Reversal, (C) Manhole Not Found, (D) Abandoned Due To Roots, (E) Abandoned Due To Obstruction, (F) Abandoned Due To High Water, (G) Line Deviation, (H) Encrustation, (I) Debris, (J) Joint Defect.

West Ave

SECTION MAP

F					DESIGNED BY:	SEAL / STAMP	DETROIT WATER AND SEWERAGE DEPARTMENT
E							
D					DRAWN BY:		CAPITAL IMPROVEMENT PROGRAM
С					CHECKED BY:		
В					- CHECKED DT.		HIGH PRIORITY NEIGHBORHOODS
Α	ISSUED FOR PROCUREMENT	-	-	4/1/2020	MANAGER:		O&M PIPE AND MANHOLE REHABILITATION REPAIRS
	DESCRIPTIONS / REVISIONS	CHK'D	APPR.	DATE			
I							

CITY OF DETROIT WATER AND SEWERAGE DEPARTMENT

SECTION

CS-1812 DWSD CONTRACT No. DWS-916 FILE No.

PORTION CODE

RANGE

MDEQ SRF Project No.

A - O&M (2 of 2)

5688-01


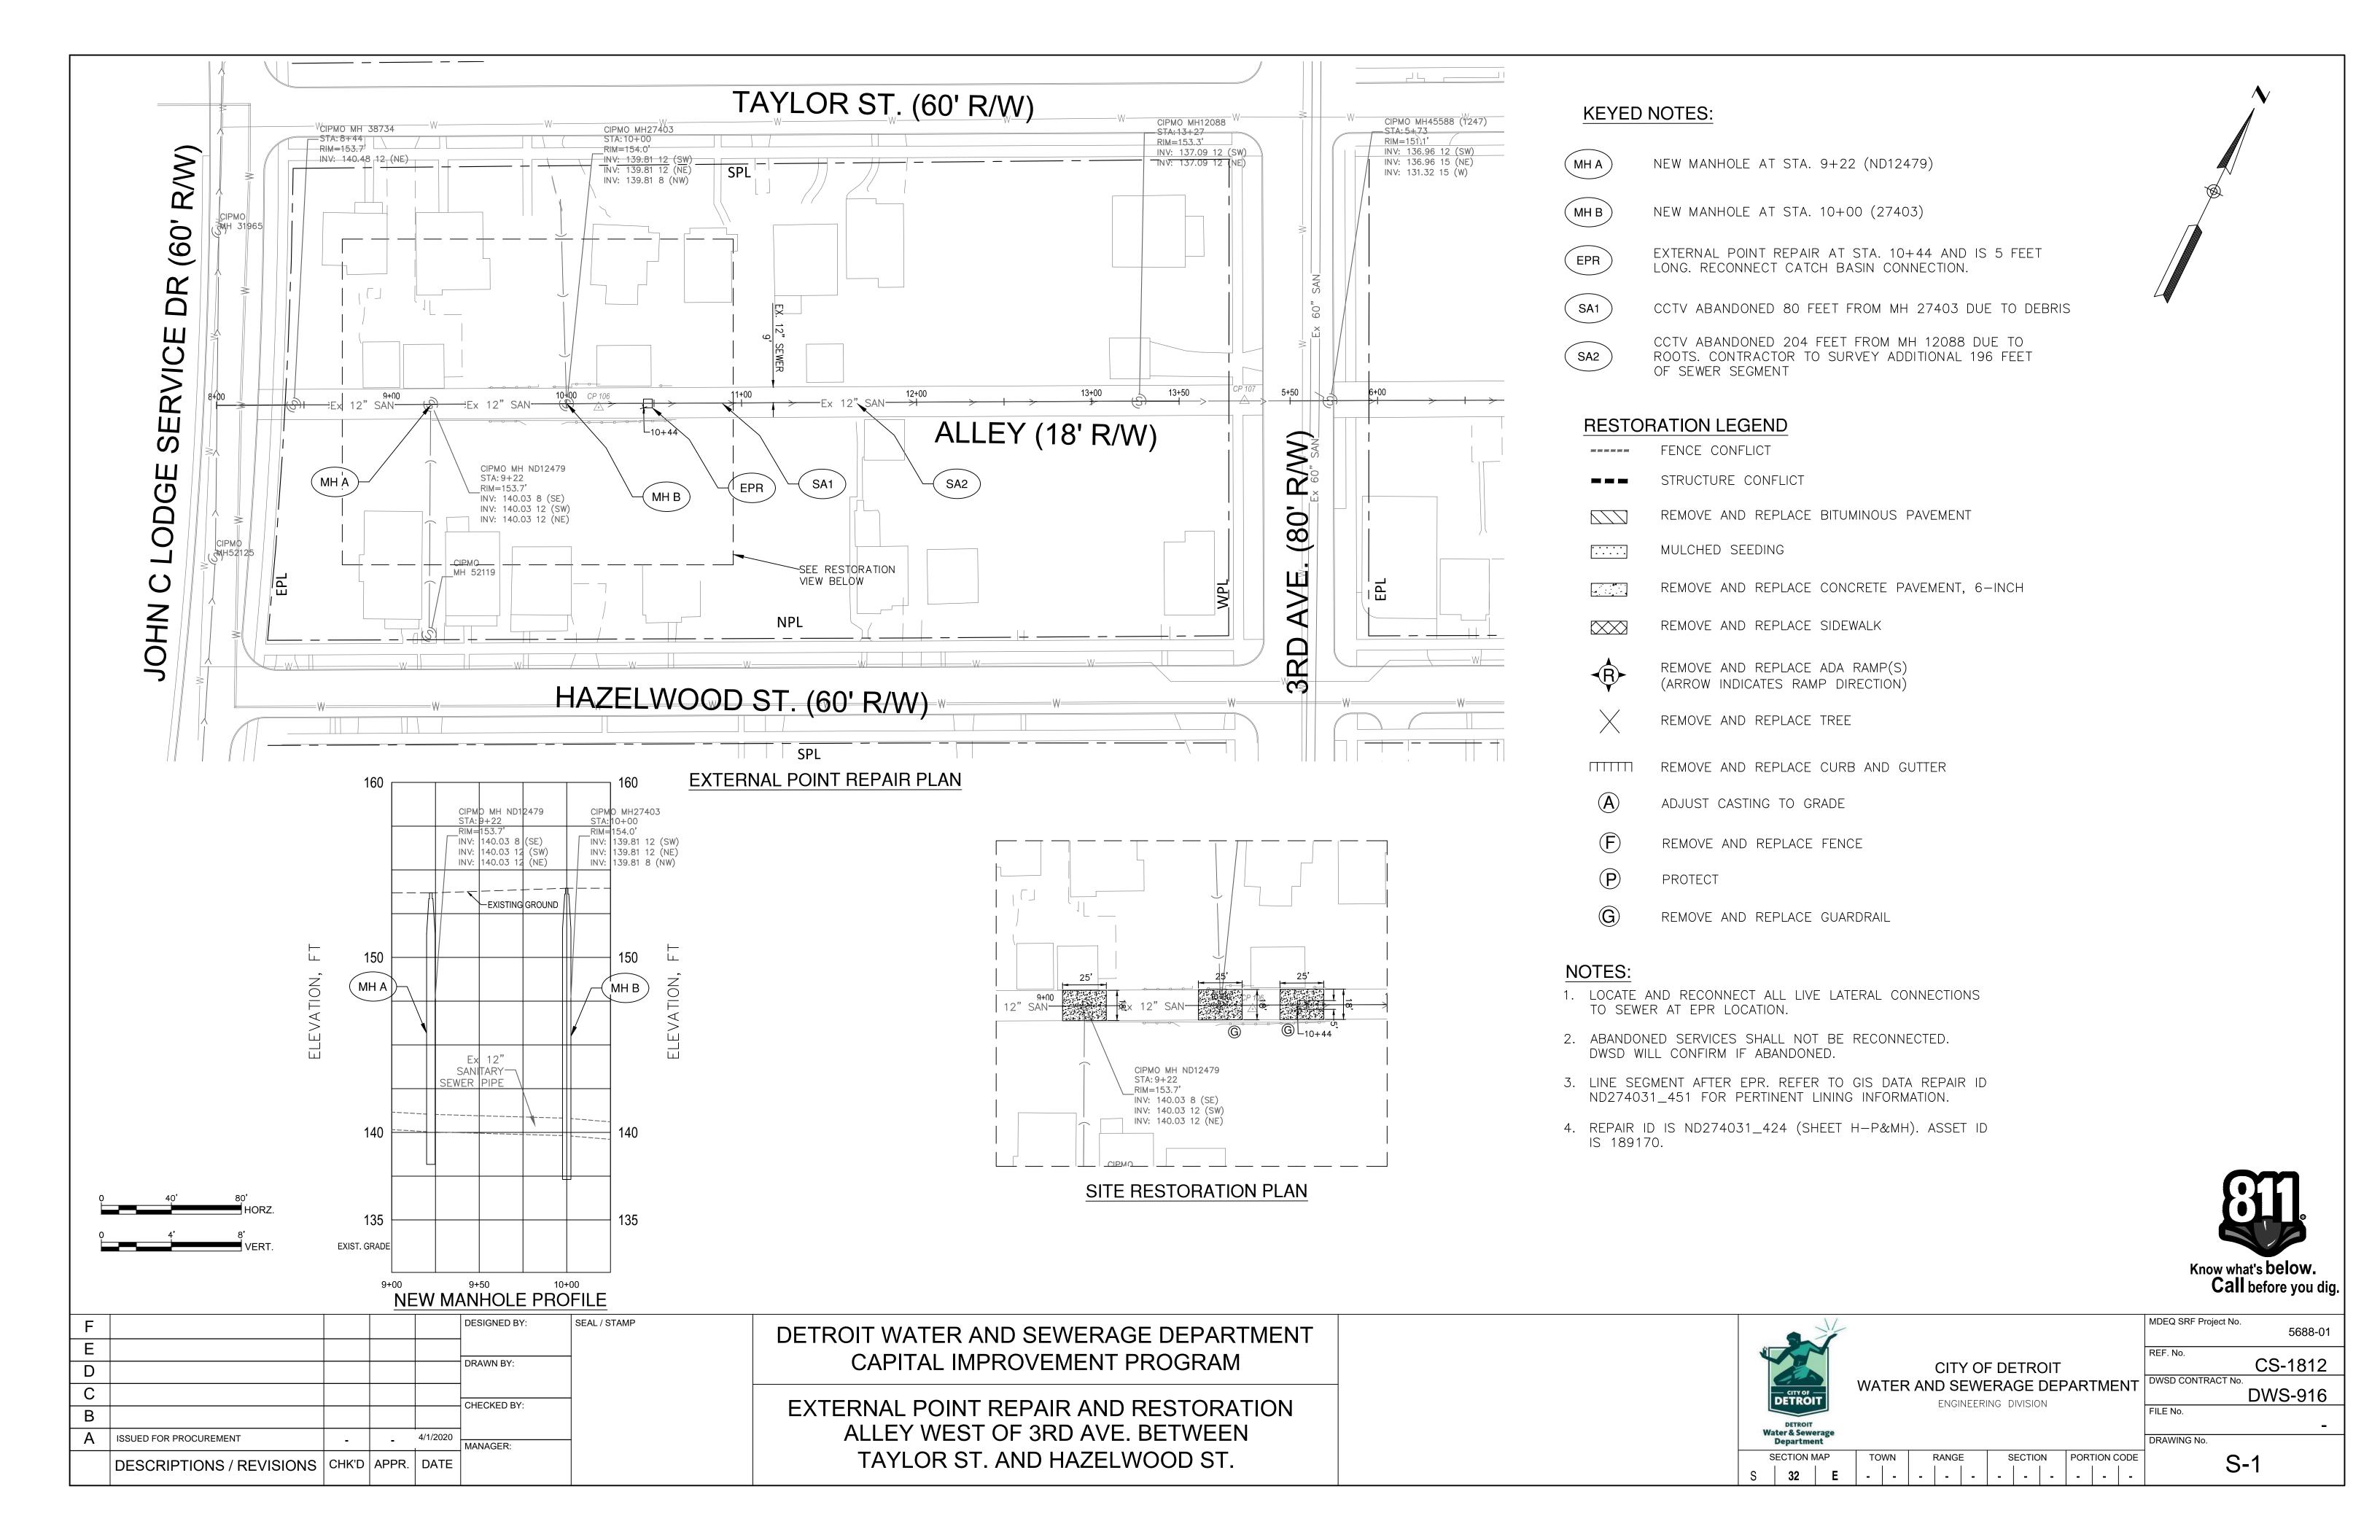


FIGURE 6H-26 CLOSURE IN CENTER OF INTERSECTION (TA-26) ROAD WORK AHEAD W20-1R3-5 , R3-2 R3-5 R3-2 R3-5 R3-2 TYPICAL APPLICATION 26

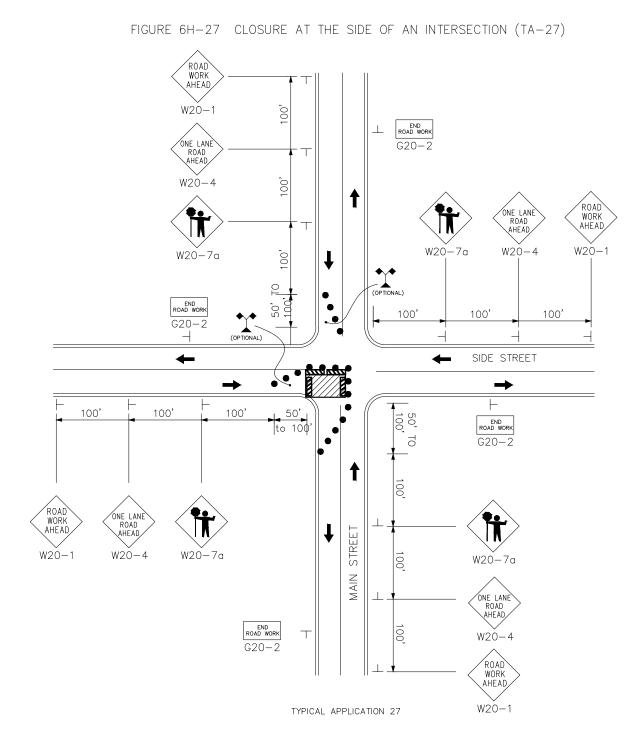


(OPTIONAL) SIDE STREET 380H 5000 08970 XMM308 R9—11a SIDEWALK CLOSED R9-9 **XXX** sidewalk closed R9-9 XXXX SECRALA CLORED ORGANIS MERIC SIDE STREET


FIGURE 6H-28 SIDEWALK DETOUR OR DIVERSION (TA-28)

SIDEWALK CLOSED PEDESTRIAN TYPE II BARRICADE, TEMP R9—9 (30" X 18") MOUNTED ON SEPARATE SUPPORTS CENTERED ON SIDEWALK

FIGURE 6H-20 DETOUR FOR A CLOSED STREET (TA-20)

TO CLOSE OFF LOW-TRAFFIC-VOLUME, NON-THROUGH, INTERSECTING STREETS FOR SHORT TERM.

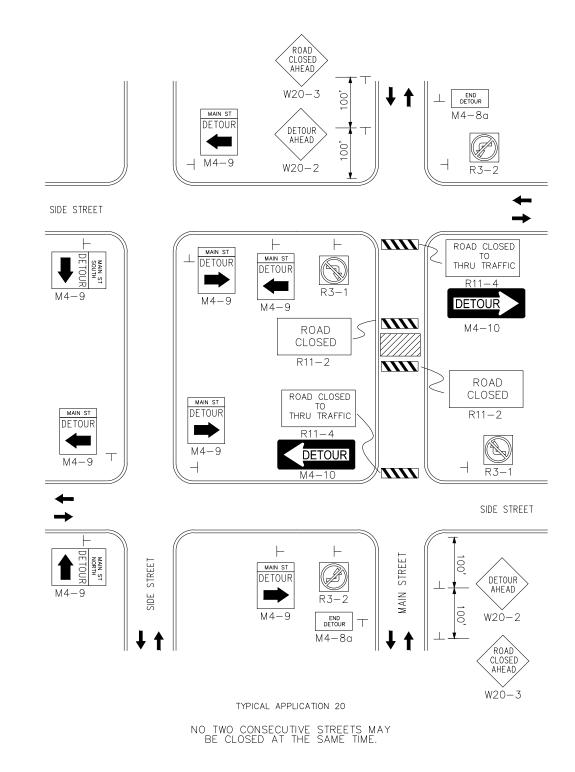

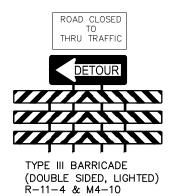

PEDESTRIAN AND VEHICULAR TRAFFIC CONTROL

TYPICAL APPLICATION 28

PUBLIC SAFETY AND NORMALCY ARE OF PARAMOUNT CONCERN AND IMPORTANCE. BOTH PEDESTRIAN AND VEHICULAR TRAFFIC ARE TO BE MAINTAINED IN THEIR NORMAL MODE AS MUCH AS POSSIBLE. WHEN NORMAL PEDESTRIAN OR VEHICULAR TRAFFIC MUST BE DISTURBED, SAFETY PRECAUTIONS MUST BE IMPLEMENTED CONCURRENTLY.

FOR BOTH VEHICULAR AND PEDESTRIAN TRAFFIC, SAFETY PROTECTION ITEMS, SUCH AS, BUT NOT LIMITED TO, LIGHTED BARRELS, LIGHTED ARROWS, DIRECTION AND WARNING SIGNS, PORTABLE CONCRETE BARRIERS, TEMPORARY PAVEMENT MARKINGS, AND TEMPORARY FENCING MUST BE INSTALLED, MAINTAINED AND REMOVED AS NEEDED.

VEHICULAR AND PEDESTRIAN TRAFFIC CONTROL AND SAFETY SHALL BE IN CONFORMANCE WITH THE REQUIREMENTS OF THE TRAFFIC ENGINEERING DIVISION OF THE CITY OF DETROIT DEPARTMENT OF PUBLIC WORKS, THE SPECIFICATIONS OF THE CITY OF DETROIT WATER AND SEWERAGE DEPARTMENT AND THE REQUIREMENTS OF THE MICHIGAN DEPARTMENT OF TRANSPORTATION. IF THE THREE ENTITIES HAVE DIFFERENT REQUIREMENTS FOR THE SAME ITEM, THE MOST STRICT SHALL APPLY AS DETERMINED BY THE ENGINEER.

IN GENERAL, TRAFFIC CONTROL SHALL BE ACCOMPLISHED IN ACCORDANCE WITH THE CURRENT VERSION OF THE MICHIGAN MANUAL OF UNIFORM TRAFFIC CONTROL DEVICES (MMUTCD). THE CONTRACTOR MUST USE BARRICADES, SIGNS, ARROW BOARDS, TEMPORARY PAINT LINES, ETC., APPROPRIATELY.

THE CONTRACTOR SHALL PROVIDE/INSTALL A POSTED PEDESTRIAN DETOUR WHENEVER NORMAL PEDESTRIAN MOVEMENT IS DISRUPTED. AS A GUIDE, USE FIGURES 6H-28 & 6H-29 OF THE MMUTCD TO REGULATE PEDESTRIAN TRAFFIC AROUND CONSTRUCTION AREAS. SIGNS, TO DIRECT PEDESTRIANS TO THE SIDE AND BACK STREETS OR THE OTHER SIDE OF THE STREET, MUST BE INSTALLED AT LOCATIONS WHERE THE CROSSING IS SAFE.

SUPPLY SUFFICIENT NUMBER OF PEDESTRIAN TYPE II BARRICADES TO CONNECT THEM TOGETHER FROM EDGE OF SIDEWALK TO EDGE OF SIDEWALK SUCH THAT THERE ARE NO GAPS BETWEEN THE BARRICADES.

SUPPORTS FOR SIGNS PLACED BEHIND THE PEDESTRIAN TYPE II BARRICADE(S) MUST BE ENTIRELY LOCATED BEHIND THE BARRICADE(S).

MMUTCD 2009 EDITION

TABLE 6H-2. MEANING OF SYMBOLS ON TYPICAL APPLICATION

ARROW PANEL CRASH CUSHION

ARROW PANEL SUPPORT OR TRAILER

(SHOWN FACING DOWN) CHANGEABLE MESSAGE SIGN OR SUPPORT TRAILER

CHANNELIZING DEVICE

DIRECTION OF TEMPORARY TRAFFIC DETOUR

DIRECTION OF TRAFFIC TRAFFIC REGULATOR

HIGH LEVEL WARNING DEVICE (FLAG TREE)

PAVEMENT MARKINGS THAT SHOULD BE REMOVED FOR A LONG TERM PROJECT SIGN (SHOWN FACING LEFT)

SURVEYOR

TEMPORARY BARRIER

TEMPORARY BARRIER WITH WARNING LIGHTS

TRAFFIC OR PEDESTRIAN SIGNAL TRUCK MOUNTED ATTENUATOR

TYPE III BARRICADE

PEDEDSTRIAN TYPE II BARRICADE

WARNING LIGHTS WORK SPACE

WORK VEHICLE

TEMPORARY LANE CLOSURE MAX 5 DAYS (PER BLOCK) TO REPAIR SEWER.

CONTRACTOR TO RESTORE EXISTING LANE MARKING, PAVEMENT CURB, SIDEWALK AND ANY OTHER ITEMS EXIST DURING CONSTRUCTION TO ITS ORIGINAL OR BETTER CONDITION AS APPROVED BY THE CITY ENGINEER.

CONTRACTOR TO PROVIDE ACCESS TO ALL DRIVEWAYS AT ALL TIMES.

CONTRACTOR TO USE A FLAGGER FOR BOTH DIRECTIONS OF TRAFFIC MOVEMENT AT


CONTRACTOR TO MAINTAIN ONE LANE OF TRAFFIC ON CROSS STREETS WHEN CROSSING INTERSECTIONS.

CONTRACTOR TO RESTORE ALL WORK IN A BLOCK BEFORE MOVING ONTO THE NEXT

SIGN DESIGNATION IS SHOWN BELOW THE SIGN. SEE TABLE 6F-1 OF MICHIGAN MANUAL ON UNIFORM TRAFFIC CONTROL DEVICES FOR SIGN SIZES OF EACH SIGN DESIGNATION.




F	DESIGNED BY:	SEAL / STAMP	DETROIT WATER AND SEWERAGE DEPARTMENT					MDEQ SRF Project No.	5688-01
E	TV		CAPITAL IMPROVEMENT PROGRAM					REF. No.	
D	DRAWN BY: DS/MK		CAPITAL IIVIPROVEIVIENT PROGRAM		CITY (WATER AND SEV	F DETROIT		DWSD CONTRACT No.	CS-1812
C	CHECKED BY:	_		DETROIT		RING DIVISION	I AITHILINI	FILE No.	DWS-916
B A JOSUED FOR PROGUEDEMENT	MM		TRAFFIC PLAN	DETROIT Water & Sewerage Department					
A ISSUED FOR PROCUREMENT	- 4/1/2020 MANAGER:	_	TYPICAL TRAFFIC CONTROL DETAILS	Department SECTION MAP	TOWN RANGE	SECTION	PORTION CODE	DRAWING No.	TP ₋ 1
DESCRIPTIONS / REVISIONS	CHK'D APPR. DATE RG			S			- - -		112-1

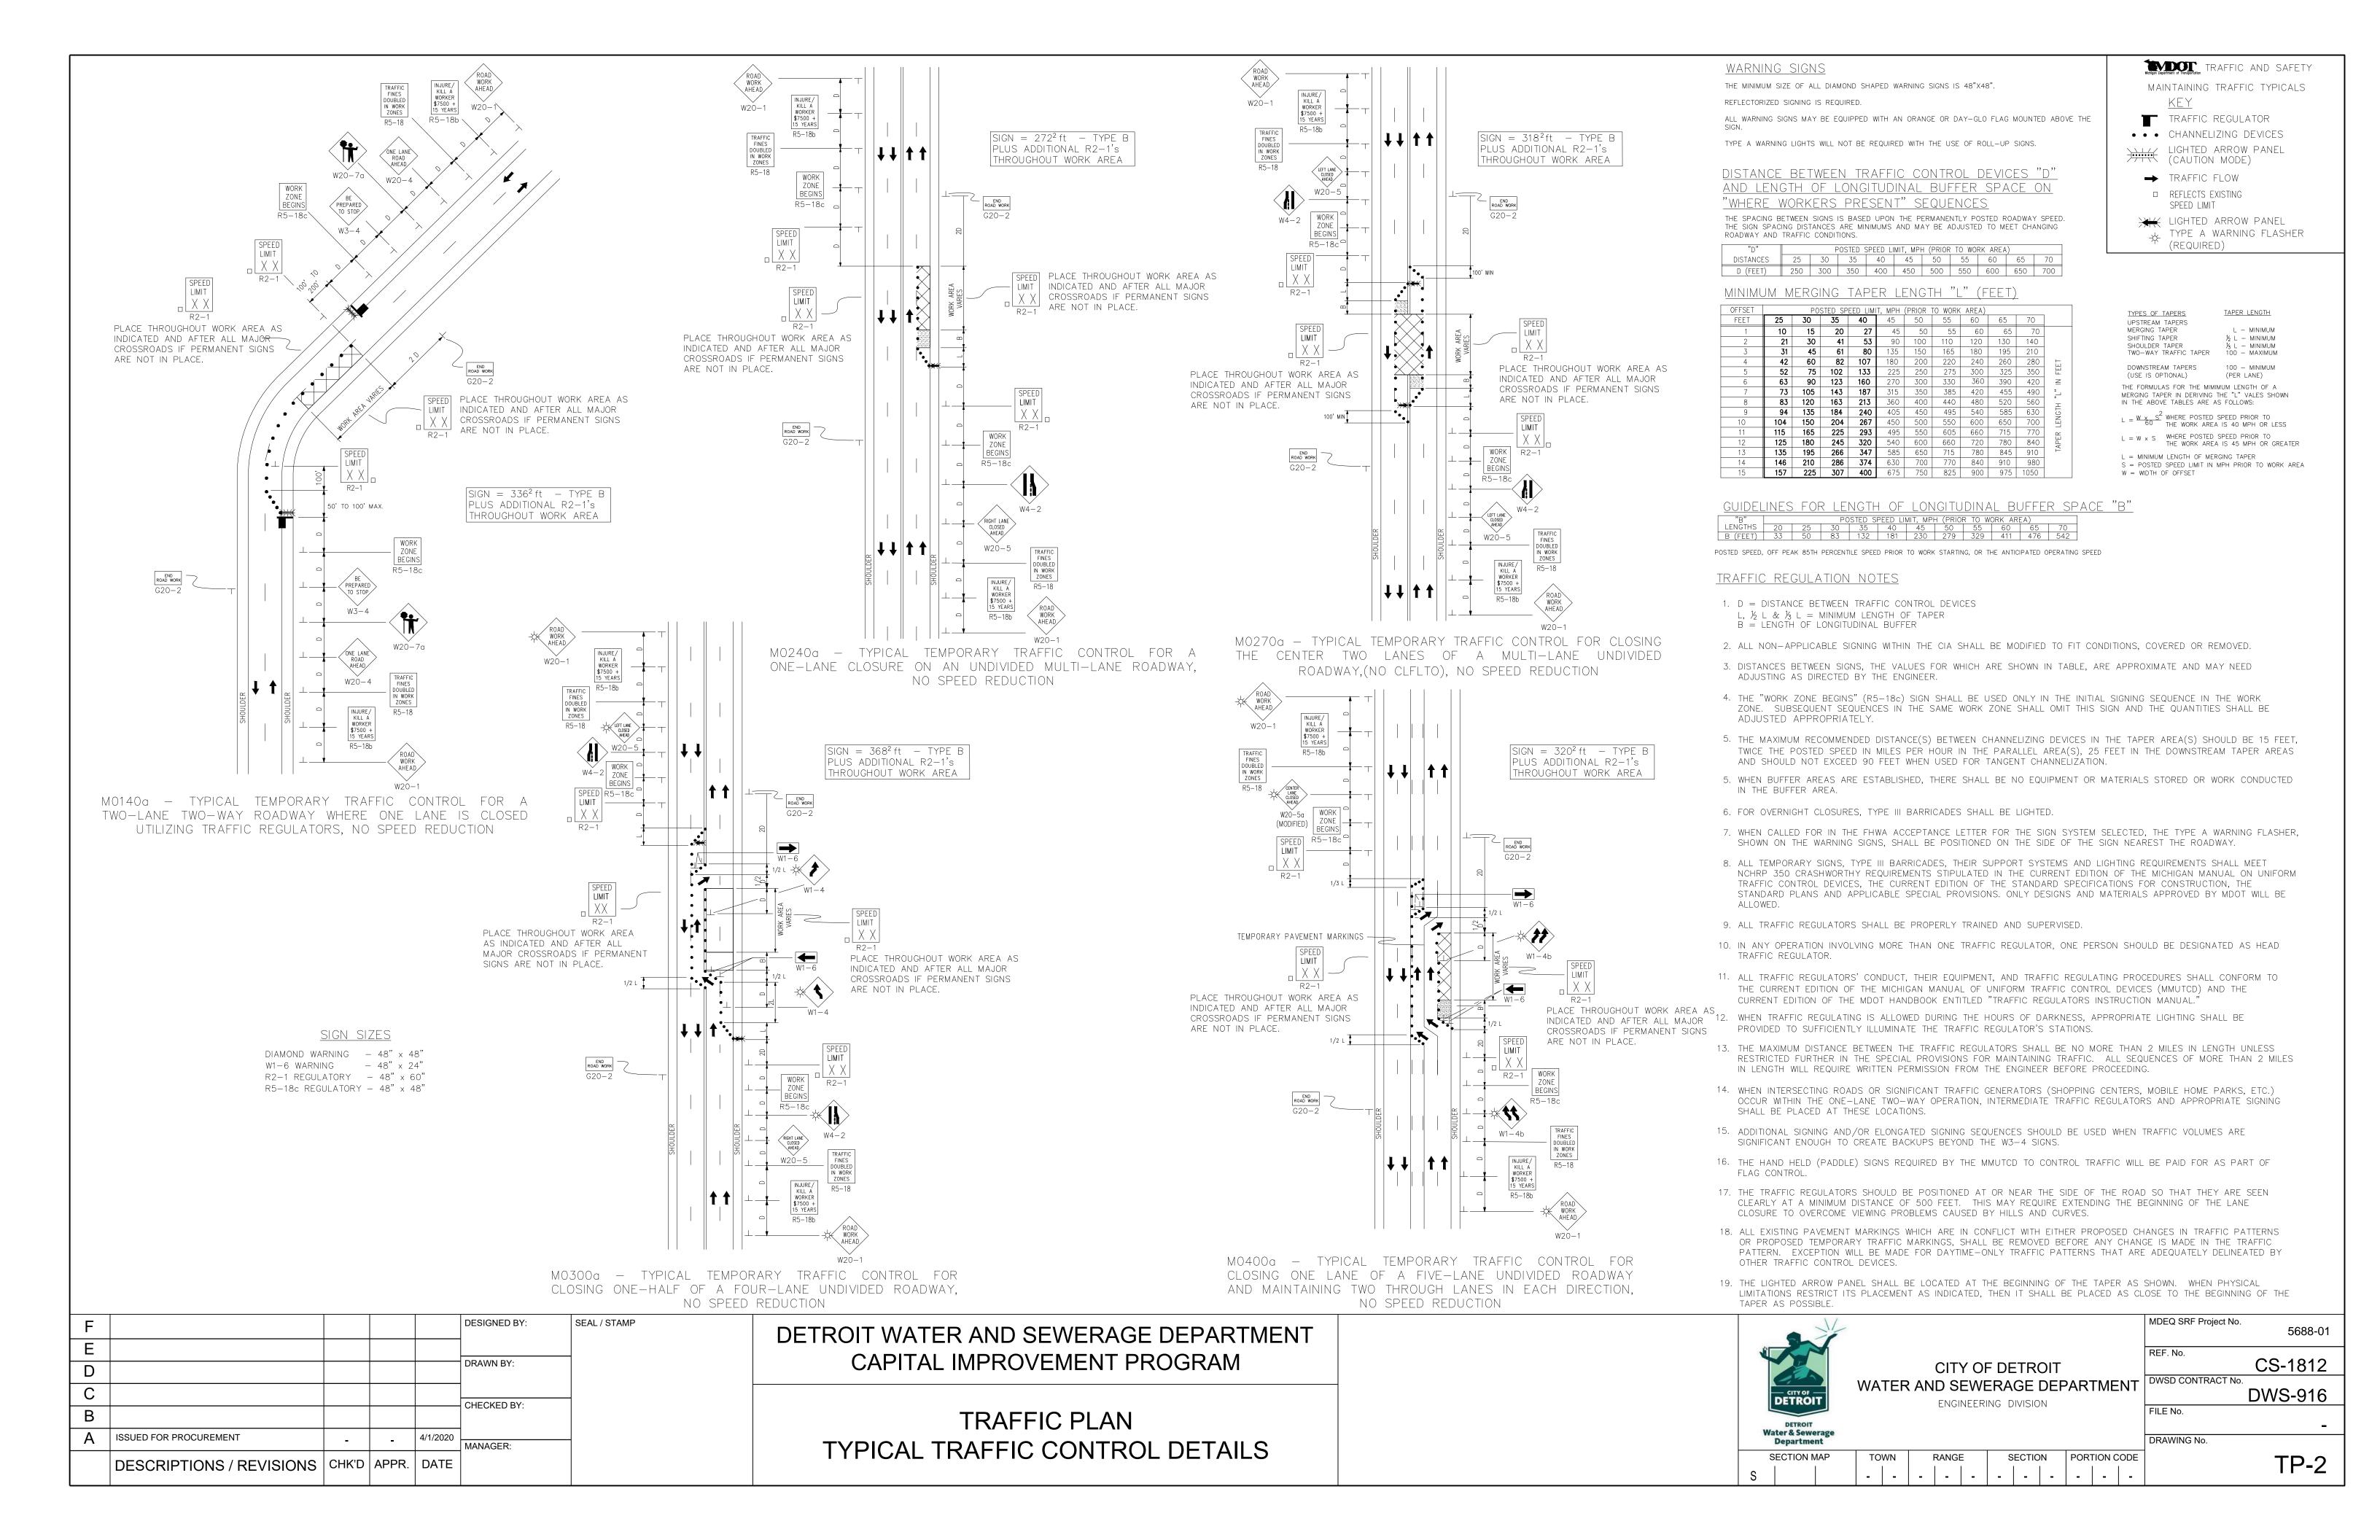



	MOT INFORMATION (DURING CONSTRUCTION AND RE	STORATION)	
ID	LOCATION	METHOD	МОТ
S-1	ALLEY WEST OF 3RD AVE. BETWEEN TAYLOR ST. AND HAZELWOOD ST.	OPEN CUT	NONE
S-2	N. JOHN C. LODGE SERVICE DR. BETWEEN PHILADELPHIA ST. AND EUCLID ST.	OPEN CUT	FULL CLOSURE
S-3	ALLEY SOUTH OF SEWARD AVE. BETWEEN 2ND AVE. AND WOODWARD AVE.	OPEN CUT	NONE
S-4	ALLEY NORTHEAST OF W. PHILADELPHIA ST. AND JOHN C. LODGE SERVICE DR.	OPEN CUT	NONE
S-5	ALLEY EAST OF 3RD AVE. BETWEEN TAYLOR ST. AND HAZELWOOD ST.	OPEN CUT	NONE
S-6	ALLEY SOUTH OF VIRGINIA PARK ST. BETWEEN 3RD AVE. AND JOHN C. LODGE SERVICE DR.	OPEN CUT	NONE
S-7	ALLEY EAST OF 3RD AVE. BETWEEN PALLISTER AVE. AND W. BETHUNE AVE.	OPEN CUT	NONE
S-8	SEWARD AVE. AND NORTHBOUND JOHN C. LODGE SERVICE DR.	OPEN CUT	INTERSECTION
S-9	ALLEY WEST OF WOODWARD AVE. BETWEEN DELAWARE ST. AND PALLISTER ST.	OPEN CUT	NONE
S-10	ALLEY EAST OF 3RD AVE. BETWEEN DELAWARE ST. AND SEWARD AVE.	OPEN CUT	LANE CLOSURE
S-11	SOUTHBOUND I-75 SERVICE DR. BETWEEN MACK AVE. AND WILKINS ST.	OPEN CUT	FULL CLOSURE
S-12	BEAUBIEN ST. BETWEEN MACK AVE. AND ELIOT ST.	OPEN CUT	LANE CLOSURE
S-13	ALLEY WEST OF 3RD AVE. BETWEEN LOTHROP ST. AND W. GRAND BLVD.	OPEN CUT	NONE
S-14	ALLEY EAST OF JOHN C. LODGE SERVICE DR. BETWEEN BLAINE ST. AND PINGREE ST.	OPEN CUT	NONE



F		DESIGNED BY: SEAL / STAMP	DETROIT WATER AND SEWERAGE DEPARTMENT			MDEQ SRF Project No. 5688-01
D		DRAWN BY:	CAPITAL IMPROVEMENT PROGRAM		CITY OF DETROIT	REF. No. CS-1812
СВ		CHECKED BY:	TRAFFIC PLAN	DETROIT	WATER AND SEWERAGE DEPARTMENT ENGINEERING DIVISION	DWS-916 FILE No.
A	ISSUED FOR PROCUREMENT 4/1/2020	MANAGER:	MAINTENANCE OF TRAFFIC INFORMATION	Water & Sewer Departmen		DRAWING No.
	DESCRIPTIONS / REVISIONS CHK'D APPR. DATE			SECTION M.	NP TOWN RANGE SECTION PORTION CODE - - - - - - - - - -	TP-3

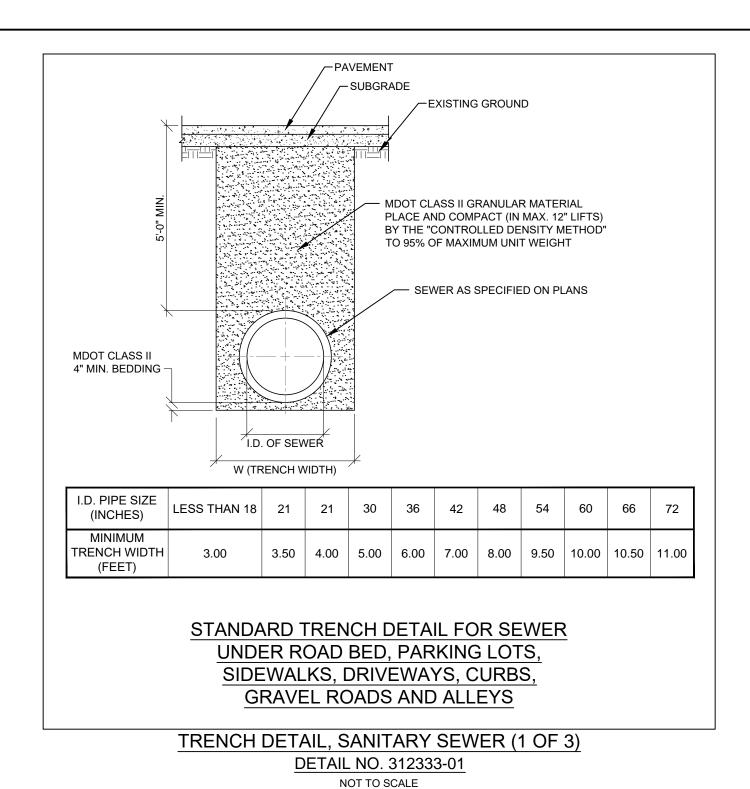

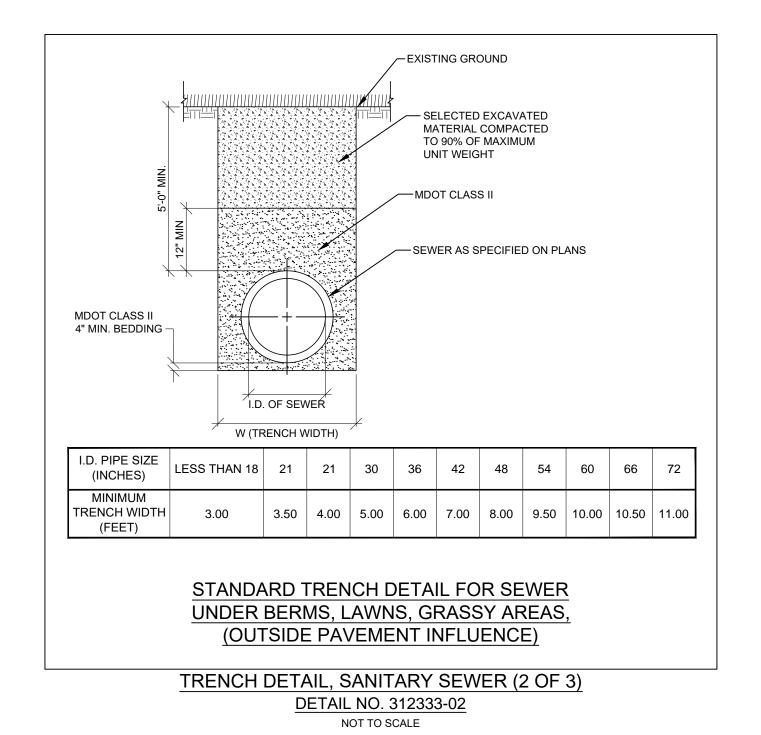

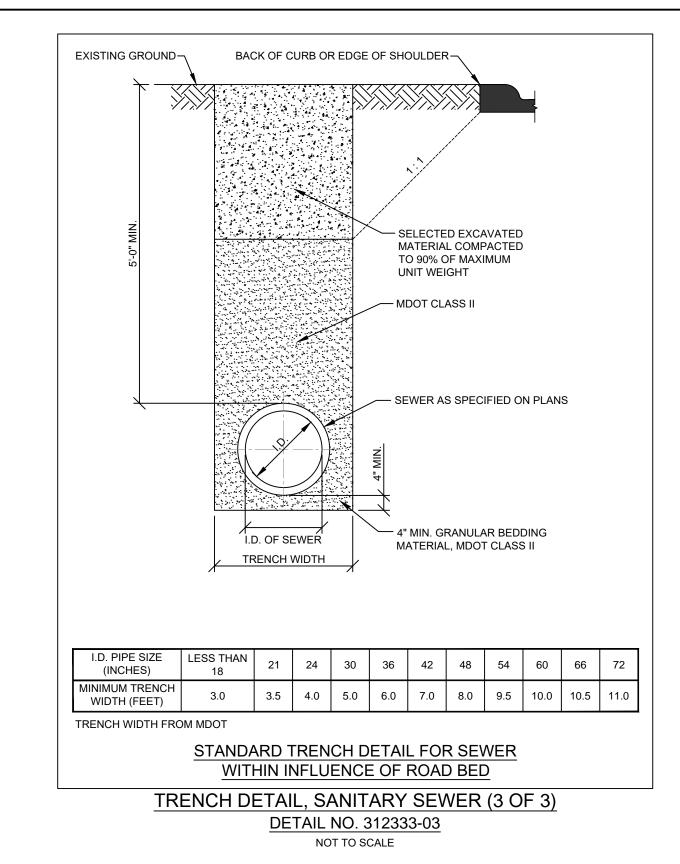



A RISER DIAMETER


(1) BACKFILL ACCORDING TO SPECIFICATIONS AND TYPICAL TRENCH SECTION. $\ensuremath{\bigcirc}$ EXISTING CATCH BASIN DRAIN. SEWER OR OTHER UNDERGROUND UTILITY CROSSING NEW OPEN CUT CONSTRUCTION. (3) BACKFILL WITH A DRY MIX OF ONE BAG CEMENT PER ONE BAG OF GRANULAR MATERIAL CLASS II. - REPLACE SURFACE ACCORDING TO SPECIFICATIONS AND PLANS -- EXISTING SURFACE -- GRANULAR MATERIAL - GRANUI AR MATERIAL CLASS IIIA -**SECTION A-A** 1. ALL GRANULAR BACKFILL MATERIAL SHALL BE COMPACTED TO 95% OF MAXIMUM UNIT WEIGHT. 2. WATERMAINS CROSSING UNDER SEWERS - WHEN IT IS IMPOSSIBLE TO OBTAIN THE MINIMUM 18-INCH CLEARANCE. REPLACE THE SEWER PIPE (MINIMUM OF 10 FT. ON BOTH SIDES OF WATERMAIN) WITH WATER WORKS PVC GRADE 150PSI PRESSURE TESTED TO ENSURE WATER TIGHTNESS (AWWA C900). 3. "W" - SEE TRENCH DETAILS FOR TRENCH WIDTH. TYPICAL DETAIL AT CROSSING UNDER EXISTING UTILITIES **UTILITY CROSSING**


DETAIL NO. 312333-07

NOT TO SCALE

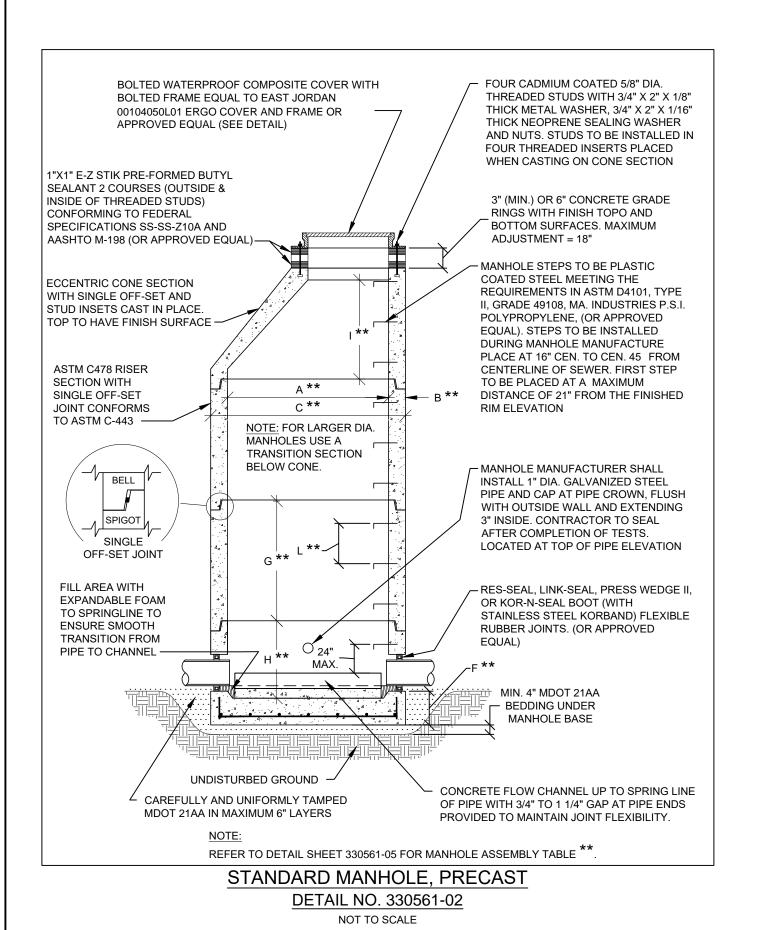

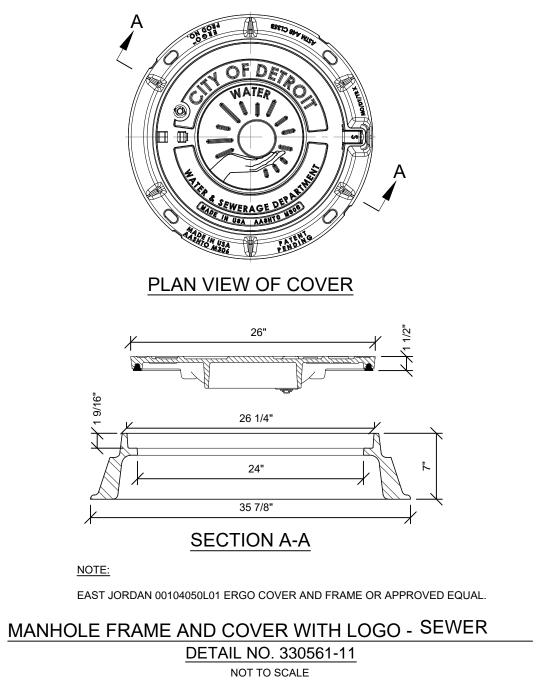

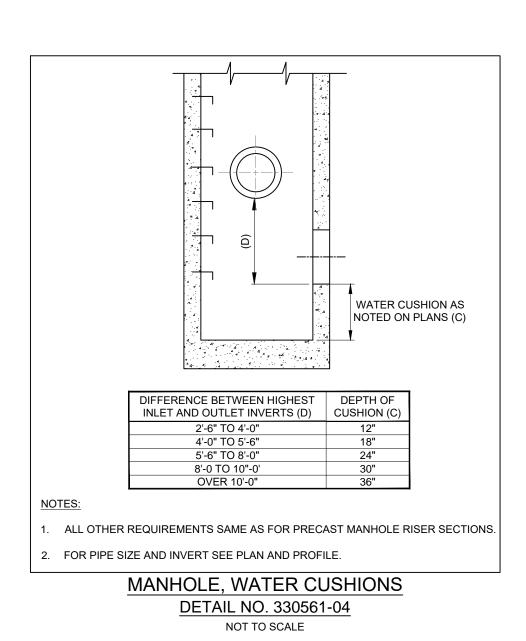

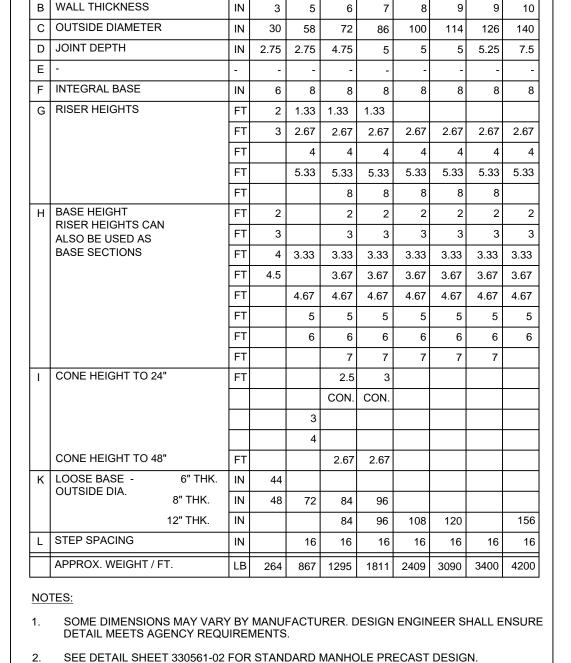

| IN | 24 | 48 | 60 | 72 | 84 | 96 | 108 | 120 |

MANHOLE ASSEMBLY

DETAIL NO. 330561-05

NOT TO SCALE

MANHOLES ASTM C-478

NOTE: SEE STANDARD MANHOLE DRAWING FOR OTHER MANHOLE DETAILS.	SEWER PIPE SIZE	DROP PIPE SIZE	
REMOVABLE PIPE CAP, SLIP-ON FIT (TOP TWO THIRDS OF END REMOVED)	8"-15"	8"	
SECURE IN PLACE WITH 2 #8X1" SHEET METAL SCREWS AT 180	18"-27"	12"	
DEGREES APART. COAT SCREWS	30'-42"	18"	
W/BITUMINOUS SEALER —	48"-54"	24'	
DROP DISTANCE TO BE GREATER THAN 2' BE GREATER THAN 3' BE GREAT	PVC OR SDR 2 RES-SEAL, LIN OR KOR-N-SEA STEEL KORBAI MANHOLE JOIN	K-SEAL, PRESS AL BOOT (WITH ND) FLEXIBLE I	STAINLES
44444			TED DV
	A MINIMUM (CONCRETE) POURED AG GROUND. CA	FO BE SUPPOR OF 6" OF GRAD (SPEC. SEC. 03 AINST UNDISTI ARE SHALL BE	DE "A" 3 30 00) URBED TAKEN
NOTE: — MIN. 4" MDOT 21AA BEDDI	NG NOTTO DAM	IAGE THE DRO	P PIPE
—UNDISTURBED GROUND			
DROP PIPE LOCATION SHALL NOT INTERFERE WITH MANHOLE STEPS, O			

MANHOLE, EXTERIOR DROP

DETAIL NO. 330561-06


NOT TO SCALE

F					DESIGNED BY:	SEAL / STAMP
E						
D					DRAWN BY:	
С					CHECKED BY:	
В					CHECKED BY:	
Α	ISSUED FOR PROCUREMENT			4/1/2020	MANAGER:	
	DESCRIPTIONS / REVISIONS	CHK'D	APPR.	DATE		

DETROIT WATER AND SEWERAGE DEPARTMENT CAPITAL IMPROVEMENT PROGRAM


STANDARD DETAILS SEWER


	•											MDEQ SRF Project No. 5688-01
			C	CITY	OF	DE ⁻	TRO	ΙΤ				REF. No. CS-1812
CITY OF DETROIT	WAT	ER.	ANE				SE D		ARTI	MEN	1T	DWS-916
DETROIT Water & Sewerage				LIVOI	11000	1110	7111010	, i V				FILE No.
Department												DRAWING No.
SECTION MAP	ТО	WN		RANG	E	5	SECTIO	N	POR	TION C	ODE	0D 4
		-	-	-	-	-	-	-	-	-	-	SD-1

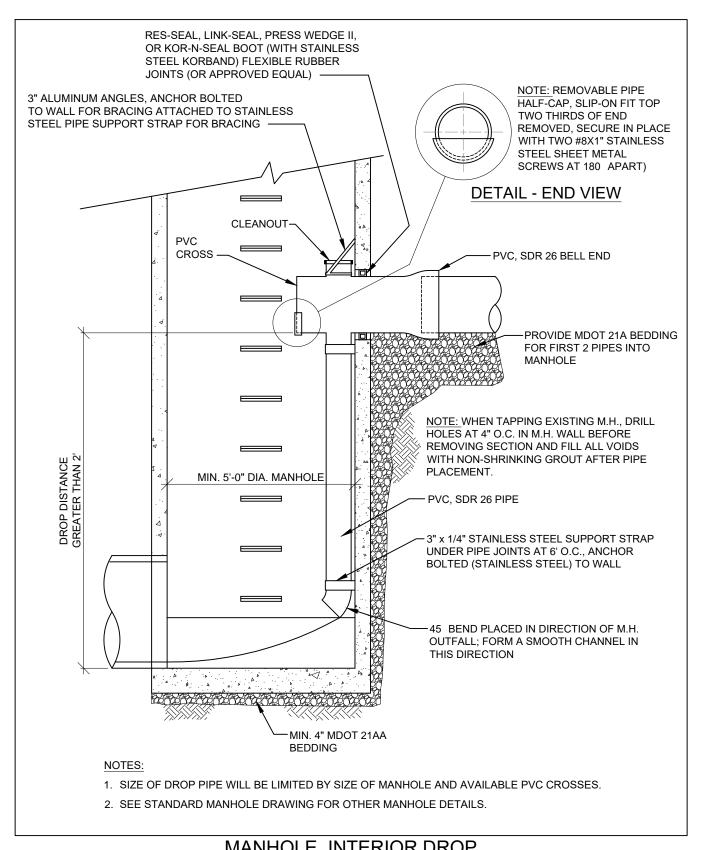


DETAIL NO. 330561-07

NOT TO SCALE

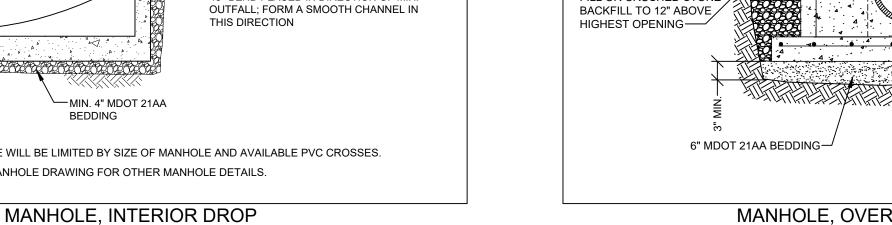


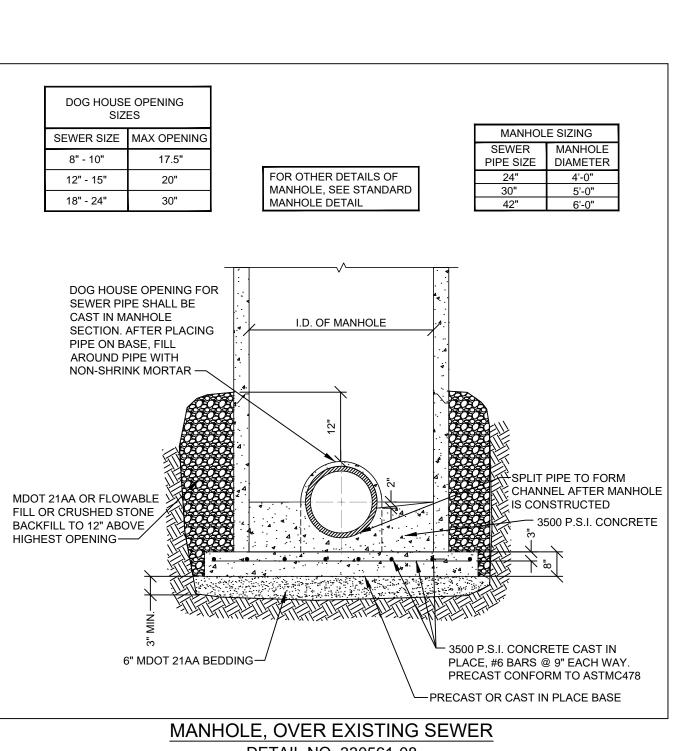

DETAIL NO. 330561-08 NOT TO SCALE

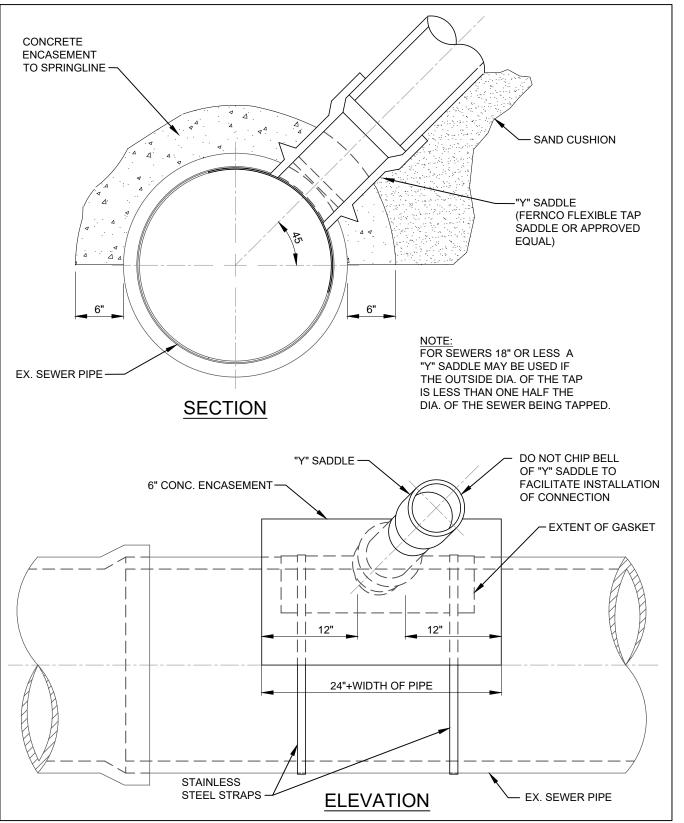



CONNECTION, SADDLE, TO LATERAL SEWER DETAIL NO. 333111-01 NOT TO SCALE

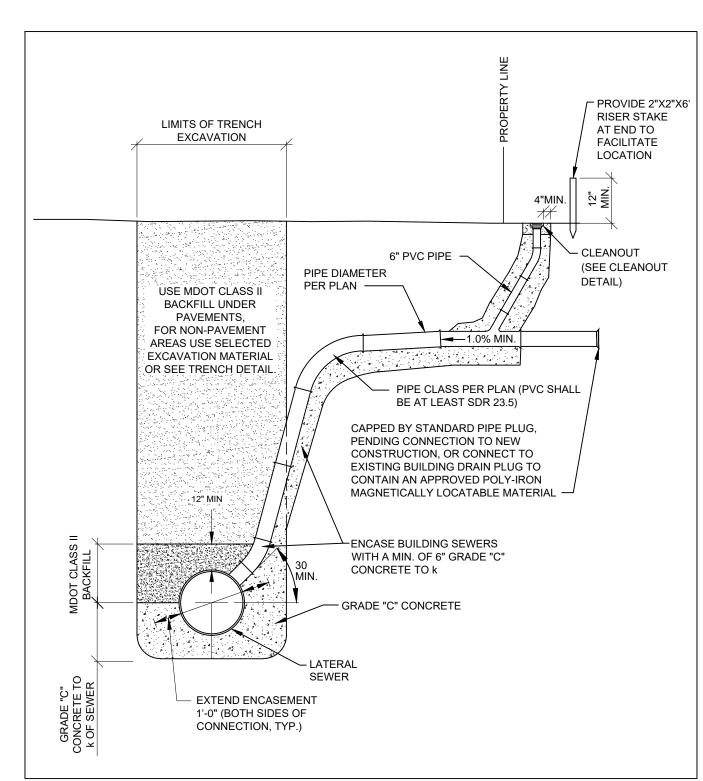


WYE, CONNECTION AND EXTENSION DETAIL NO. 333111-02

NOT TO SCALE

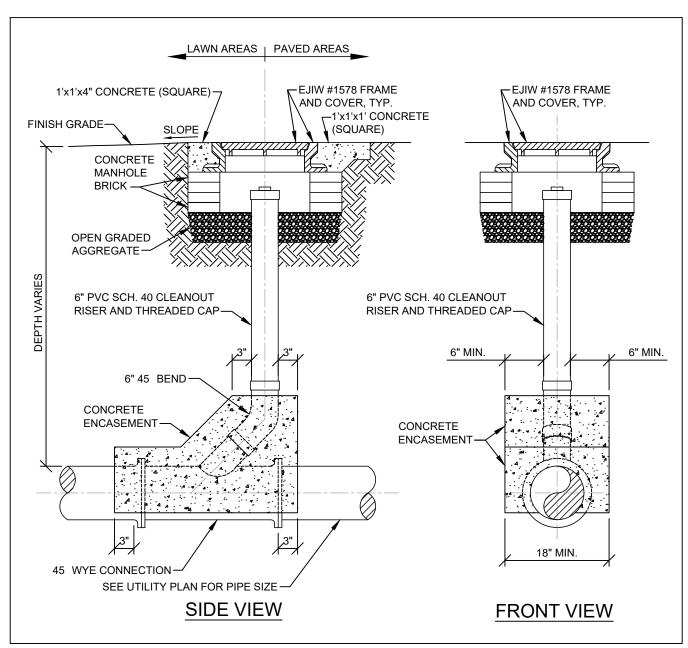

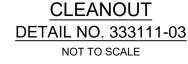

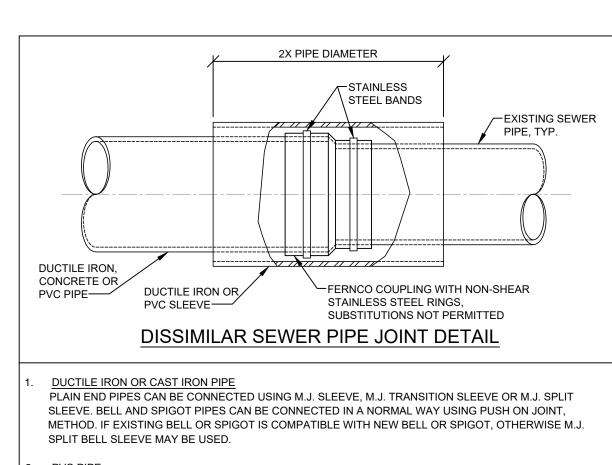

PLAIN END PVC PIPES CAN BE CONNECTED USING ELASTOMERIC-GASKET PVC COUPLINGS. WHERE PVC COUPLINGS ARE NOT SUITABLE DUCTILE IRON M.J. SLEEVES MAY BE USED. IF MISSION BAND SEAL COUPLING IS USED UNDER AN ABNORMAL SITUATION, A DUCTILE IRON OR PVC SLEEVE PROTECTION


WHERE NORMAL BELL AND SPIGOT GASKETED JOINT IS NOT PRACTICABLE, MISSION BAND SEAL COUPLING WITH DUCTILE IRON OR PVC SLEEVE PROTECTION SHALL BE USED TO COMPLETE THE JOINT. SIMILAR SEWER PIPE JOINT DETAIL NOTES

> SEWER PIPE JOINT DETAIL DETAIL NO. 333111-06

F					DESIGNED BY:	SEAL /
E						
D					DRAWN BY:	
С					CHECKED BY:	
В					CHECKED BY.	
Α	ISSUED FOR PROCUREMENT			4/1/2020	MANAGER:	
	DESCRIPTIONS / REVISIONS	CHK'D	APPR.	DATE		

DETROIT WATER AND SEWERAGE DEPARTMENT CAPITAL IMPROVEMENT PROGRAM

STANDARD DETAILS **SEWER**

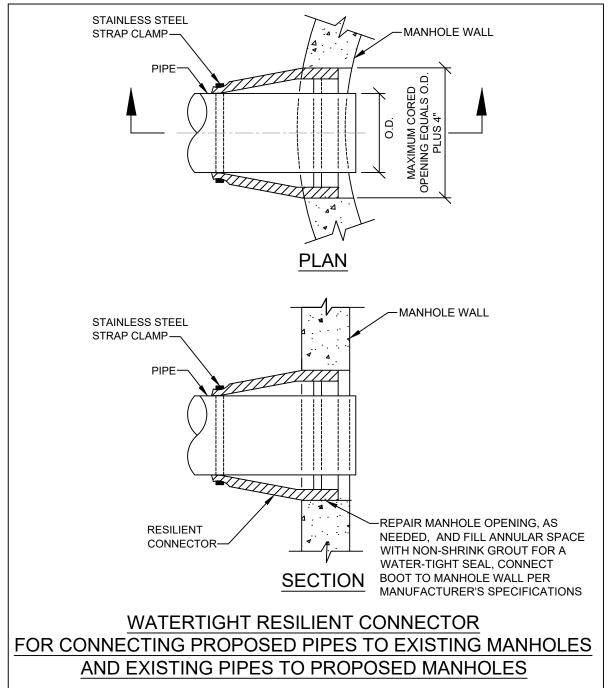


SEWER PIPE CONNECTION WITH MANHOLE **DETAIL NO. 333111-07**

CITY OF DETROIT	WATER A	AND SEWER	DETROIT RAGE DEPA	ARTMENT	MDEQ SRF Project No. REF. No. DWSD CONTRACT No. FILE No.
Water & Sewerage Department					DRAWING No.
SECTION MAP	TOWN	RANGE	SECTION	PORTION CODE	SD-2

5688-01

CS-1812

DWS-916

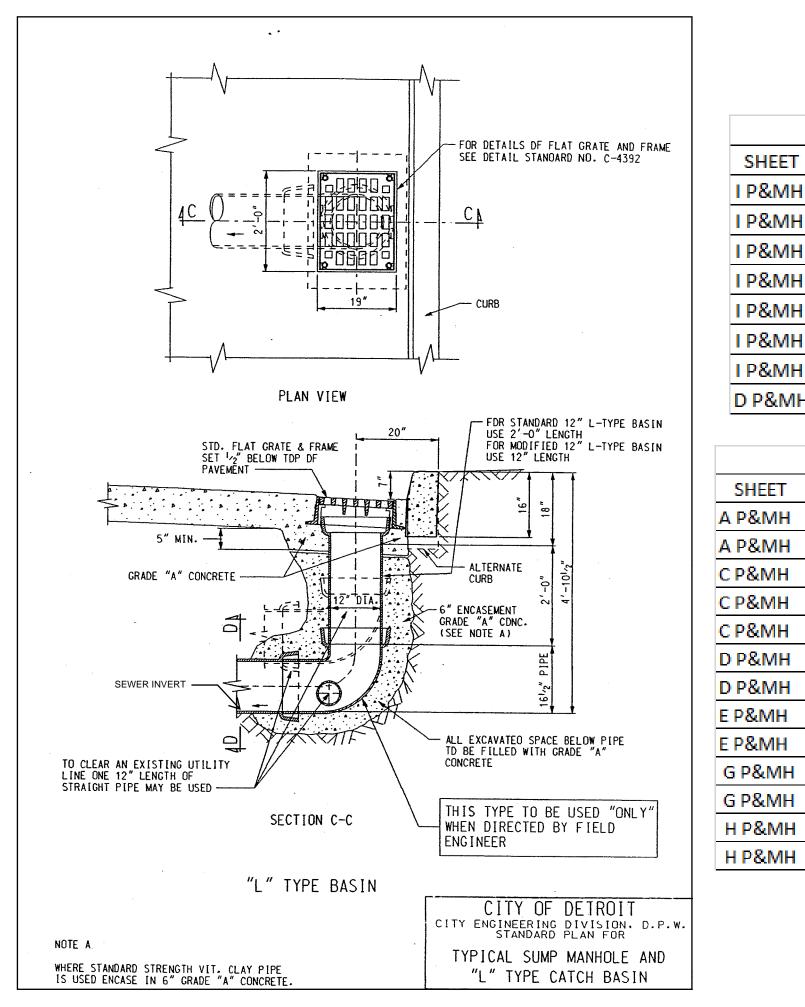

	NEW MANHOLE STRUCTURE DATA TABLE											
SHEET	MANHOLE ID	SEWER INVERT	DEPTH OF STRUCTURE	MANHOLE DIAMETER	MANHOLE TYPE							
A P&MH	ND21106C		REFER TO SHEET S-11									
A P&MH	ND8513AA		REFER TO SHEET S-:	STANDARD MANHOLE								
C P&MH	ND18629	7.3 FT	7.3 FT 7.8 FT 48 IN									
C P&MH	ND57431	9.2 FT	9.7 FT	48 IN	STANDARD MANHOLE							
C P&MH	ND14817AU	6.9 FT	7.4 FT	48 IN	STANDARD MANHOLE							
D P&MH	ND27596	5.3 FT	5.8 FT	48 IN	STANDARD MANHOLE							
D P&MH	ND36750	11.8 FT	12.4 FT	48 IN	STANDARD MANHOLE							
E P&MH	ND24965	5.8 FT	6.4 FT	48 IN	STANDARD MANHOLE							
E P&MH	ND24964	8.7 FT	9.2 FT	48 IN	STANDARD MANHOLE							

REFER TO SHEET S-9

REFER TO SHEET S-1

REFER TO SHEET S-1

26 FT

NEW CATCH BASIN STRUCTURE DATA TABLE

4.6 FT

5.1 FT

4.1 FT

5.7 FT

5.2 FT

7.7 FT

5.5 FT

5.0 FT

25.5 FT

SHEET

LP&MH

LP&MH

LP&MH

LP&MH

LP&MH

LP&MH

I P&MH

D P&MH

н Р&МН

ND3761

ND3760

ND21987

ND8518

ND8517

ND26441AU

ND29173

ND5977

ND20516

ND36756

ND12479

MH24703

MANHOLE ID | SEWER INVERT | DEPTH OF STRUCTURE | MANHOLE DIAMETER

4.6 FT

5.1 FT

4.1 FT

5.7 FT

5.2 FT

7.7 FT

5.5 FT

5.0 FT

12 IN

10 FT

STANDARD MANHOLE

Refer to SD-3 for Detail.

STANDARD MANHOLE


STANDARD MANHOLE

1. CONTRACTOR TO REMOVE EXISITING "Y" CATCH BASIN FOR LINING PURPOSES. 2. CONTRACTOR TO INSTALL NEW CATCH BAIN.

NOT TO SCALE

EXISTING WWMH000005 3348 ND36756 NEW MANHOLE EXISTING ND28390 EXISTING WWMH000039 932 EXISTING RCP SEWER	Dalaware St Dela VCP SEWER EXISTING WWMH000005 3348A EXISTING ND36756	XISTING 18" CP SEWER NORTH
ND28390	EXISTING WWMH000005 3348 ND3 MAN	6756 NEW HOLE
	EXISTING 21" RCP SEWER	28390

ND 36756 MANHOLE DETAIL (PLAN)

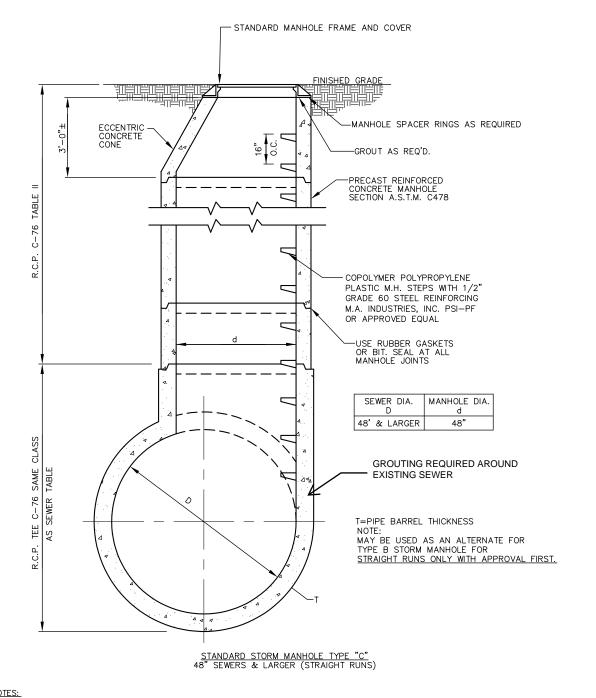

NOTES:

1. WHERE DESIGNATED OR AS NEEDED CASTING LID SHALL BE OF NON-ROCKING TYPE.

2. WHERE DESIGNATED OR AS NEEDED PROVIDE FLOTATION COLLAR.

3. MANHOLE DIAMETER IS SHOWN AS MINIMUM AND MAY INCREASE DUE TO LOCATION OF PIPES.

4. THIS TYPE "C" STORM MANHOLE SHALL BE USED FOR STORM SEWERS 48" IN DIAMETER AND LARGER AND IN STRAIGHT ROWS. ND 36756 MANHOLE DETAIL (PROFILE)


NOT TO SCALE

DESIGNED BY: SEAL / STAMP DRAWN BY: D CHECKED BY: ISSUED FOR PROCUREMENT 4/1/2020 MANAGER: DESCRIPTIONS / REVISIONS | CHK'D | APPR. | DATE

DETROIT WATER AND SEWERAGE DEPARTMENT CAPITAL IMPROVEMENT PROGRAM


> STANDARD DETAILS SEWER

	~				MDEQ SRF Project No. 5688-01
		CITY OF	DETROIT		CS-1812
CITY OF DETROIT	WATER	DWS-916			
DETROIT Water & Sewerage		LINOHNELIX	ING DIVISION		FILE No.
Department					DRAWING No.
SECTION MAP	TOWN	RANGE	SECTION	PORTION CODE	SD-3

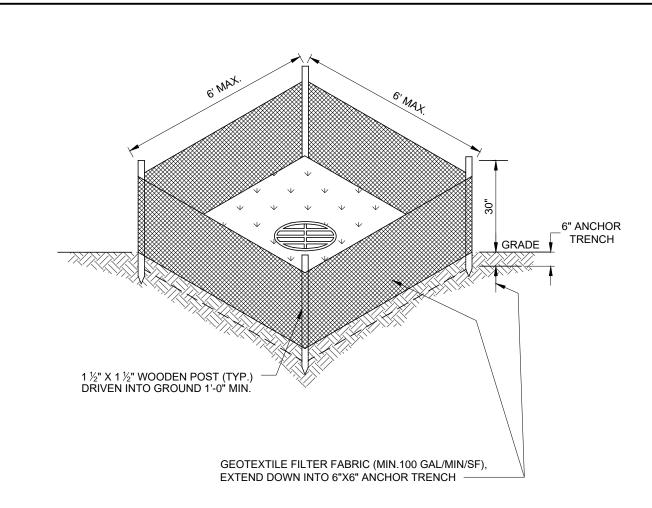

GENERAL NOTES

- 1. REFER TO SILT FENCE DETAIL 015713-02 FOR INSTALLATION PROCEDURES.
- 2. WEEKLY INSPECTION AND MAINTENANCE MUST BE PROVIDED TO INSURE THAT THE DRAIN GUARD OPERATES EFFICIENTLY.
- 3. SOD INTERIOR OF DRAIN GUARD UNLESS INDICATED OTHERWISE.
- 4. REMOVE AND DISPOSE OF ACCUMULATED SEDIMENT AS NECESSARY, PER SPECIFICATION SECTION 015713.

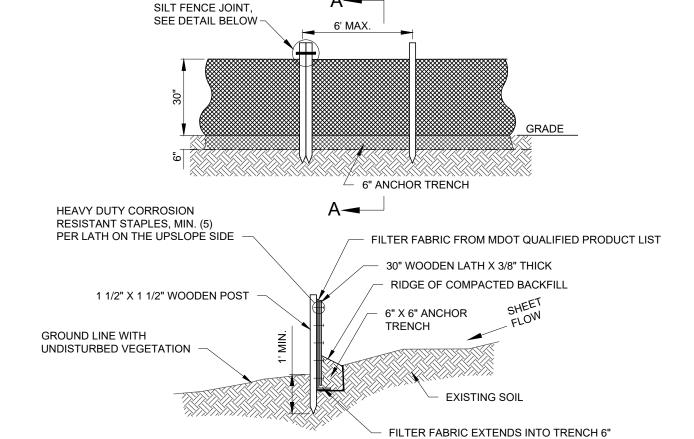

SECTION A-A


SILT FENCE MATERIAL SHALL MEET THE

REQUIREMENTS IN SECTION 910.04 AND


SPECIFICATIONS FOR CONSTRUCTION.

TABLE 910-1 IN MDOT STANDARD

4. BASE TO BE AT LEAST 2 X HEIGHT.

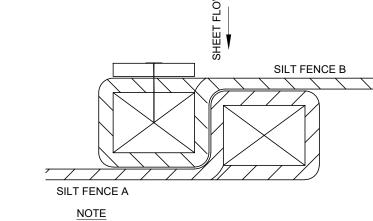


FABRIC TO BE WRAPPED AROUND FENCE POST. SILT FENCE JOINT

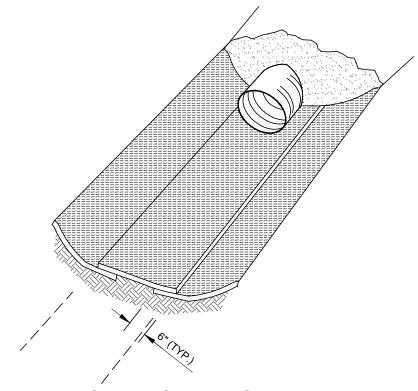


TYPICAL DITCH LINING


GENERAL NOTES: (FROM MDOT DRAINAGE MANUAL)

- 1. EROSION CONTROL BLANKETS PROTECT DENUDED SURFACES AGAINST WIND AND WATER EROSION, AND STABILIZE SOIL SURFACES WHILE VEGETATION IS BEING ESTABLISHED.
- 2. BLANKETS ARE PLACED IN DITCHES AND ON STEEP SLOPES USUALLY WITH RIP-RAP WHERE INDICATED ON THE DRAWINGS OR AS DIRECTED BY THE ENGINEER.
- 3. EXTEND BLANKETS UNDER PIPE THREE (3) INCHES. ANCHOR BLANKETS IN ACCORDANCE WITH MDOT STANDARD SPECIFICATIONS FOR CONSTRUCTION, SECTION 816 TURF ESTABLISHMENT.
- 4. PROVIDE MULCH BLANKETS/HIGH VELOCITY BLANKETS SELECTED FROM THE MDOT QUALIFIED PRODUCTS LIST.
- 5. USE MULCH BLANKETS WITH NETTING ON TOP SIDE ON SLOPES FLATTER THAN 1:2.
- 6. USE HIGH VELOCITY BLANKETS WITH NETTING ON TOP AND FIBERS IN CONTACT WITH SOIL ON SLOPES 1:2 OR
- 7. USE MULCH BLANKET AS PERMANENT STABILIZATION TREATMENT FOR DITCHES WITH SLOPES BETWEEN 0.5% AND
- 8. USE HIGH VELOCITY MULCH BLANKET AS PERMANENT STABILIZATION TREATMENT FOR DITCHES WITH SLOPES BETWEEN 1.5% AND 3.0%.
- 9. USE ANCHOR TRENCH AT TOP OF SLOPE (SEE DETAIL 01014.02, SECTION A, FOR DETAILS ON TRENCH).

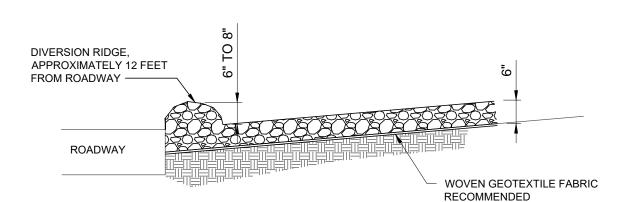


CROSS-SECTION A-A

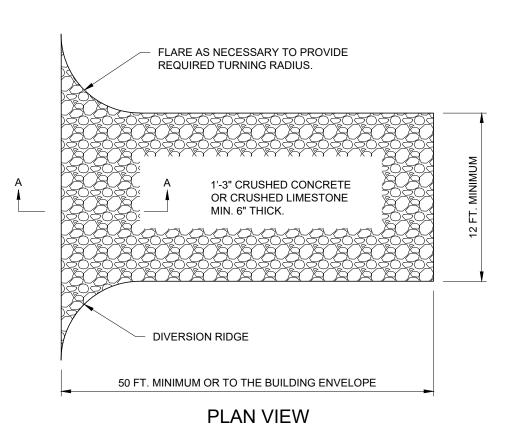

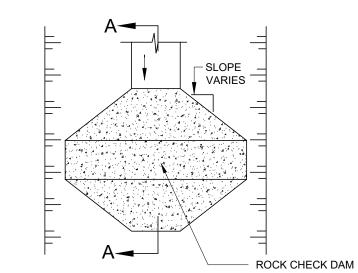


PLAN VIEW

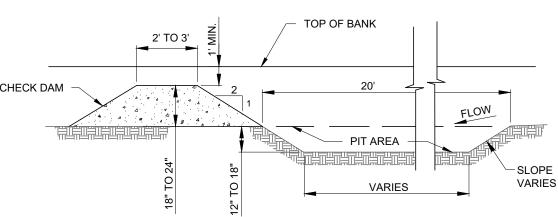

SECTION A-A


GENERAL NOTES

- 1. THE DITCH CROSS-SECTION SHOULD ONLY BE PARTIALLY BLOCKED, IN ORDER TO MINIMIZE THE LOSS IN DITCH FLOW CAPACITY.
- 2. CHECK DAM SHOULD BE REMOVED AND THE SEDIMENT PIT FILLED AS SOON AS THE UPSTREAM AREAS CONTRIBUTING TO IT ARE STABILIZED. THIS WILL ALLOW THE DITCH TO FUNCTION AS DESIGNED
- 3. WEEKLY INSPECTION AND MAINTENANCE MUST BE PROVIDED TO INSURE THAT THE DITCH SEDIMENT TRAP
- 4. THE PERMISSION OF THE GOVERNMENTAL AGENCY, RESPONSIBLE FOR THE MAINTENANCE OF THE DITCH, MUST BE RECEIVED BEFORE A DITCH SEDIMENT TRAP IS INSTALLED
- 5. SEE STANDARD DETAIL 015713-06 OR DWSD FOR CHECK DAM SPECIFICATIONS FOR CONSTRUCTION.

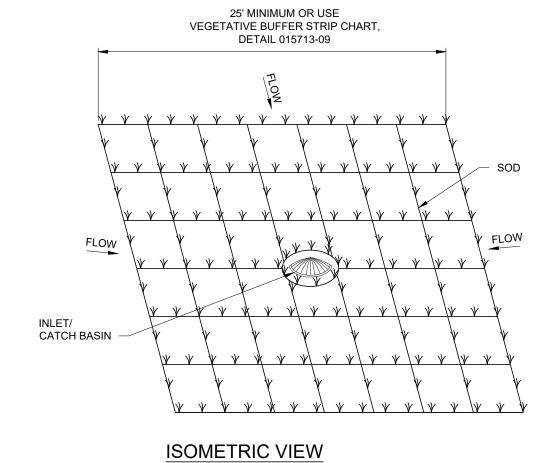


1. SOD INLET FILTERS ARE PADS OF SOD PLACED AROUND A STORM DRAIN INLET OR CATCH BASIN.

- 2. SOD INLET FILTERS ARE INSTALLED TO SLOW THE FLOW OF WATER INTO AN INLET OR CATCH BASIN AND FILTER OUT SEDIMENT IN THE PROCESS.
- 3. SOD INLET FILTERS SHOULD ONLY BE USED TO HANDLE LIGHT CONCENTRATIONS OF SEDIMENT. THEY ARE
- BEST USE AFTER FINAL GRADING IS COMPLETE AND DURING THE ESTABLISHED OF A VEGETATIVE COVER.

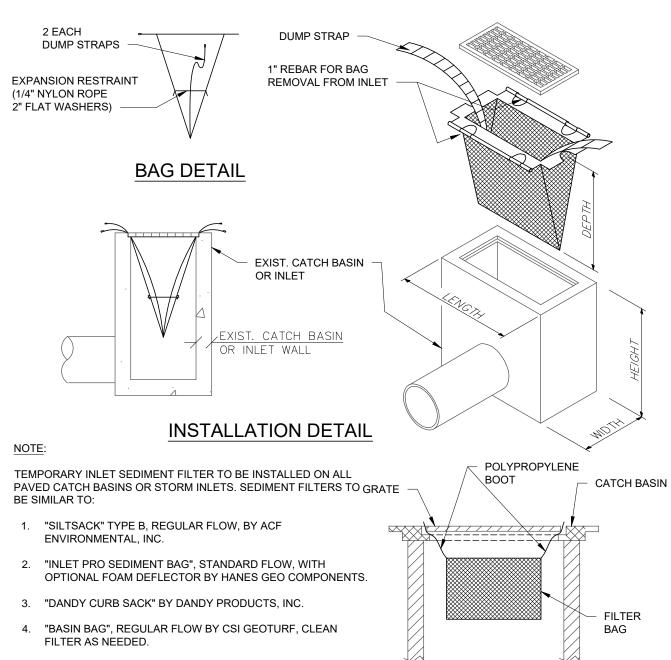

GENERAL NOTES

- CONTRACTOR SHALL OBTAIN PERMISSION OF THE ENFORCING ROAD AGENCY BEFORE THIS TYPE OF CONTROL IS CONSTRUCTED IN THE ROAD RIGHT-OF-WAY.
- CONTRACTOR SHALL KEEP CURBS & GUTTER INLET FILTERS (AFTER PAVING) IN PLACE UNTIL ALL AREAS CONTRIBUTING TO THEM ARE STABILIZED WITH VEGETATION.
- CONTRACTOR SHALL PERFORM WEEKLY INSPECTION AND MAINTENANCE TO ENSURE THAT THE CURB & GUTTER INLET FILTER (AFTER PAVING) OPERATES EFFICIENTLY.

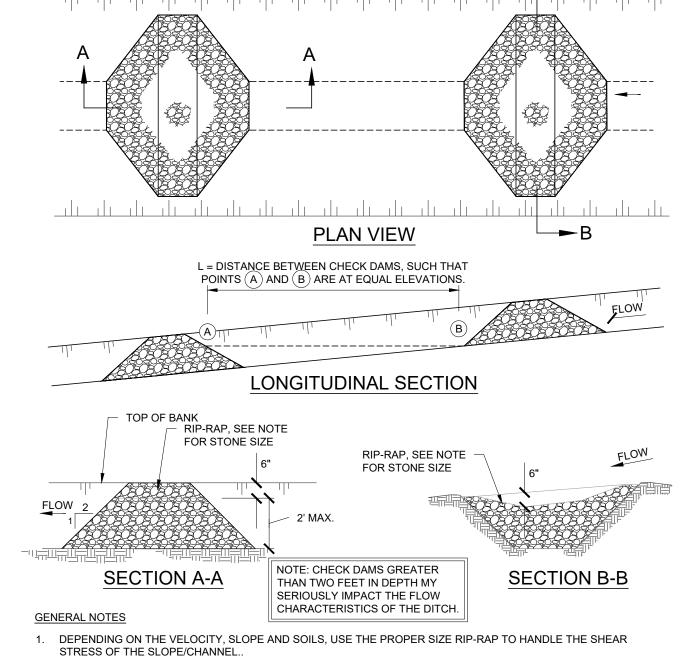

2. FOR SLOPE AND/OR CHANNEL PROTECTION, SEE THE MDOT CONSTRUCTION SITE SOIL EROSION PREVENTION

3. RIP-RAP SIZE SHOULD BE 2-4 INCHES FOR DITCH GRADES LESS THAN 2% AND 3-12 INCHES FOR DITCH GRADES

SEAL / STAMP DESIGNED BY: DRAWN BY: CHECKED BY: ISSUED FOR PROCUREMENT 4/1/2020 MANAGER: DESCRIPTIONS / REVISIONS | CHK'D | APPR. | DATE

DETROIT WATER AND SEWERAGE DEPARTMENT CAPITAL IMPROVEMENT PROGRAM

STANDARD DETAILS SOIL EROSION AND SEDIMENTATION



SECTION MAP

CITY OF DETROIT WATER AND SEWERAGE DEPARTMENT


ENGINEERING DIVISION


CS-1812 DWSD CONTRACT No DWS-916 FILE No. DRAWING No. SD-4

5688-01

MDEQ SRF Project No.

RANGE SECTION PORTION CODE

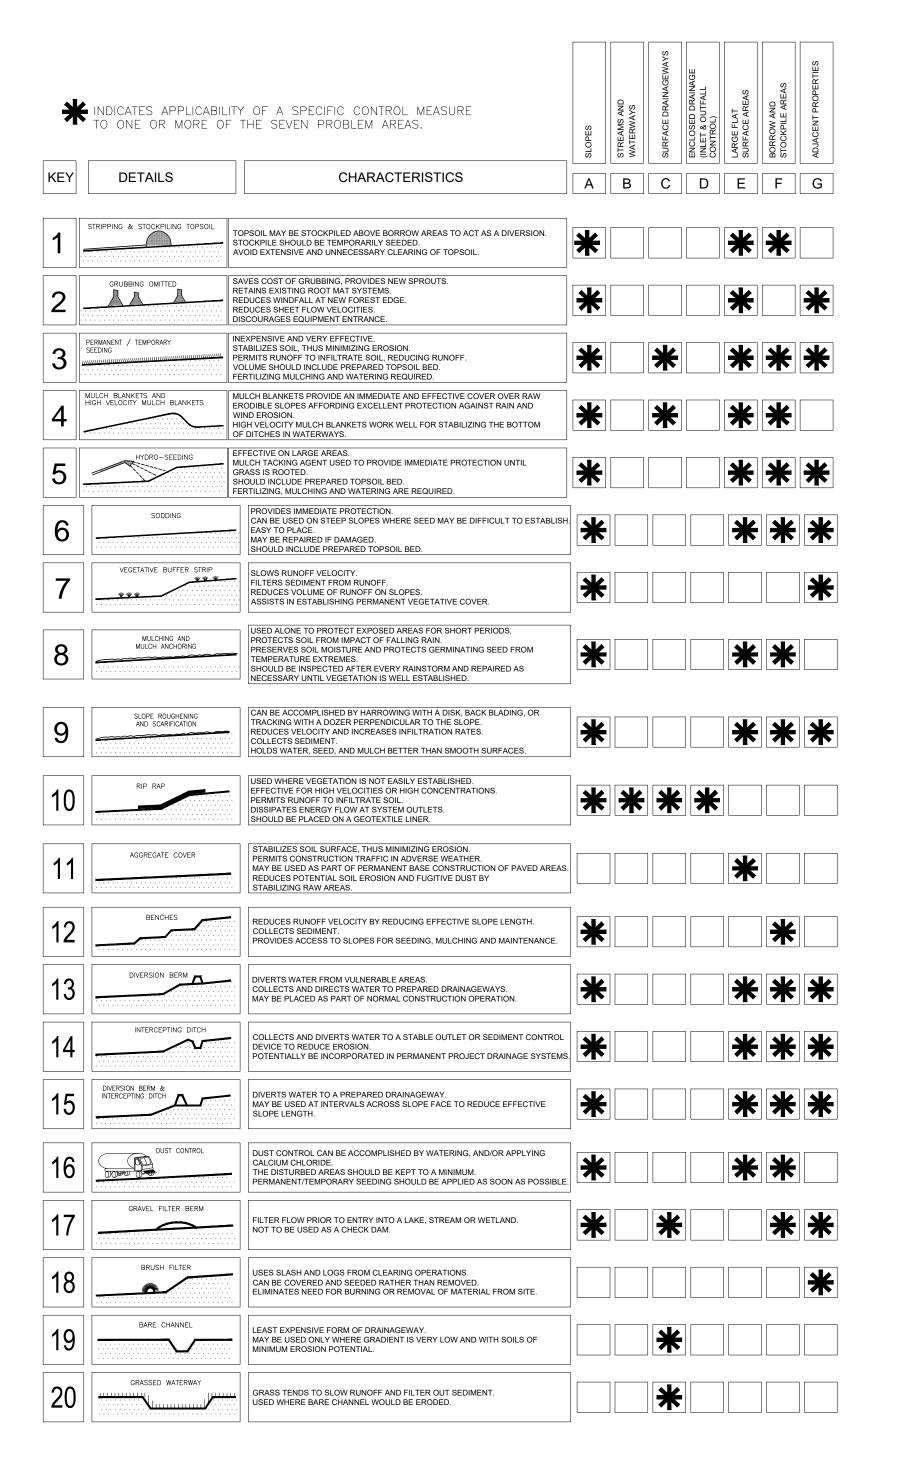

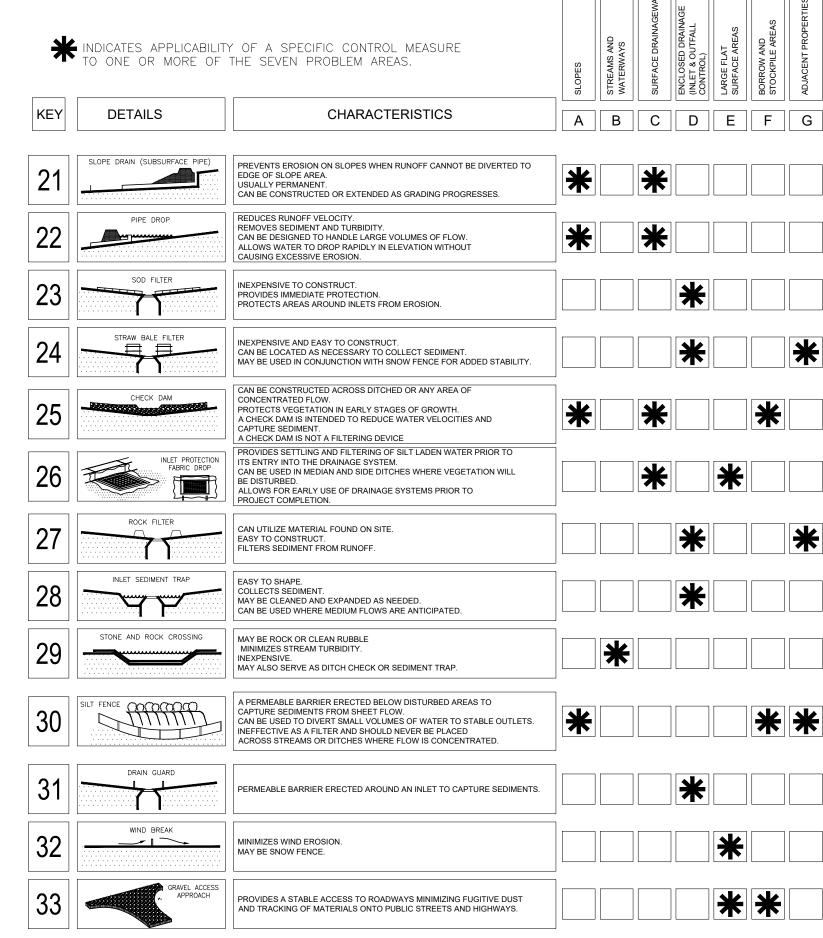

SOIL EROSION AND SEDIMENTATION CONTROL (TEMPORARY FACILITIES)

THE CONTRACTOR SHALL CONSTRUCT THIS PROJECT IN COMPLIANCE WITH PART 91 OF ACT NO. 451 OF 1994, NATURAL RESOURCES AND ENVIRONMENTAL PROTECTION ACT, OF THE MICHIGAN COMPILED LAWS ENTITLED "SOIL EROSION AND SEDIMENTATION CONTROL" UNDER THE CONTROL OF THE LOCAL PERMIT AGENCY CHARGED WITH ADMINISTERING THE PROVISIONS OF THIS ACT. THE CONTRACTOR SHALL FOLLOW THE PROCEDURES DELINEATED BELOW AND CONSTRUCT AND MAINTAIN THE FACILITIES SHOWN ON THE DRAWINGS TO CONTROL WATER AND WIND EROSION DURING CONSTRUCTION OF THIS PROJECT.

ALL DISTURBED SURFACE AREA (INCLUDING UTILITY TRENCHES) SHALL BE TEMPORARILY GRADED AND/OR DITCHED TO DIRECT ALL WATER RUNOFF FROM SUCH AREAS TO SEDIMENTATION CONTROL DEVICES WHICH WILL PREVENT WATER CARRYING ERODED SOIL FROM ENTERING A WATERCOURSE, SEWER, OR ADJACENT LANDS. SUCH SEDIMENTATION CONTROL DEVICES SHALL INCLUDE BUT NOT BE LIMITED TO PROTECTIVE DITCHES, SEDIMENT TRAPS, SEDIMENT FILTERS, DITCH TRAPS, PIPE BARRIERS, AND FILTERS AS DETAILED AND REQUIRED AND WHERE INDICATED ON THE DRAWINGS. AFTER THE PROJECT WORK HAS BEEN COMPLETED, INSPECTED, AND APPROVED, THE CONTRACTOR SHALL REMOVE ALL SEDIMENTATION CONTROL DEVICES, MATERIAL, AND THEIR COLLECTED SILT AND DEBRIS AND RESTORE THE AREA IN ACCORDANCE WITH THE DRAWINGS.

IN ROADWAY AREAS TEMPORARY AGGREGATE SURFACING SHALL BE PLACED IMMEDIATELY AFTER THE BACKFILLING OPERATION HAS BEEN COMPLETED. POSITIVE DUST CONTROL MEASURES SHALL BE TAKEN AT ALL TIMES.

PERMANENT STABILIZATION SHALL BE COMPLETED WITHIN 5 DAYS OF FINAL EARTH CHANGE. FINAL CLEANUP AND RESTORATION WILL CONSIST OF FINAL GRADING, TOPSOILING, SEEDING AND MULCHING AND/OR SODDING OF ALL DISTURBED AREAS OF THE PROJECT.

IF SEASONAL CONDITIONS PREVENT FINAL CLEANING AND RESTORATION, THE CONTRACTOR SHALL PROCEED WITH TEMPORARY STABILIZATION OF THE DISTURBED AREA. TEMPORARY STABILIZATION SHALL CONSIST OF ROUGH GRADING THE DISTURBED AREA IN ACCORDANCE WITH THESE SPECIFICATIONS. TEMPORARY STABILIZATION MATERIALS SHALL BE REMOVED AND DISPOSED OF AND FINAL CLEANUP AND RESTORATION SHALL BE COMPLETED NOT LATER THAN 5 DAYS AFTER SEASONAL CONDITIONS ALLOW PERFORMANCE OF THE REQUIRED WORK.

SOIL EROSION AND SEDIMENTATION CONTROL MAINTENANCE NOTES

THE CONTRACTOR SHALL INSPECT SOIL EROSION AND SEDIMENTATION CONTROL DEVICES WEEKLY AND WITHIN 24 HOURS OF A SIGNIFICANT RAIN EVENT. THE CONTRACTOR SHALL BE RESPONSIBLE FOR MAINTAINING THE SOIL EROSION AND SEDIMENTATION CONTROL

MAINTENANCE INCLUDES ALL WORK NECESSARY FOR PROPER OPERATION OF THE DEVICES. DEVICES WHICH CAN NOT BE REPAIRED MAY NEED TO BE REPLACED. MAINTENANCE OF THE DEVICES SHALL BE PERFORMED WITHIN 24 HOURS OF INSPECTION.


SEDIMENT SHALL BE REMOVED AS NECESSARY TO MAINTAIN THE EFFECTIVENESS OF SOIL

SEDIMENT DEPOSITED ALONG SILT FENCE SHALL BE REMOVED WHEN IT REACHES 1/3 TO 1/2 THE HEIGHT OF THE FENCE.


TURF ESTABLISHMENT MEASURES SHALL BE MAINTAINED AS WOULD ANY OTHER DEVICES PRIOR TO ESTABLISHMENT OF PERMANENT TURF.

ALL MUD, DIRT AND DEBRIS TRACKED ONTO EXISTING ROADS FROM THIS SITE SHALL BE

CONTRACTOR SHALL ENSURE THAT SOIL EROSION AND SEDIMENTATION CONTROL MEASURES PROTECT AGAINST LOSS OF SOIL BY THE ACTION OF WATER, ICE, GRAVITY OR

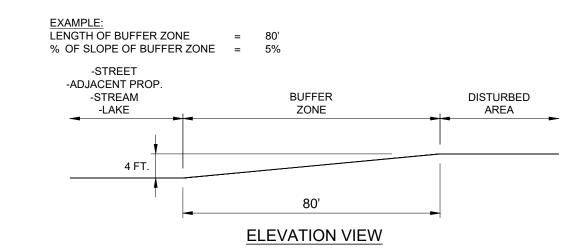

THE GRAPH SHOWN BELOW IS USED TO DETERMINE THE ADEQUACY OF AN EXISTING VEGETATIVE BUFFER ZONE FOR USE AS A SEDIMENT FILTER. THIS GRAPH IS ONLY APPLICABLE IF THE VEGETATION IS 90% DENSE AND AT LEAST 1" IN LENGTH OVER EVERY SQUARE FOOT OF DISTURBED SOIL. AN AREA COVERED WITH WEEDS OR BUSHES AND TREES, WITHOUT A GOOD GROUND COVER, IS NOT ACCEPTABLE.

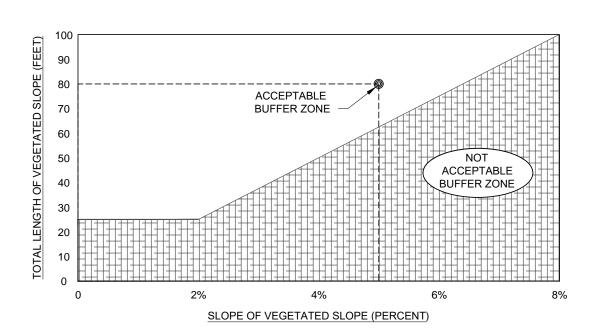

VEGETATIVE BUFFER STRIP CHART

SUMMARY OF BASIC PRINCIPLES

- 1. KEEP DISTURBED AREA AS SMALL AS POSSIBLE.
- 2. STABILIZE AND/OR PROTECT DISTURBED AREAS AS SOON AS POSSIBLE.
- 3. KEEP STORM WATER RUNOFF VELOCITIES LOW.
- 4. RETAIN SEDIMENT WITHIN IMMEDIATE CONSTRUCTION AREA.

THE PURPOSE OF THIS PLAN IS TO SPECIFY METHODS FOR TEMPORARY EROSION THE SPECIFICATIONS AND SHOWN ON THESE STANDARD DETAILS PLANS BE STRICTLY ADHERED TO. IT SHALL BE THE RESPONSIBILITY OF THE CONTRACTOR TO ASSURE THAT CONSTRUCTION PROCEDURES UNDERTAKEN BE IN CONFORMANCE WITH THE STATE OF MICHIGAN ACT 451 OF 1994 PART 91, SOIL EROSION AND SEDIMENTATION

ALL SOIL EROSION AND SEDIMENTATION CONTROL DEVICES SHALL BE REGULARLY MAINTAINED BY THE CONTRACTOR THROUGHOUT THE DURATION OF THE PROJECT. COLLECTED SILT AND SEDIMENTATION SHALL BE REMOVED PERIODICALLY TO MAINTAIN THE EFFECTIVENESS OF THE SILT TRAPS OR SEDIMENTATION CONTROL DEVICES. WHERE REQUIRED, THE CONTRACTOR SHALL REPLACE FILTER MATERIALS WHICH HAVE BECOME INEFFECTIVE DUE TO CONTAMINATION OR PHYSICAL DETERIORATION.

IF POSSIBLE, NO GRUBBING SHOULD BE DONE WITHIN 30' OF AN ACTIVE WATERCOURSE.

AGGREGATES PLACED IN STREAMS SHOULD CONTAIN A MINIMUM OF FINES. AS A GENERAL RULE FOR DAMS IN SMALL STREAMS, AT LEAST 50 STONE SHOULD BE 6" DIAMETER OR LARGER. 3" OR LARGER STONE SHALL BE USED FOR LINING STREAM BOTTOMS WHERE LINING IS REQUIRED.

ALL TEMPORARY EROSION CONTROL FACILITIES SHOULD BE REMOVED BY THE CONTRACTOR AT THE COMPLETION OF CONSTRUCTION UNLESS ORDERED BY THE ENGINEER TO BE LEFT IN PLACE. CARE SHALL BE TAKEN DURING REMOVAL TO MINIMIZE SILTATION IN NEARBY DRAINAGE COURSES.

SURFACE DISRUPTION IN ADVANCE OF CONSTRUCTION INCLUDING CLEARING, GRADING OR SIGNIFICANT SOD REMOVAL SHALL BE LIMITED AS FOLLOWS, UNLESS PERMISSION IS OTHERWISE OBTAINED FROM THE GOVERNING AGENCY.

- A. WET WEATHER SEASON (MARCH, APRIL, MAY) 5 DAYS PRIOR TO BEGINNING ANY EARTH CHANGE ACTIVITY.
- B. DRY WEATHER SEASON (JUNE, JULY, AUGUST, SEPTEMBER, OCTOBER, NOVEMBER) -10 DAYS PRIOR TO BEGINNING ANY EARTH CHANGE ACTIVITY.

MDEQ SRF Project No.


C. COLD WEATHER SEASON (DECEMBER, JANUARY, FEBRUARY) - 15 DAYS PRIOR TO REGINNING ANY EARTH CHANGE ACTIVITY


	BEOMNING ANT EARTH CHANGE ACTIVITY.


EROSION AND SEDIMENTATION CONTROL DEVICES.


PROMPTLY REMOVED BY THE CONTRACTOR.


DESIGNED BY SEAL / STAMP DETROIT WATER AND SEWERAGE DEPARTMENT 5688-01 REF. No. CAPITAL IMPROVEMENT PROGRAM CS-1812 DRAWN BY: CITY OF DETROIT D DWSD CONTRACT No WATER AND SEWERAGE DEPARTMENT DWS-916 DETROIT C ENGINEERING DIVISION CHECKED BY: FILE No. В STANDARD DETAILS **Water & Sewerage** ISSUED FOR PROCUREMENT 4/1/2020 SOIL EROSION AND SEDIMENTATION DRAWING No. Department MANAGER: SECTION MAP RANGE SECTION PORTION CODE SD-5 DESCRIPTIONS / REVISIONS | CHK'D | APPR. | DATE

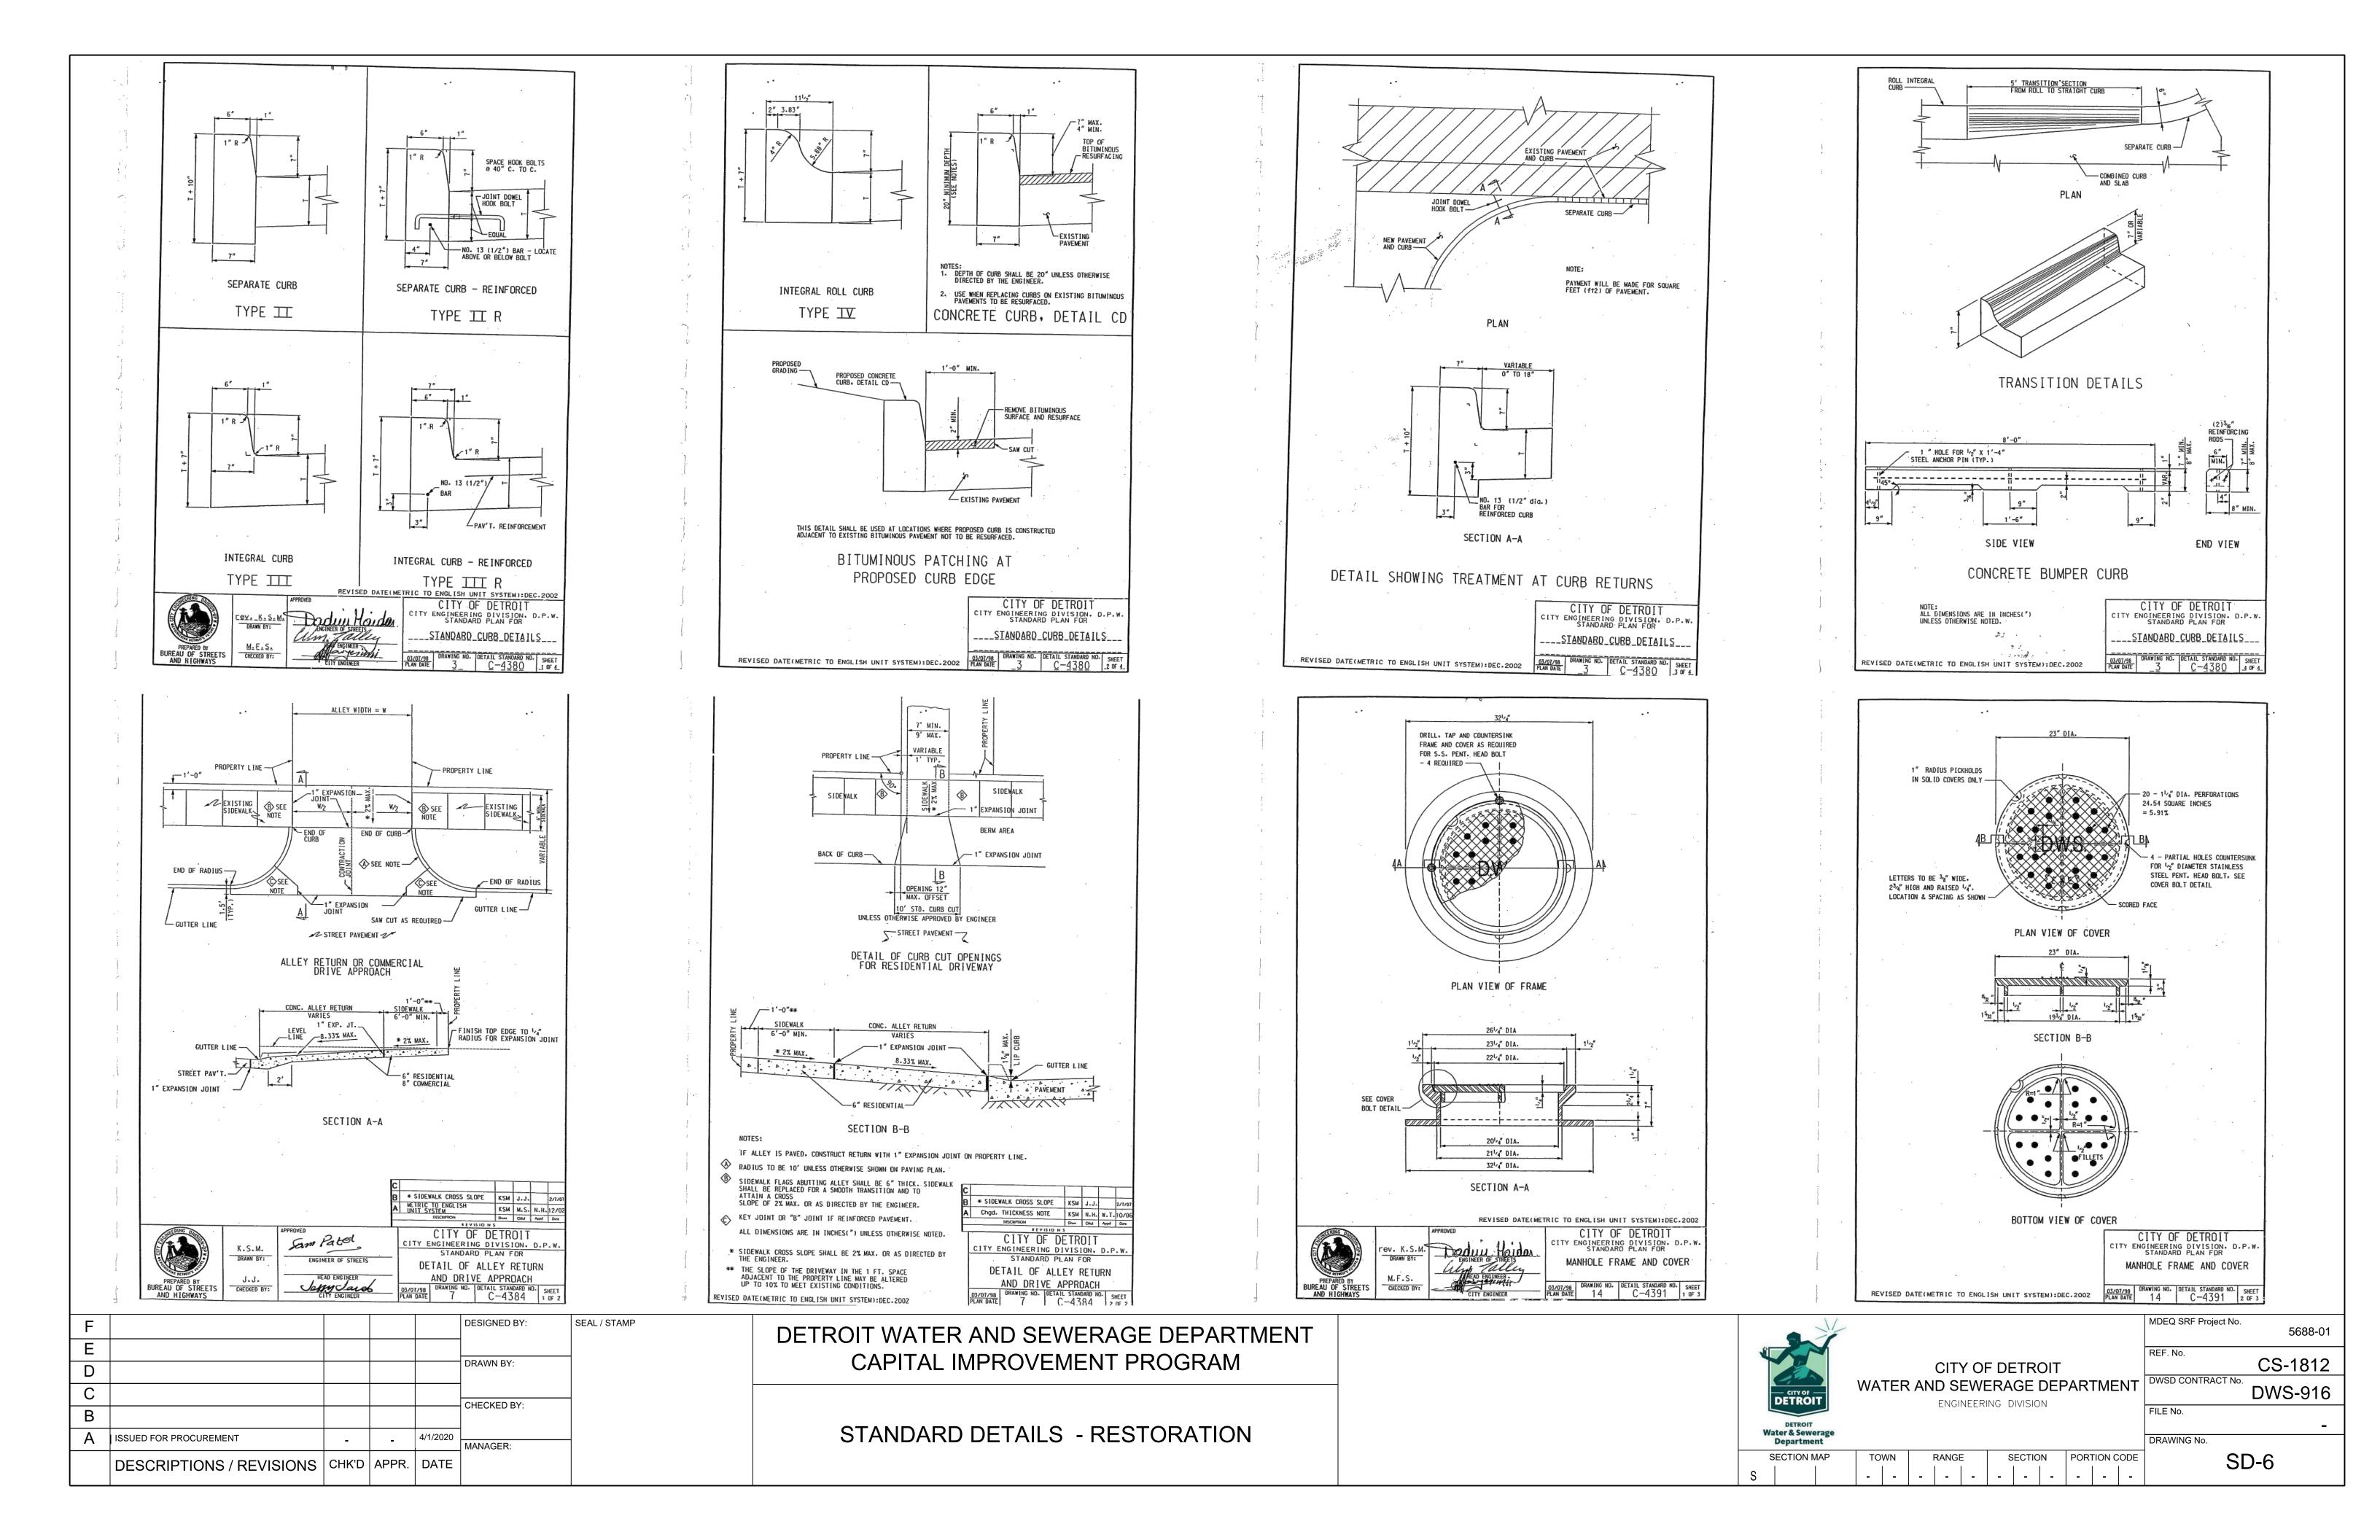


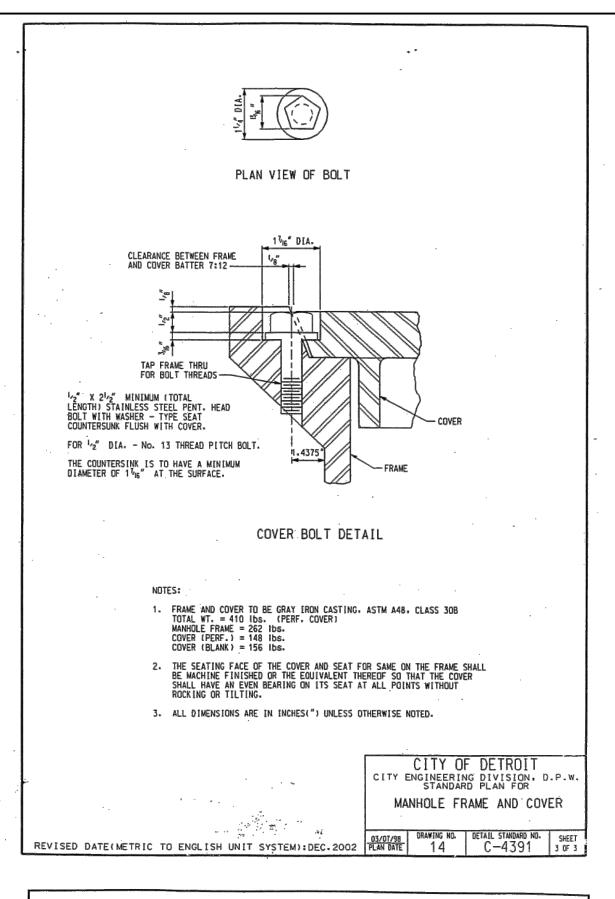


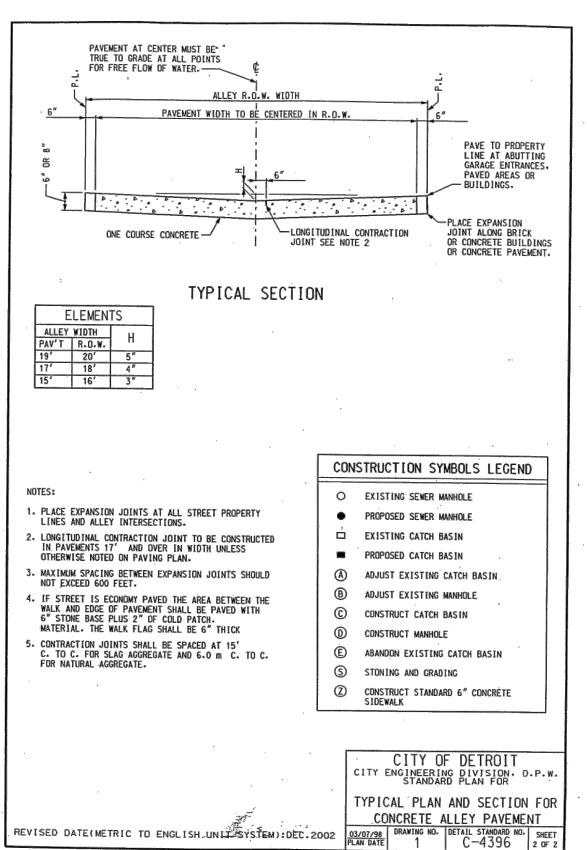


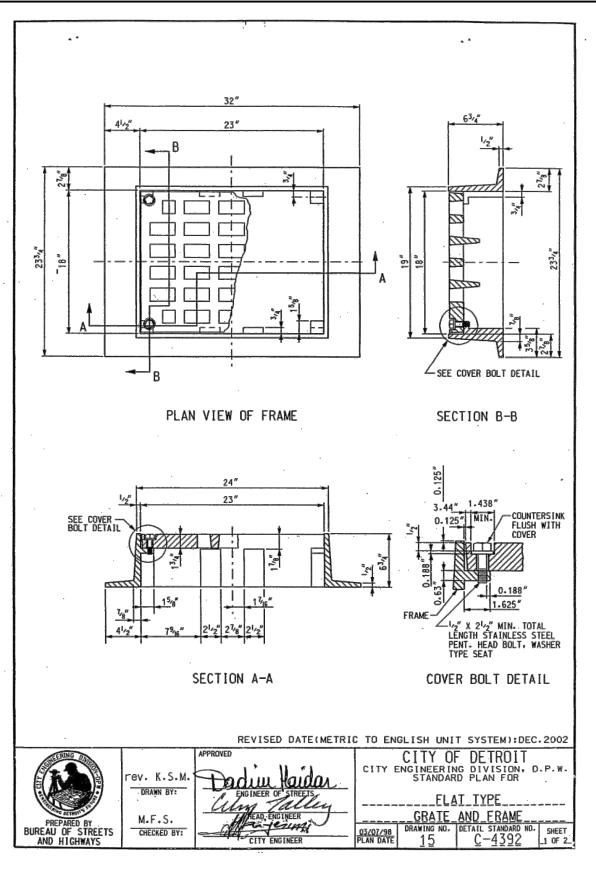


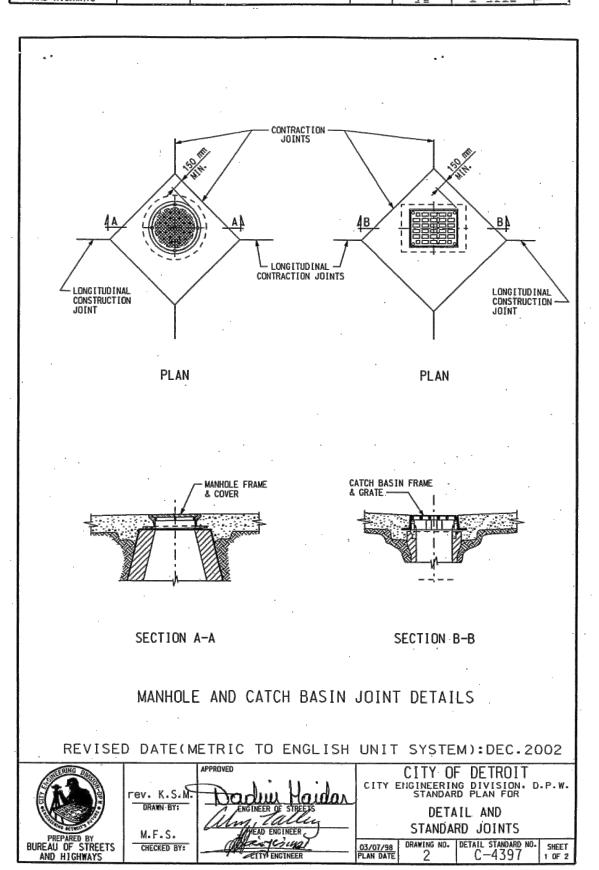


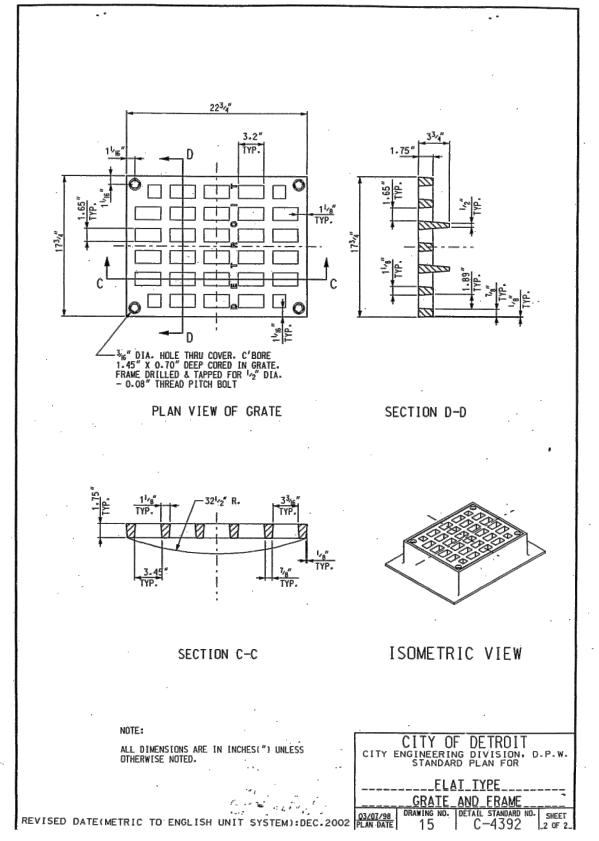

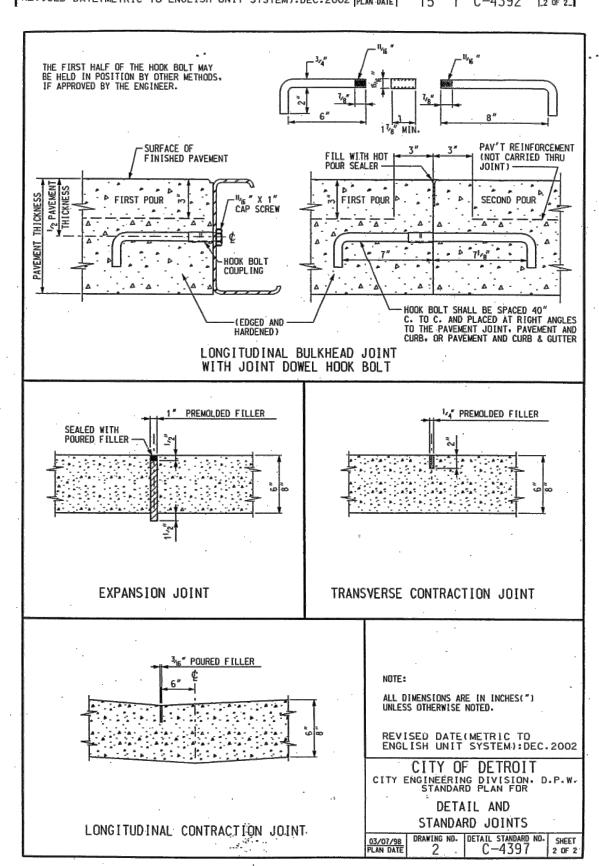

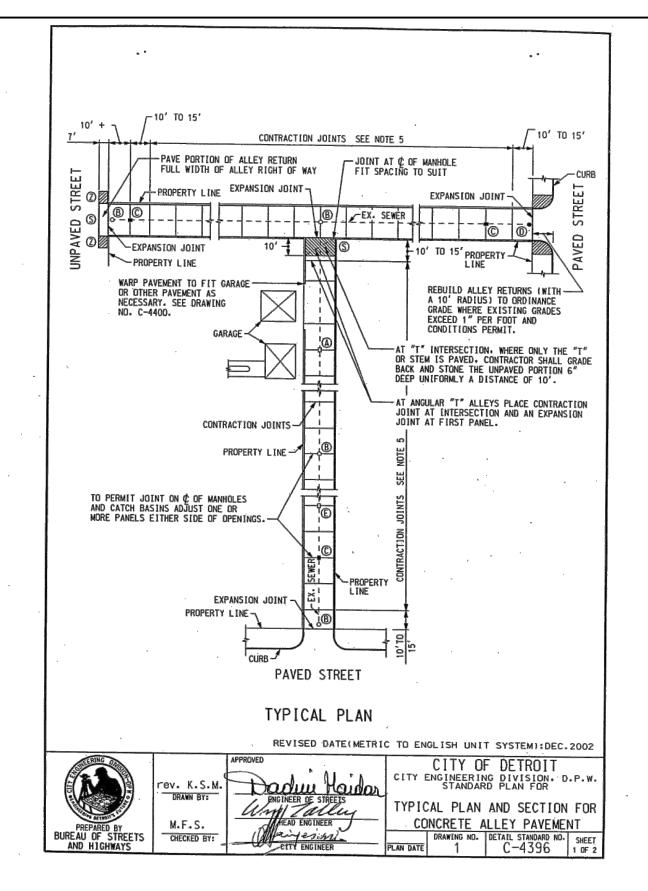

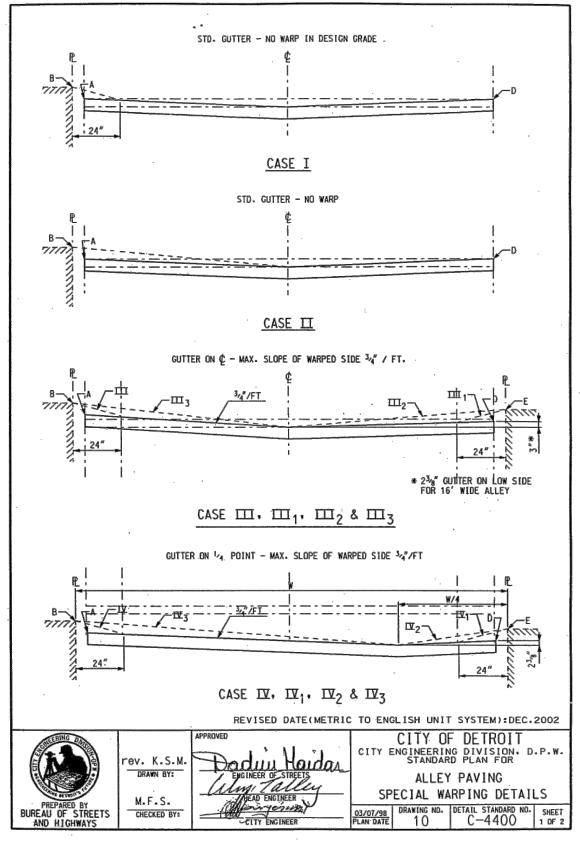

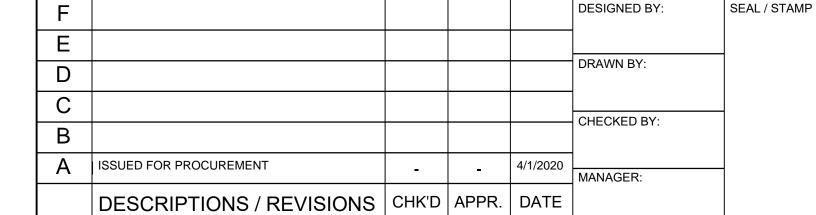

DETROIT WATER AND SEWERAGE DEPARTMENT CAPITAL IMPROVEMENT PROGRAM

STANDARD DETAILS - RESTORATION



CITY OF DETROIT
WATER AND SEWERAGE DEPARTMENT
ENGINEERING DIVISION
F


MDEQ SRF Project No. 5688-01


REF. No. CS-1812


T DWSD CONTRACT No. DWS-916


FILE No.
DRAWING No.

SD-7

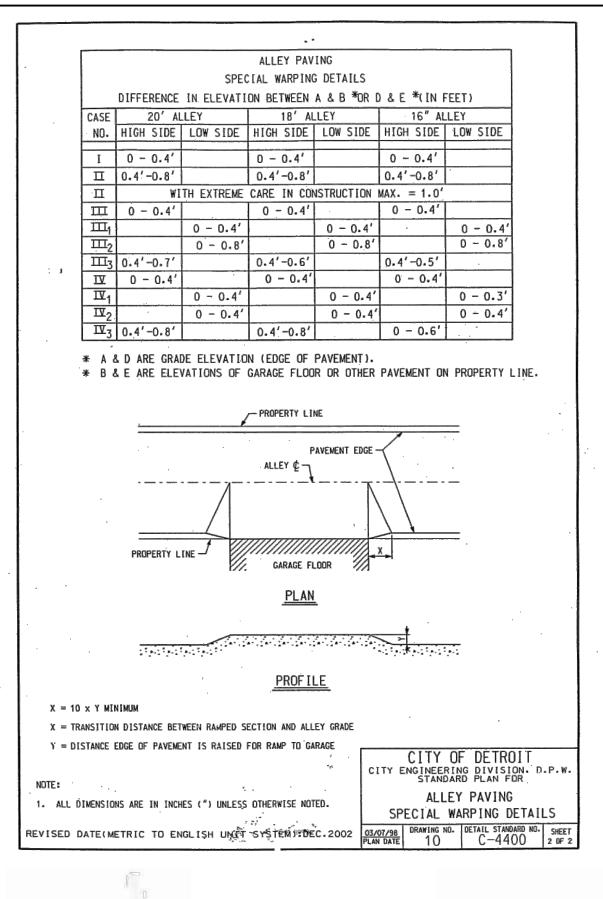


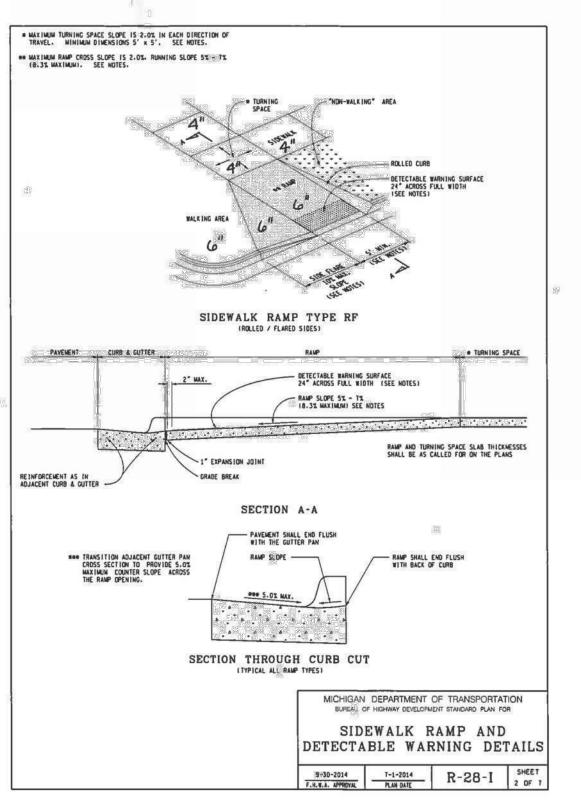


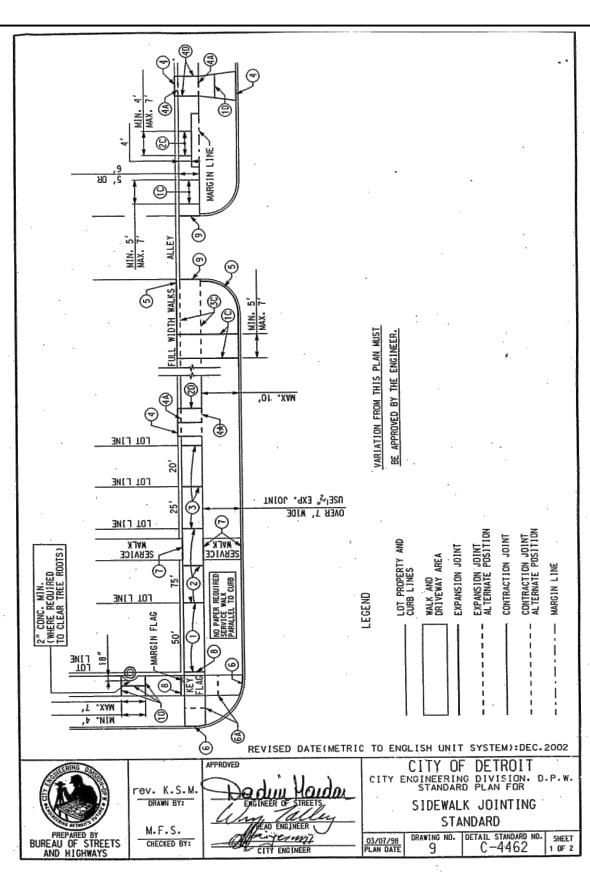


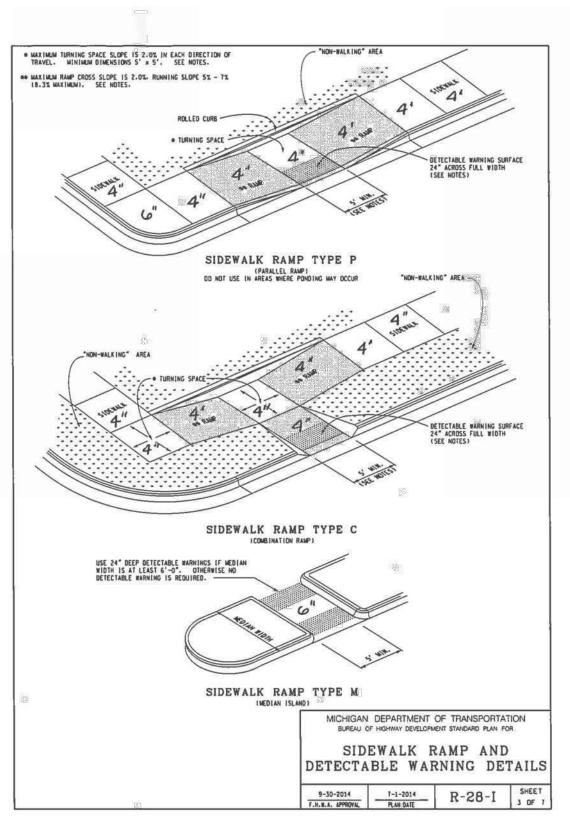


EXPANSION JOINTS ALL EXPANSION JOINT PAPER SHALL EXTEND 1" BELOW THE BOTTOM OF THE THINNER OF ADJOINING PAVEMENT SECTIONS. PLACE '2" PAPER EXPANSION JOINTS AT LOT LINES WHEN LOT LINES ARE BETWEEN 25' AND 50' APART. PLACE ADDITIONAL '2" PAPER EXPANSION JOINTS SO THAT THE DISTANCE BETWEEN JOINTS DOES NOT EXCEED 15.2 m. WHEN LOT LINES ARE OVER PLACE 1/2" PAPER EXPANSION JOINTS AT EVERY SECOND LOT LINE AND CONTRACTION JOINT AT INTERVENING LOT LINE WHEN LOT LINES ARE LESS THAN 25' APART. PLACE 1" PAPER EXPANSION JOINTS AT CURB AND BUILDING OR PROPERTY LINE OR AT ALTERNATE POSITION (A) AS SHOWN FOR DRIVEWAY. PLACE 1" PAPER EXPANSION JOINTS AT CURB AND BUILDING OR PROPERTY LINE FOR FULL WIDTH SIDEWALK EXCEEDING 7' IN WIDTH. PLACE 1" PAPER EXPANSION JOINTS AT CURB CIRCLES OR AT ALTERNATE POSITION (A) AS SHOWN. PLACE 1" PAPER EXPANSION JOINTS AT INTERSECTIONS OF SERVICE WALKS AND SIDEWALKS AND SERVICE WALKS AND CURBS. 8 PLACE 1" PAPER EXPANSION JOINTS AT MARGIN FLAGS AT CROSSWALKS. 9 PLACE 1" PAPER EXPANSION JOINTS AT ALLEY APRONS. 10 PLACE 12" PAPER EXPANSION JOINT BOTH SIDES OF SIDEWALK FLAG ABUTTING TREE AND ON CENTERLINE JOINT. CONTRACTION JOINTS PLACE CONTRACTION JOINTS AT INTERVALS OF NOT LESS THAN 5' NOR MORE THAN 7' ON WALKS 5' WIDE OR WIDER. INCLUDING FULL WIDTH WALKS. PLACE CONTRACTION JOINTS AT INTERVALS OF NOT LESS THAN 4' NOR MORE THAN 7' ON WALKS 4' WIDE. PLACE CONTRACTION JOINTS AT THE MARGIN LINE ON FULL WIDTH WALKS (OPTIONAL). DRIVEWAYS PLACE CONTRACTION JOINTS IN DRIVEWAYS SO THAT NO SLAB WILL EXCEED THE DIMENSIONS OF 15' BY 15' PLACE 1" PAPER EXPANSION JOINTS ON ALL SIDES OF COMMERCIAL DRIVES. PLACE CONSTRUCTION OR CONTRACTION JOINT ON CENTERLINE WHEN WIDTH OF DRIVEWAY EXCEEDS 15' PLACE '2" PAPER EXPANSION JOINTS ON BOTH SIDES OF RESIDENTIAL DRIVEWAYS. IF DRIVEWAY EDGE IS WITHIN 2' OF LOT LINE, PLACE THIS EXPANSION PAPER AT PROPERTY LINE. CITY OF DETROIT CITY ENGINEERING DIVISION, D.P.W. STANDARD PLAN FOR SIDEWALK JOINTING

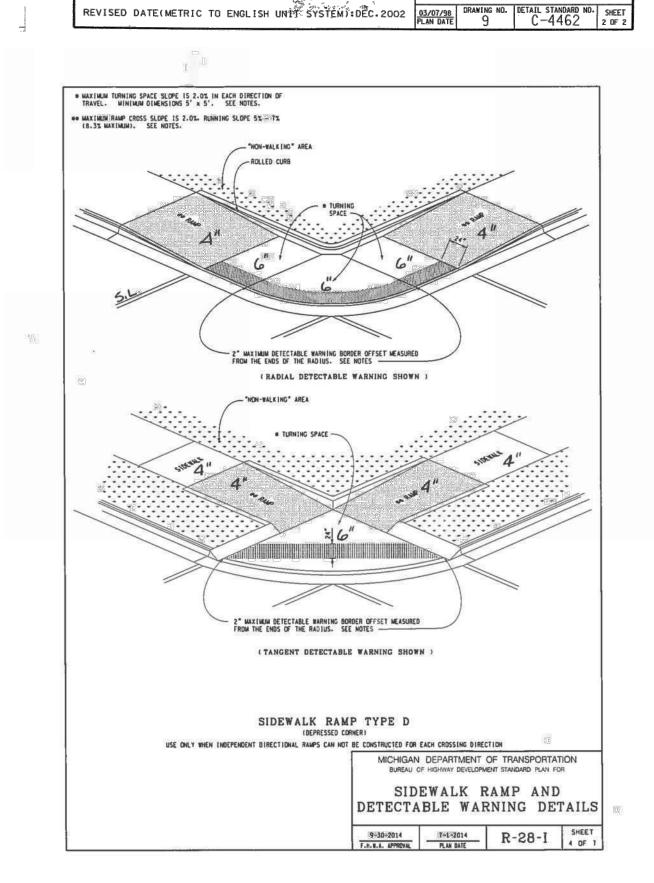

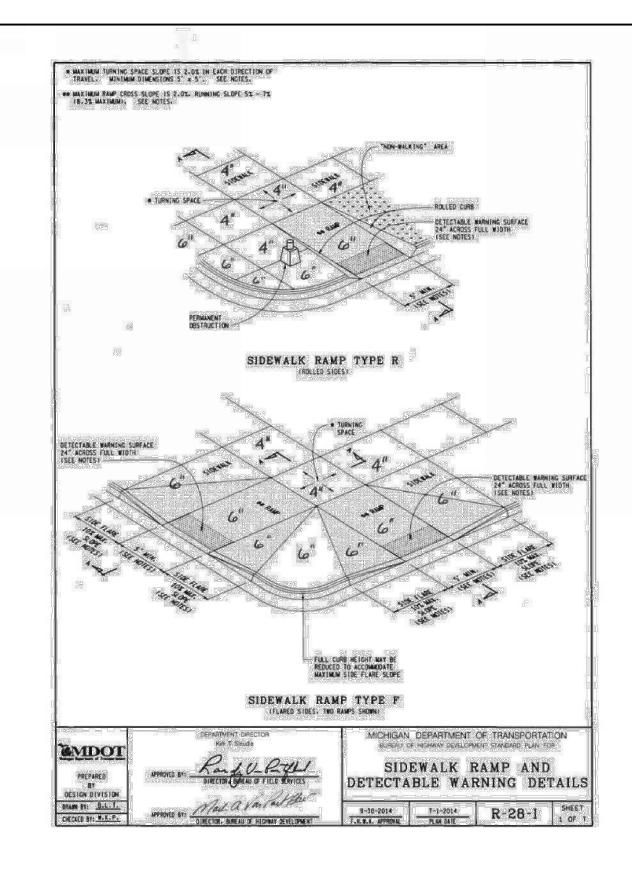

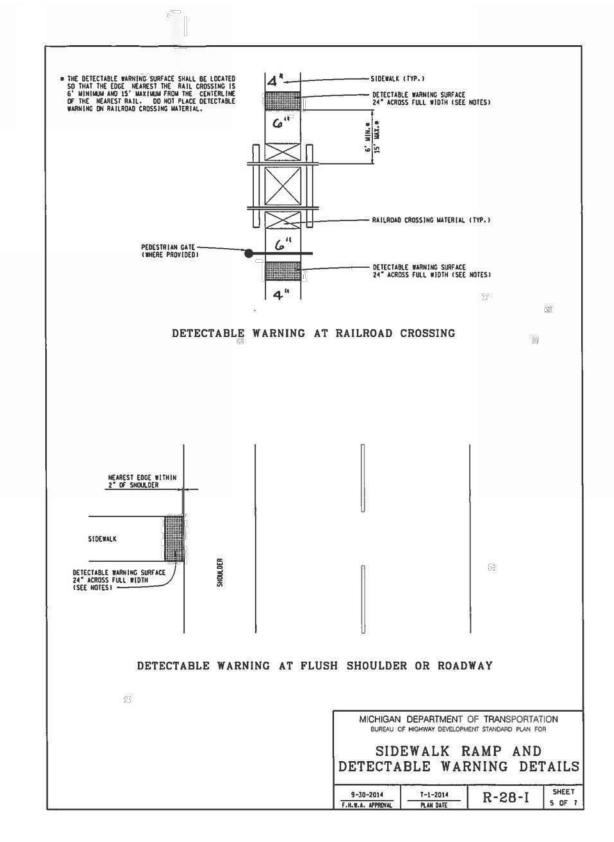

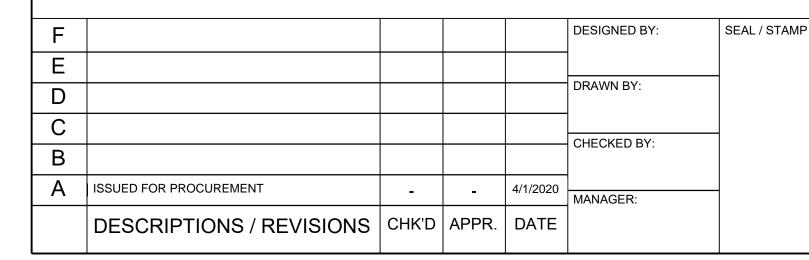



DETROIT WATER AND SEWERAGE DEPARTMENT CAPITAL IMPROVEMENT PROGRAM


STANDARD DETAILS - RESTORATION





5688-01

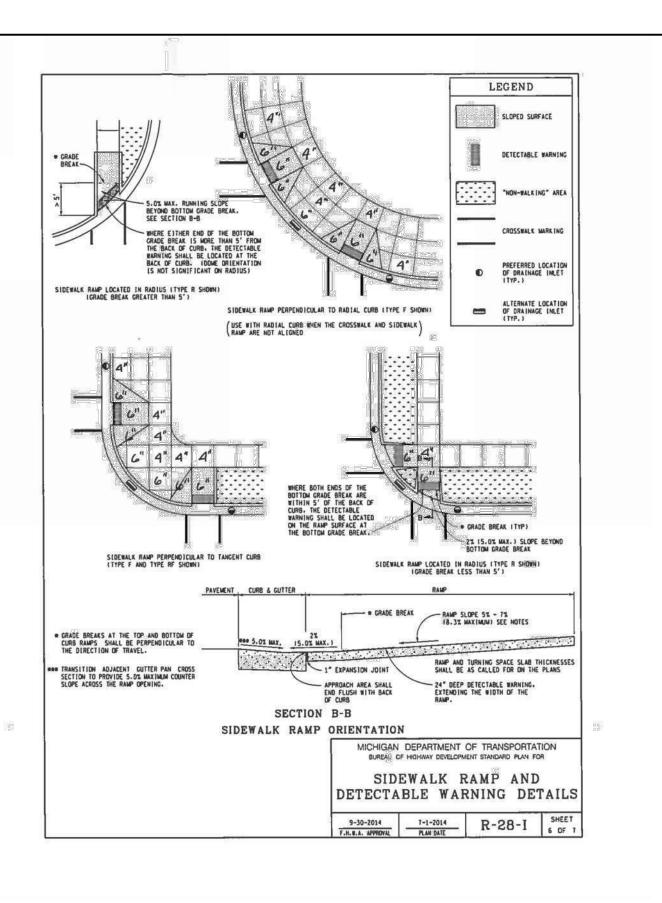


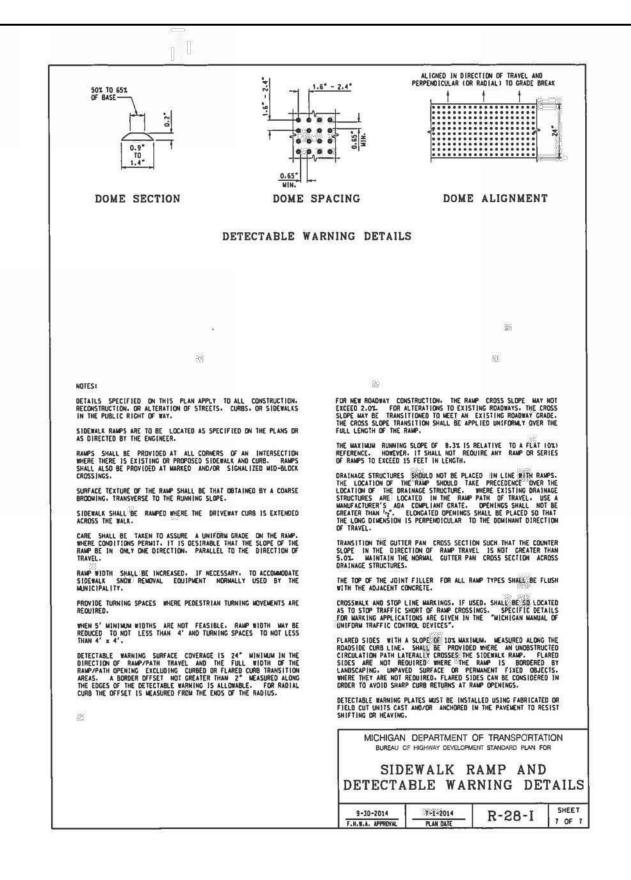


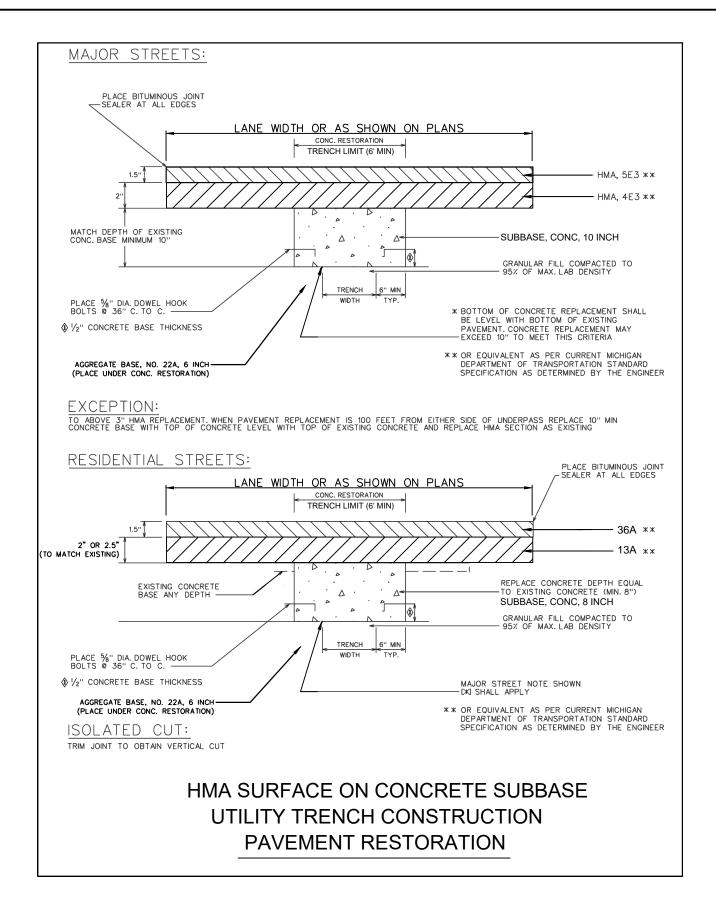

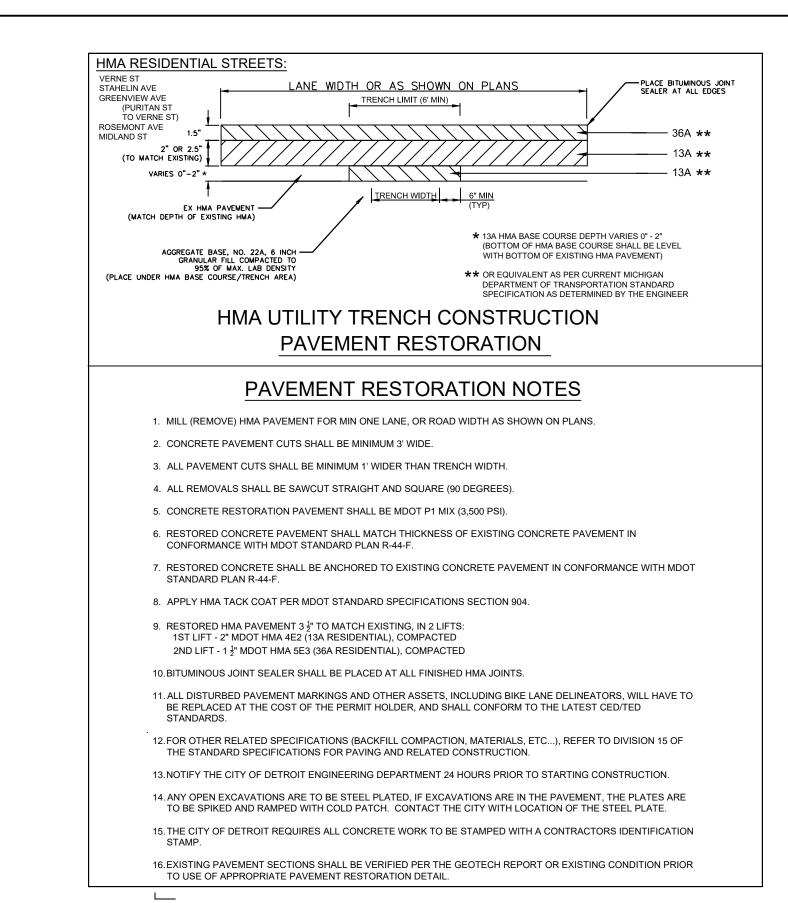

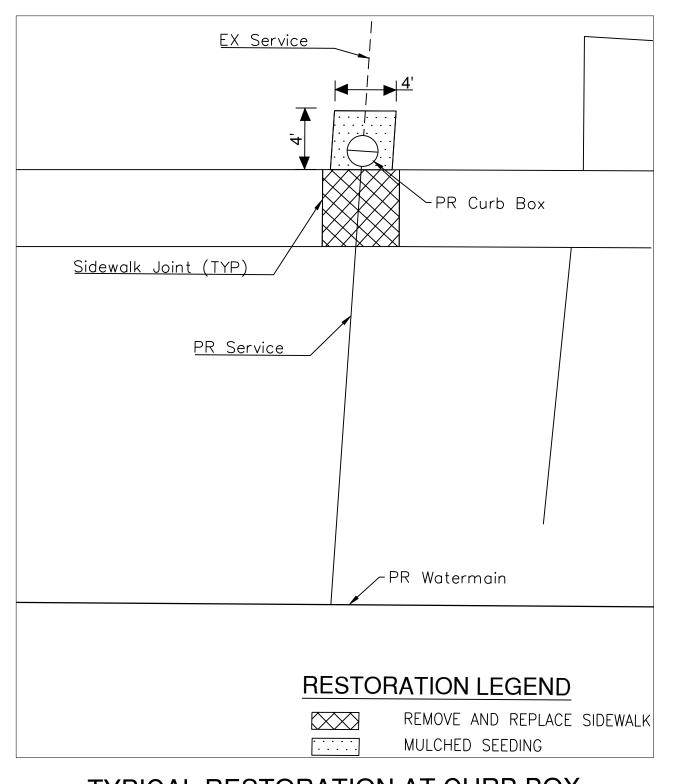

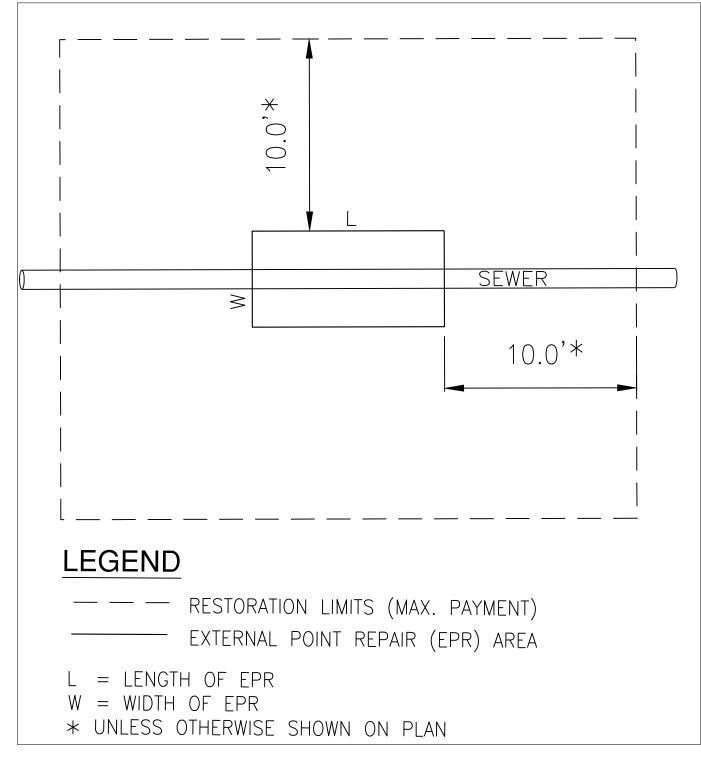

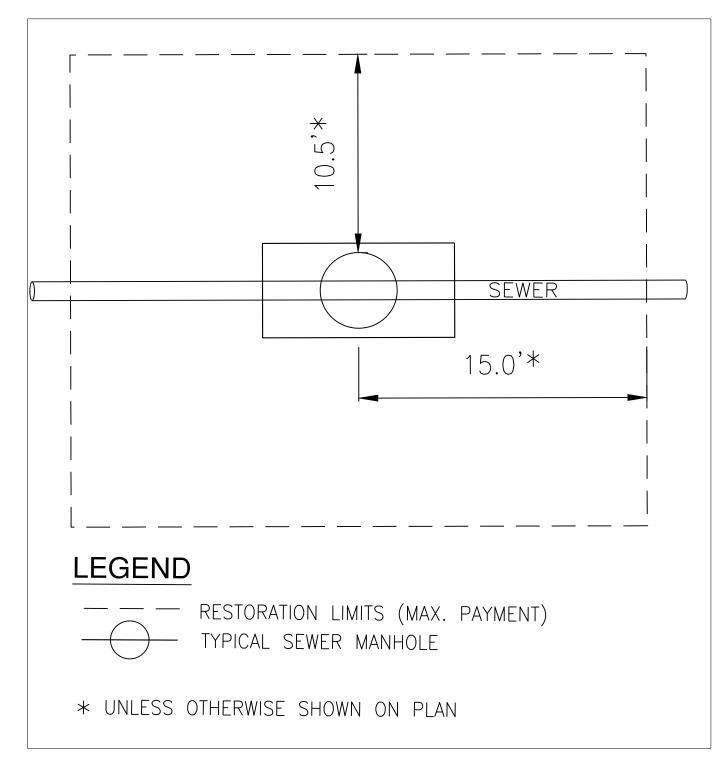

TYPICAL MANHOLE RESTORATION DETAIL

TYPICAL RESTORATION AT CURB BOX TYPICAL EPR RESTORATION DETAIL

F					DESIGNED BY:	SEAL / STAMP
Е						
D					DRAWN BY:	
С					CHECKED BY:	
В					CHECKED BY.	
Α	ISSUED FOR PROCUREMENT	-	-	4/1/2020	MANAGER:	
	DESCRIPTIONS / REVISIONS	CHK'D	APPR.	DATE		

DETROIT WATER AND SEWERAGE DEPARTMENT CAPITAL IMPROVEMENT PROGRAM

STANDARD DETAILS - RESTORATION

CITY OF DETROIT
WATER AND SEWERAGE DEPARTMENT
ENGINEERING DIVISION

CITYOF DETROIT
Water & Sewerage
Department

DETROIT
Water & Sewerage
Department

SECTION MAP
TOWN RANGE SECTION PORTION CODE

SD-9

MDEQ SRF Project No.

SEF. No.

CS-1812

DWSD CONTRACT No.

DWS-916


FILE No.

SD-9

LANDSCAPING NOTES

- 1. PLANTING TIMES AND PROCEDURES. SEE SEEDING AND PLANTS SPECIFICATIONS FOR PLANTING PROCEDURES AND ACCEPTABLE PLANTING TIMES.
- 2. SITE RESTORATION. RESTORE ALL DISTURBED AREAS WITH LAWN SEED PER SEEDING SPECIFICATION.
- 3. TREE PLANTING. REFER TO DETAIL G/70 AND PLANTS SPECIFICATION FOR TREE PLANTING REQUIREMENTS.
- 4. REPLACEMENT TREES. ALL TREES THAT WERE REMOVED FOR WATER AND SEWER WORK SHALL BE REPLACED ON A 1:1 BASIS. PLANT NEW TREES AS CLOSE TO ORIGINAL LOCATION AS POSSIBLE TREE SPECIES SHALL BE SUPPLIED IN THE QUANTITIES AND SIZES SPECIFIED IN THE PLANTING SCHEDULE BELOW. CONTRACTOR SHALL CHOOSE WHICH TREE SPECIES TO PLANT IN EACH REPLACEMENT TREE LOCATION, MAKING SURE THAT PLANTING CONDITIONS COMPLY WITH THE NOTES STATED IN THE PLANTING SCHEDULE BELOW.

PLANTING SCHEDULE								
KEY	QTY	SCIENTIFIC NAME	COMMON NAME	SIZE	CONTAINER	NOTES		
PA	_	PLANTANUS X ACERIFOLIA 'BLOODGOOD'	LONDON BLOODGOOD PLANETREE	2" CAL.	B&B	SPECIES TO BE USED ONLY IN PLANTING STRIPS GREATER THAN OR EQUAL TO 8 FEET WIDE		
UA	_	ULMUS AMERICANA 'PRINCETON'	PRINCETON ELM	2" CAL.	B&B	SPECIES TO BE USED ONLY IN PLANTING STRIPS GREATER THAN OR EQUAL TO 8 FEET WIDE		
QB	_	QUERCUS BICOLOR	SWAMP WHITE OAK	2" CAL	B&B	SPECIES TO BE USED ONLY IN PLANTING STRIPS GREATER THAN OR EQUAL TO 8 FEET WIDE		
QS	_	QUERCUS SCHUMARDII	SHUMARD OAK	2" CAL	B&B	SPECIES TO BE USED ONLY IN PLANTING STRIPS GREATER THAN OR EQUAL TO 8 FEET WIDE		
AR	_	ACER RUBRUM 'RED SUNSET'	RED SUNSET MAPLE	2" CAL	B&B	SPECIES TO BE USED ONLY IN PLANTING STRIPS GREATER THAN OR EQUAL TO 8 FEET WIDE		
TA	_	TILIA AMERICANA	BASSWOOD	2" CAL	B&B	SPECIES TO BE USED ONLY IN PLANTING STRIPS GREATER THAN OR EQUAL TO 8 FEET WIDE		
ZS	_	ZELKOVA SERRATA 'GREEN VASE'	GREEN VASE ZELKOVA	2" CAL	B&B	SPECIES TO BE USED ONLY IN PLANTING STRIPS LESS THAN 8 FEET WIDE		
GTI	_	GLEDITSIA TRIACANTHOS INERMIS	THORNLESS HONEYLOCUST	2" CAL	B&B	SPECIES TO BE USED ONLY IN PLANTING STRIPS LESS THAN 8 FEET WIDE		
MC	_	MALUS X CENTZAN	CENTURION CRABAPPLE	2" CAL	B&B	SPECIES TO BE USED AT LOCATIONS WITHIN 10 FEET OF OVERHEAD POWER LINES		
AG	_	AMENANCHIER X GRANDFLORA 'AUTUMN BRILLIANCE'	AUTUMN BRILLIANCE SERVICEBERRY	2" CAL	B&B	SPECIES TO BE USED AT LOCATIONS WITHIN 10 FEET OF OVERHEAD POWER LINES		

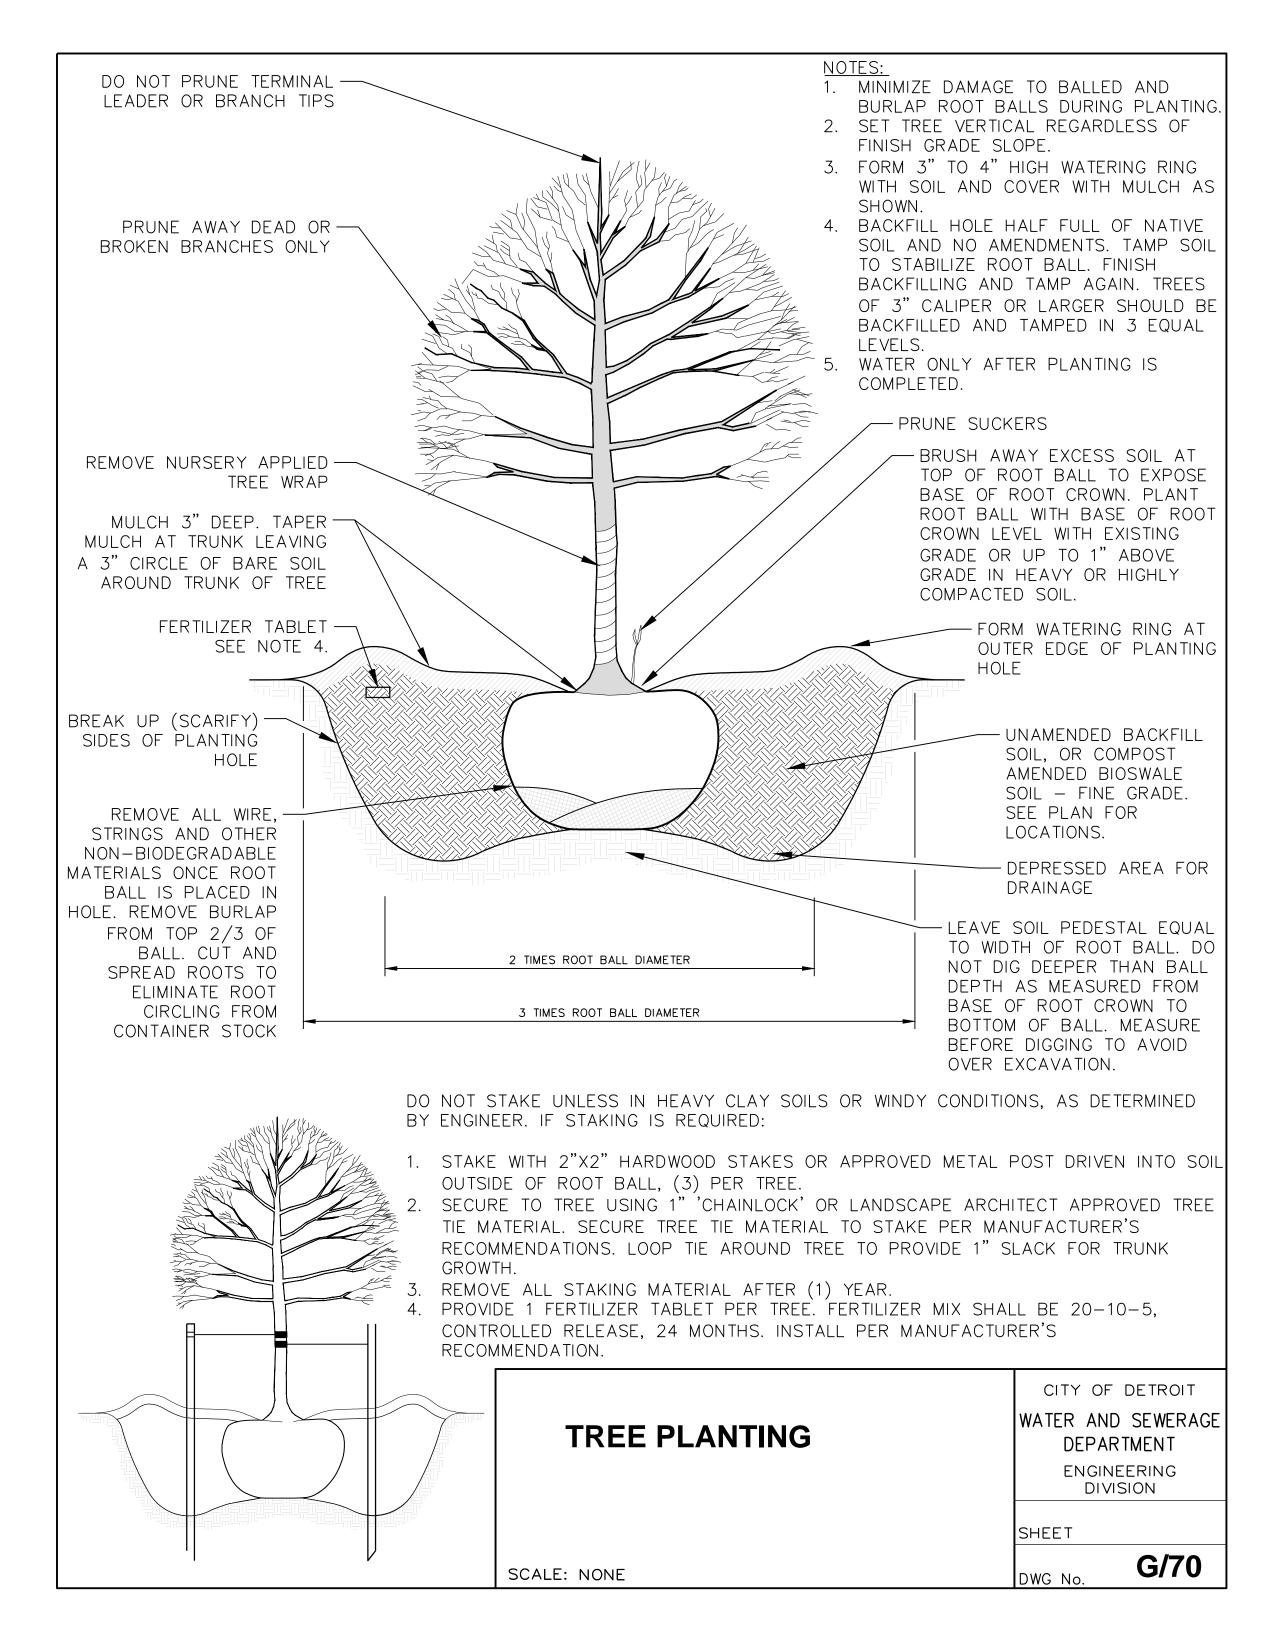



F	DETROIT WATER AND SEWERAGE DEPARTMENT	MDEQ SRF Project No. 5688-01
E	DETITION WITH LITTER OF THE PROBLEM	REF. No.
D	KK CALITAL IIVII NOVLIVILINI I NOGRAIVI	CITY OF DETROIT WATER AND SEWERAGE DEPARTMENT OWSD CONTRACT No. DIVID: 04.6
C	CHECKED BY:	ENGINEERING DIVISION DWS-916 FILE No.
Δ ISSUED FOR PROCUREMENT 4/1/202	RESTORATION TREE PLANTING SCHEDULE	DETROIT Water & Sewerage
A 1866EB FORT ROOMERT 4/1/202	MANAGER: AND DETAIL	Department SECTION MAP TOWN RANGE SECTION PORTION CODE SD-10
DESCRIPTIONS / REVISIONS CHK'D APPR. DATE	E BG	S